

**PRELIMINARY DEVELOPMENT AGREEMENT BETWEEN THE NORTH TEXAS
MUNICIPAL WATER DISTRICT AND BD ACQUISITIONS, LLC.**

This Preliminary Development Agreement (“Agreement”) is entered into this ____ day of September, 2024 (the “Effective Date”) by and between North Texas Municipal Water District (“NTMWD”), a wholesale water and wastewater provider that owns and operates Bois d’Arc Lake (the “Lake”) in Fannin County, Texas, and BD Acquisitions, LLC (“Developer”) seeking to develop approximately 123.79 acres for The Peninsula and Approximately 114.23 acres for The Shores At The Peninsula of property adjacent to the Lake (the “Property”) (collectively “Party” or “Parties”).

RECITALS

WHEREAS, the Parties are authorized to enter into this Agreement pursuant to Chapter 62, Acts of the 52nd Legislature, 1951 (Article 8280-141, Vernon’s Texas Civil Statutes) and other applicable laws;

WHEREAS, Developer owns the Property and plans to construct facilities and enter into agreements affecting the Property before the Property ultimately transferred to The Peninsula & Shores POA (the “Association”);

WHEREAS, Developer intends to develop the Property as a master-planned community for residential and recreational use (the “Development”);

WHEREAS, Developer plans to transfer the common areas of the Development identified in **Exhibit A** to the Association after the Developer has completed the construction of the improvements and facilities on the Property;

WHEREAS, the Association’s covenants, conditions, and restrictions for the Development are attached hereto as **Exhibit A** (“CC&Rs”);

WHEREAS, control of the Association will transfer to individual lot owners after the Control Transfer Date as stated in the CC&Rs; and all construction of the improvements and the Project (defined below) has been completed;

WHEREAS, the Development is adjacent to the Lake that is owned and operated by NTMWD;

WHEREAS, NTMWD owns the property below the 541 feet mean sea level (“MSL”) of the Lake and owns a Permanent Flowage and Flood Easement (the “Easement”) located between the 541 MSL and 545 MSL elevations across the Property (the “Shoreline”);

WHEREAS, as part of the Development, Developer seeks to make certain improvements to the Shoreline such as community docks and pathways as described in **Exhibit A** (the “Project”);

WHEREAS, before the Project proceeds, Developer must obtain authorization for the Project from NTMWD, as the owner and the Easement holder of the Shoreline; and

WHEREAS, the Parties seek to enter into an agreement to authorize the Project and effect the transfer of the Project to the Association.

THEREFORE, for good and valuable consideration, the receipt and sufficiency of which are hereby acknowledged, including the agreements set forth below, the Parties agree as follows:

AGREEMENT

1. **PURPOSE.** The purpose of the Agreement is to establish a preliminary development agreement for Developer to begin construction of the Project contingent upon the Association and Developer subsequently entering into a Shoreline Lease and Use Agreement with NTMWD, as further provided herein, and enforcing the CC&Rs.
2. **EFFECTIVE DATE.** This Agreement is effective as of the date first written above.
3. **PROJECT ACTIVITIES.** All Project activities identified in **Exhibit A** may not begin until the following conditions occur: (1) the Developer and its contractors meet with NTMWD to obtain approval to commence work on the Project activities in **Exhibit A**; and (2) NTMWD approves of the Project activities and issues Developer written authorization to work on the Project activities. Any deviation from the Project activities identified in **Exhibit A** require prior written approval by NTMWD after Developer submits a request to NTMWD for a deviation in writing. NTMWD has forty-five (45) days to review any deviation request and respond to the request from Developer. Anything not expressly authorized in writing by NTMWD as a Project activity or an approved deviation from a Project activity is expressly prohibited.
4. **PROJECT ABANDONMENT.** Abandonment of the Project occurs in either of the following situations: (1) failure to maintain the Project within the terms of the Agreement; or (2) failure to comply with Sections 6 and 7 of the Agreement ("Abandonment"). In the event of Abandonment of the Project, Developer shall be required to remove any improvements associated with the Project and restore the Shoreline to the satisfaction of NTMWD within thirty (30) days of receiving written notice from NTMWD requiring removal and restoration. In the event Developer shall fail to remove said improvements associated with the Project and restore the Shoreline, NTMWD shall have the option to take over the improvements without compensation to Developer, or to remove the improvements and perform the restoration at the expense of Developer, and Developer shall have no claim against NTMWD or its officers or agents for such action and no refund by NTMWD of any fee theretofore paid shall be made. Developer shall reimburse NTMWD for any and all costs associated with NTMWD's removal of improvements and restoration within thirty (30) days of NTMWD's request for reimbursement.
5. **DEADLINE FOR COMPLETION.** The deadline for completion of the Project is one year from the latest date of NTMWD's notices to proceed to Developer as provided in

Sections 3 and 4. If the Project is not complete by the one-year deadline, NTMWD has the authority to remove any improvements from the Property and terminate this Agreement effective immediately.

6. **EXTENSION OF DEADLINE FOR COMPLETION.** At NTMWD's sole discretion, the deadline for completion may be extended. For such an extension to be considered, Developer must submit a written extension request to NTMWD at least thirty (30) days before the expiration of the deadline for completion. NTMWD has thirty (30) days to grant or deny Developer's extension request.
7. **DREDGING, EXCAVATION, AND REGRADING ACTIVITIES.** Developer is responsible for notifying NTMWD and obtaining written authorization from NTMWD before every individual dredging, excavation, or regrading project commences on the Shoreline. Any activities are limited to those approved activities included in **Exhibit A**. Notification includes as follows: (1) written acknowledgment that Developer has complied with all applicable local, state, and federal laws and regulations; (2) the estimated start date and end date for the dredging, excavation, or regrading activity; (3) a point of contact and contact information for every dredging, excavation, or regrading activity; and (4) a description of the specifications and construction methods to be employed during the dredging, excavation, or regrading activity. NTMWD has the authority to reject any proposed construction methods proposed by Developer for the Project.
8. **ASSOCIATION TO SIGN SHORELINE LEASE AND USE AGREEMENT.** Developer agrees to include the Shoreline Lease and Use Agreement for the Association's signature during the transfer of assets, including but not limited to the transfer of all real property, personal property, fixtures and any other improvements on the Shoreline, from Developer to the Association (the "Transfer"). The Shoreline Lease and Use Agreement is attached as **Exhibit B** which may be revised by NTMWD in its sole discretion. Any revised version of the Shoreline Lease and Use Agreement included in **Exhibit B** shall be substantially similar to the version included in **Exhibit B**. Developer agrees to include a provision in the agreement(s) regarding the Transfer from Developer to the Association that requires the Association and the Developer to execute the Shoreline Lease and Use Agreement simultaneously at the time of execution of the agreement(s) regarding the Transfer. Developer is solely responsible for paying any fees required under the Bois d'Arc Lake Shoreline Management Plan ("SMP"), including but not limited to application fees for the Shoreline Lease and Use Agreement.
9. **FINANCIAL ASSURANCES.** Developer, at its own expense, shall procure and maintain for the duration of the design and construction phase of the Project, a performance bond in an amount of not less than \$1,899,500 for construction of the Project (the "Performance Bond"). The amount covered must be sufficient to cover the entire cost of the Project, and cover the cost needed to remove any Project activities on the Shoreline and restore the Shoreline to its original condition in the event of Abandonment of the Project. Developer must maintain the Performance Bond until all construction of the improvements and the Project has been completed. The Performance Bond shall be on forms reasonably acceptable to NTMWD. The Performance Bond shall be executed by a surety company

authorized to do business in the State of Texas and listed in the current Federal Department of Treasury Circular 570. Developer shall provide evidence of the Performance Bond within ten (10) days following the Effective Date.

10. **OPERATION, MAINTENANCE, REPAIR, & REPLACEMENT.** The operation, maintenance, repair, or replacement of the Project authorized by this Agreement shall be performed at no cost or expense to NTMWD and subject to the express written approval of NTMWD. Anything not expressly authorized in writing by NTMWD as a Project activity or an approved deviation from a Project activity is expressly prohibited. Upon the completion of any of such operation, maintenance, repair, or replacement, Developer shall immediately restore the Shoreline to the satisfaction of NTMWD. The use and occupation of the Shoreline for the purposes herein granted shall be subject to NTMWD's property ownership rights, the policies as set forth in the SMP, and to all applicable federal, state, and local laws and regulations. If the Project is removed for storage or extensive maintenance, NTMWD may require portions of the Project be removed from the Shoreline. Further, Developer agrees to operate and maintain the Project and/or use in a manner so as to provide safety, minimize any adverse impact on fish and wildlife habitat, and natural, environmental, or cultural resource values and in a manner so as to minimize the degradation of water quality.
11. **IMPROVEMENT STANDARDS.** Unless otherwise authorized in Sections 3 and 4 of this Agreement, docks and other permitted improvements must conform to the standards found in the SMP and **Exhibit A**. The standards address electrical service and lighting, signage, improvement size and length, improvement location and spacing, orientation of the improvement to the shoreline, improvement maintenance, and other features and amenities as described in the SMP. Any deviation from the SMP requirements will be considered a breach of this Agreement.
12. **FLOATS AND FLOTATION MATERIALS.** Floats and the flotation material for all docks shall be fabricated of materials manufactured for marine use and in accordance with the approved plans in **Exhibit A**. The float and its flotation material shall be one hundred (100) percent warranted for a minimum of eight (8) years against sinking, becoming waterlogged, cracking, peeling, fragmenting, or losing beads. All floats shall resist puncture and penetration and shall not be subject to damage by animals under normal conditions for the area. All floats and the flotation material used in them shall be fire resistant. The use of new or recycled plastic or metal drums or non-compartmentalized air containers for encasement or floats is prohibited.
13. **ANCHORING.** The gangways to boat docks, fishing piers, or any other overwater structure shall be securely attached to the shore in accordance with the approved plans by means of moorings that do not create tripping hazards along the shoreline or adversely affect the natural terrain or vegetation. Anchoring to vegetation is prohibited.
14. **AGREEMENT DISPLAY TAG.** The Agreement Display Tag shall be posted at the Project and/or on the land areas covered by the Agreement so that it can be visually checked with ease in accordance with instructions provided by NTMWD.

15. **CONSTRUCTION DISPLAY SIGN.** During the period in which Developer is building roads, docks, and amenities, including site preparation, Developer is required to post a construction display sign from NTMWD. This is required in addition to the required construction notification, and other notifications, permits, and authorizations required by local, state, and federal laws, including but not limited to, obtaining and posting notice of any required construction stormwater general permit.
16. **PROHIBITED ITEMS.** Treated landscape timbers or the storage, transfer, or use of hydrocarbons or other petrochemical products, paint, pesticides, herbicides, or any other toxic or hazardous materials are not allowed on the Shoreline or the Lake.
17. **ELECTRICAL SAFETY AND COMPLIANCE.** Developer shall comply with all applicable federal, state, county, municipal laws, ordinances and regulations wherein the permitted facilities/activities are located, including, but not limited to, the provisions of the latest edition of the National Electrical Code (NEC). Failure to abide by these applicable laws and regulations may be cause for revocation of this Agreement.
18. **POLLUTION PREVENTION.** Within the limits of their respective legal powers, the Parties hereto shall protect the Shoreline against pollution of its air, ground, and water. Developer shall promptly comply with any laws, regulations, conditions, or instructions affecting the activity here authorized if and when issued by the Environmental Protection Agency ("EPA"), the United States Army Corps of Engineers ("USACE"), the Texas Commission on Environmental Quality ("TCEQ"), or any federal, state, or local governmental agency having jurisdiction to abate or prevent pollution. The disposal of any toxic or hazardous materials within the Shoreline is strictly prohibited. Such regulations, conditions, or instructions in effect or prescribed by the said EPA, USACE, TCEQ, or any federal, state, or local governmental agency are hereby made a condition of this Agreement. Developer shall not discharge waste or effluent from the Shoreline in such a manner that the discharge will contaminate streams or other bodies of water or otherwise become a public nuisance.
19. **PESTICIDE AND HERBICIDES.** The use of any pesticides or herbicides within the Shoreline and the Lake shall be in conformance with all applicable federal, state, and local laws and regulations. Developer must obtain approval in writing from NTMWD before any pesticides or herbicides are applied to the Shoreline and the Lake.
20. **ENVIRONMENTAL IMPACT.** Developer will use all reasonable means available to protect the environment and natural resources, and where damage nonetheless occurs arising from Developer's activities, Developer shall be required to restore the damaged resources.
21. **TIMBER CLEARING.** Unless expressly authorized under Sections 3 and 4 of this Agreement, no timber above the 534 MSL contour shall be cleared. Standing timber below the 534 MSL contour may be cleared only if approved through this Agreement after Developer submits a timber clearing proposal to NTMWD. Developer shall provide

documentation of coordination with the USACE in accordance with the procedures described in the SMP. Such USACE coordination shall only occur after NTMWD has reviewed the timber clearing proposal and provided direction to engage in such coordination. Any timber clearing authorized under this Agreement must be in compliance with any required USACE approvals, authorizations, or permits. Timber clearing shall be approved by NTMWD in writing and shall be in accordance with the Clean Water Act Section 404 Permit for Bois d'Arc Lake as provided in the SMP. Timber clearing not approved by NTMWD in writing is prohibited and any prohibited timber clearing shall be considered a breach of this Agreement.

22. **AGREEMENT FEES.** Developer shall pay, in advance, to NTMWD, compensation in accordance with **Exhibit C**. Fees are subject to change upon renewal of the Agreement.
23. **DEVELOPER COMPLIANCE WITH LOCAL, STATE, AND FEDERAL LAWS AND REGULATIONS.** It is Developer's sole responsibility for ensuring its performance of this Agreement complies with all local, state, and federal regulations. NTMWD shall not be responsible for ensuring Developer's compliance with these laws and regulations.
24. **WAIVER OF ANY TAKINGS CLAIM.** Developer **WAIVES ANY CLAIM IT MAY NOW OR IN THE FUTURE HAVE AGAINST NTMWD FOR A STATE OR FEDERAL "TAKINGS" or "INVERSE CONDEMNATION"** of either the Project or the portion of the Shoreline on which the Project is located resulting from Lake levels being inconstant or from flooding, high water drought, or similar occurrence, even if any of these occurrences is caused or alleged to be caused, in whole or in part, by NTMWD, whether through NTMWD's negligence or otherwise.
25. **INDEMNIFICATION.** NTMWD shall have no liability whatsoever, either to Developer, Developer's successors, assigns, guest invitees or any other third party, for property damage to Developer's Project or the contents thereof, caused by inundation or flooding of the property or the effect of drought, **EVEN IF CAUSED BY NTMWD'S NEGLIGENCE.** NTMWD shall not be liable to Developer or Developer's contractors, subcontractors, guests, visitors, invitees or to any other person whomsoever, for any injury to person or damage to property on or about the Property due to **ANY CAUSE WHATSOEVER INCLUDING WITHOUT LIMITATION, INUNDATION OR FLOODING OF THE PROPERTY OR THE EFFECTS OF DROUGHT,** and Developer agrees to indemnify NTMWD and hold it harmless from any loss, expenses, or claims including attorney's fees, arising out of any such damage or injury, **INCLUDING INJURY TO PERSON OR DAMAGE TO PROPERTY THE SOLE OR CONTRIBUTING CAUSE OF WHICH IS THE NEGLIGENCE OF NTMWD.** If any action or proceeding is brought against NTMWD by reason of any such claim, Developer, upon notice from NTMWD, will defend such action or proceeding with counsel acceptable to NTMWD.
26. **RELEASE & ASSUMPTION OF RISK.** Developer acknowledges that Bois d'Arc Lake is not a "constant level" or "controlled level" lake and is **SUBJECT TO DROUGHT OR FLOODING WITHOUT WARNING.** Developer acknowledges and agrees that the

Property is being improved upon “**AS-IS, WHERE-IS,**” with all defects, whether known or unknown. Developer recognizes the risk inherent in constructing improvements in close proximity to, and over, the Lake because of the risks associated with flooding, high water, and drought conditions. These risks include, but are not limited to, lake level fluctuations resulting in improvements, such as docks, being completely unusable during flood or drought conditions, which can extend over months or years, as it relates to multi-year drought conditions. As a condition of, and in consideration for, NTMWD’s entering into this Agreement, as between NTMWD and Developer, Developer **AGREES TO ASSUME ALL RISK** of destruction of or damage to any improvements and the property of Developer or third parties located on the Property and to assume all risk of bodily injury or death to any person on the Property associated with the Project resulting from any cause. As part of the assumption of risk, Developer, for itself and its heirs and assigns, **EXPRESSLY RELEASES NTMWD FROM ALL LOSS, COSTS, AND LIABILITY FOR (1) DAMAGE OR DESTRUCTION TO ANY OF ITS PROPERTY LOCATED ON OR AT THE PROPERTY RESULTING FROM ANY CAUSE AND (2) BODILY INJURY OR DEATH TO DEVELOPER OR ANY CONTRACTOR OR SUBCONTRACTOR OR OTHER PERSON AT THE PROPERTY.**

27. **NO GOODS OR SERVICES PROVIDED TO NTMWD.** The Parties agree that pursuant to this Agreement Developer is not providing any “goods or services” to NTMWD and this Agreement is not a contract subject to Chapter 271, Subchapter I of the Texas Local Government Code because no “goods or services,” as such terms have been interpreted by courts in the State of Texas, are provided by Developer to NTMWD pursuant to this Agreement.
28. **DAMAGE TO SHORELINE.** Developer shall be liable for any and all damage that may be caused to the Shoreline by the activities of Developer, or individual property owners of the Development, under this Agreement and shall exercise due diligence in the protection of all property located on the Property against fire or damage from any and all other causes. Any property of NTMWD damaged or destroyed by Developer, or individual property owners of the Development, incident to the exercise of the privileges herein granted shall be promptly repaired or replaced by Developer or the individual property owner of the Development to a condition satisfactory to NTMWD, or at the election of NTMWD, reimbursement made therefore by Developer in an amount necessary to restore or replace the property to a condition satisfactory to NTMWD.
29. **NTMWD’s ACCESS TO SHORELINE.** The right is reserved to NTMWD, its officers, agents, and employees to enter upon the Shoreline at any time and for any purpose necessary or convenient in connection with NTMWD work, to make inspections, to remove any material, except property of Developer approved for use on the Shoreline, and/or to make any other use of the lands as may be necessary in connection with NTMWD purposes, and Developer shall have no claim for damages on account thereof against NTMWD or any officer, agent, or employee thereof. NTMWD’s authorized representative shall be allowed to cross the Property, as necessary, to inspect the Project. NTMWD will notify Developer of any deficiencies noted and will establish a schedule for their correction. No deviation or changes from approved plans for the Project will be allowed without prior

written approval of NTMWD. Any deviations from the Project must be approved in writing by NTMWD after Developer submits a request to NTMWD for a deviation in writing. NTMWD has forty-five (45) days to review and respond to the request from Developer. Notwithstanding the foregoing, if NTMWD determines during an inspection that a noncompliance issue concerns a significant imminent threat to the environment or public health, safety, and general welfare, NTMWD may take whatever action necessary within the authority of NTMWD to eliminate such threat, including but not limited to, requiring Developer to immediately address the noncompliance issue.

30. **LAKE AND SHORELINE ACCESS.** All watercraft must be launched from a NTMWD-approved ramp or a dock. This excludes non-motorized watercraft such as kayaks, canoes, and stand up paddle boards. Unless otherwise approved, neither Developer nor individual lot owner may build a boat ramp or use any of their property to launch a watercraft except as set forth herein.
31. **PROPERTY LINE AND SIDE YARD DELINEATION** For this Agreement, Developer will delineate the boundary line between NTMWD owned property and Developer's property in a visibly clear, but unobtrusive manner approved by NTMWD and in accordance with the SMP. Developer will also identify the intersection of the projected side yard line and the 534 MSL as depicted in the exhibit to this Agreement.
32. **SHORELINE MAINTENANCE.** NTMWD is under no obligation to Developer to maintain the Shoreline. Developer is responsible for maintaining the Shoreline in a clean and sanitary manner, including removing trash and other natural debris. Unless expressly authorized by this Agreement, Developer is responsible for acting in accordance with the SMP. Any materials and refuse from maintenance and repair activities are to be removed from the Shoreline and the Lake immediately upon completion of such activities.
33. **CULTURAL RESOURCES.** Developer shall not remove or disturb, or cause or permit to be removed or disturbed, any historical, archaeological, architectural, or other cultural artifacts, relics, remains, or objects of antiquity on NTMWD-owned property. In the event such items are discovered on NTMWD-owned property, Developer shall immediately notify NTMWD and protect the site and material from further disturbance until NTMWD authorizes any further activity.
34. **COMMERCIAL ACTIVITIES PROHIBITED.** No attempt shall be made by Developer to forbid the full and free use by the public of all waters adjacent to the Shoreline. No charge may be made for use by others of the Shoreline or the Lake nor shall commercial activities, including any form of advertising, be conducted thereon.
35. **COMPLIANCE WITH APPLICABLE LAWS AND REGULATIONS.** This Agreement is subject to all applicable federal and state laws and any applicable permits, ordinances, rules, orders, and regulations of any local, state or federal governmental authority having or asserting jurisdiction, including, but not limited to, the provisions of the latest edition of the National Electrical Code (NEC). Nothing contained herein shall be construed as a waiver of any right to question or contest any such law, ordinance, order,

rule, or regulation in any forum, having jurisdiction. This Agreement does not authorize any injury to private property or invasion of private rights or any infringement of local, state or federal laws or regulations, nor does it obviate the necessity of obtaining local, state, or federal assent required by law for the operation, use, maintenance, or repair of the Improvement and/or use.

36. **RULES AND REGULATIONS.** The Property shall be expressly subject to all rules and regulations promulgated by NTMWD for the construction, use, maintenance, and enjoyment of the Property, including without limitation, all regulations and requirements of NTMWD, now or hereafter enacted. By signing this Agreement, Developer specifically acknowledges that it has read the applicable requirements of the Bois d'Arc Lake Rules and Regulations, the SMP, and the Fannin County Zoning Regulations and agrees that Developer's use of the Property shall at all times be in compliance with such plans and regulations.
37. **TERMINATION OF AGREEMENT.** Before NTMWD may terminate the Agreement, NTMWD must send a notification to Developer informing Developer of NTMWD's grounds for termination of the Agreement and giving Developer sixty (60) days to address and cure such grounds for termination. If the time period to cure has passed without Developer taking the required curative action, NTMWD may mail a notice to terminate to Developer by certified letter. The termination of the Agreement is effective as of the date of the termination letter. Unless terminated earlier, the Agreement shall terminate upon the Association's execution of the Shoreline Land Use Agreement.
38. **REMEDIES.** It is not intended hereby to specify (and this Agreement shall not be considered as specifying) an exclusive remedy for any default, but all such other remedies, including terminations provided in Section 39, existing at law or in equity may be availed of by any Party hereto and shall be cumulative.
39. **NOTICE.** Unless otherwise provided herein, any notice, communication, request, reply or advice (herein severally and collectively, for convenience, called "Notice") herein provided or permitted to be given, made or accepted by any Party to any other Party must be in writing and may be given or be served by depositing the same in the United States mail postpaid and registered or certified and addressed to the Party to be notified, with return receipt requested, or by delivering the same to an officer of such Party, or by electronic mail, addressed to the Party to be notified at the email address provided below. Notice deposited in the mail in the manner described above shall be conclusively deemed to be effective, unless otherwise stated herein, from and after the expiration of three (3) days after it is so deposited. Notice given in any other manner shall be effective only if and when received by the Party to be notified. For the purposes of notice, the contact information of the Parties shall, until changed as hereinafter provided, be as follows:

If to Developer, to:

BD Acquisitions, LLC.
9827 Cogdill Rd. Suite # 1
Knoxville, TX 37932
912-223-4390
logue@llcinvest.com

If to NTMWD, to:

Jennafer P. Covington
Executive Director/General Manager
North Texas Municipal Water District
P.O. Box 2408
Wylie, Texas 75098
972-442-5405
jcovington@ntmwd.com

The Parties hereto shall have the right from time to time and at any time to change their respective contact information and each shall have the right to specify as its contact information any other contact information by at least fifteen (15) days' written notice to the other Party hereto.

40. **SEVERABILITY.** In case any one or more of the provisions contained in this Agreement shall for any reason be held to be invalid, illegal, or unenforceable in any respect, such invalidity, illegality, or unenforceability shall not affect any other provision thereof and this Agreement shall be considered as if such invalid, illegal, or unenforceable provision had never been contained in this Agreement.
41. **NO JOINT VENTURE.** It is acknowledged and agreed by the Parties that the terms hereof are not intended to and shall not be deemed to create any partnership or joint venture among the Parties. NTMWD, its past, present, and future officers, elected officials, employees and agents of NTMWD do not assume any responsibilities or liabilities to any third party in connection with the development of the project or the design, construction or operation of any portion of the Project.
42. **REPRESENTATIONS AND WARRANTIES.** Each Party represents and warrants to the other Party that (i) the Party has all requisite power and authority to perform its obligations under this Agreement; (ii) the execution, delivery, and performance of this Agreement has been duly authorized by all necessary action of the board of directors or other applicable governing body of the Party; (iii) this Agreement is a valid and binding obligation of the Party enforceable against the Party in accordance with its terms, except as the enforceability may be limited by applicable bankruptcy, insolvency or other law affecting creditors' rights generally, and by general equitable principles; and (iv) the execution, delivery, and performance of this Agreement by the Party does not, and will not: (A) violate the statute, charter, or other instrument pursuant to which the Party was created; (B) violate the Constitution of the State of Texas, or any other law, rule or regulation by which the Party is bound; (C) violate any judgment, writ, order, injunction, award, or decree of any court, arbitrator, administrative agency or other governmental authority which is binding upon the Party; or (D) result in a material breach, violation, or default under any indenture, mortgage, ordinance, bond resolution, contract, deed of trust, debenture, agreement, or other instrument to which the Party is a party.

43. **ENTIRE AGREEMENT – NO ORAL MODIFICATIONS.** This Agreement embodies the entire Agreement of the Parties, superseding all oral or written previous and contemporary agreements between the Parties relating to matters set forth in this Agreement. Except as otherwise provided elsewhere in this Agreement, this Agreement cannot be modified without a written supplemental agreement executed by both Parties.
44. **ASSIGNMENT.** Developer shall not assign this Agreement or any of its rights hereunder without first obtaining the express prior written agreement of NTMWD.
45. **NO THIRD-PARTY BENEFICIARIES.** Developer and NTMWD enter into this Agreement solely for the benefit of themselves and agree that nothing in this Agreement shall be construed to confer any right, privilege or benefit on any person or entity other than Developer and NTMWD.
46. **VENUE.** It is specifically agreed among the Parties to this Agreement that Fannin County, Texas, is the place of performance of this Agreement; and, in the event that any legal proceeding is brought to enforce this Agreement or any provision hereof, the same shall be brought in Fannin County, Texas.
47. **ADOPTION OF PREAMBLE AND EXHIBITS** All of the statements in the preamble and all of the exhibits of this Agreement are true and correct and are hereby incorporated into the body of this Agreement as though fully set forth in their entirety herein.
48. **VIOLATIONS AND PENALTIES.** Developer will be held accountable to the conditions outlined herein. If a violation is identified NTMWD will follow the steps outlined below:
- First Notice:* NTMWD will generally issue a written warning notifying Developer of the violation, outlining actions to correct the violation, and providing a resolution timeframe. Depending on the noncompliance issue (e.g. is the issue an imminent health or safety concern), the time provided for resolution and the degree to which NTMWD may step in and proactively correct an issue may vary. Some violations may immediately generate a fine. NTMWD may, at its discretion, waive fines to be imposed at the first notice. NTMWD will follow up within the specified timeframe to document resolution of the issue. Increased frequency of monitoring and inspection may be warranted for a period of time following resolution.
- Second Notice:* A second notice may involve the same activity or conditions as the first notice, or it may be a new issue. Second notices for the same situation that triggered the first notice will also be linked to increased fines and shorter resolution timeframes. Developer will be required to reimburse NTMWD for costs associated with monitoring, inspection, and follow-up for second notice actions.
- Third Notice:* Three notices for the same or different instances of noncompliance with this Agreement within one year will trigger a notice to revoke or terminate this Agreement. Developer will have 30 days to remove improvements at its expense and restore the Shoreline to its condition prior to the construction of the improvements (if applicable).

Developer may appeal a notice of termination to NTMWD within 15 days of receiving the notice. NTMWD will respond to Developer within 30 days.

Resolution timeframes and fines are dependent on the harm that may occur to people, property, and resources if the violation were to continue. Violations that are hazardous, or potentially hazardous, generally have shorter resolution timeframes and higher penalties than administrative violations. **Exhibit C** outlines resolution timeframes, remedies, and penalties for various violations.

49. **EFFECTIVE DATE AND TERM.** This Agreement becomes effective as of the Effective Date, set forth above, and unless terminated early as provided herein, will be valid for five (5) years following the Effective Date or until NTMWD enters into a Shoreline Lease and Use with the Association and Developer as provided in Section 9 of this Agreement.

IN WITNESS WHEREOF, the Parties hereto acting under authority of their respective governing bodies have caused this Agreement to be duly executed in several counterparts, each of which shall constitute an original.

[The remainder of this page is intentionally left blank. Signatures are on the following pages.]

BD ACQUISITIONS, LLC

By: _____
Scott Rye, Managing Member Date _____

STATE OF _____ §
 §
COUNTY OF _____ §

This instrument was acknowledged before me on this _____ day of _____, 2024,
by Scott Rye, Managing Member of BD Acquisitions, LLC.

Notary Public, State of _____
Printed Name of Notary:

My Commission Expires: _____

[Signatures on following page]

NORTH TEXAS MUNICIPAL WATER DISTRICT

By: _____
Jennafer P. Covington, Executive Director/General Manager Date _____

STATE OF TEXAS §
 §
COUNTY OF COLLIN §

This instrument was acknowledged before me on this _____ day of _____, 2024,
by Jennafer P. Covington, Executive Director/General Manager North Texas Municipal Water
District, a conservation and reclamation district and political subdivision of the State of Texas, on
behalf of said conservation and reclamation district.

Notary Public, State of Texas
Printed Name of Notary:

My Commission Expires: _____

EXHIBIT A

Developer Documents

DRAFT

SHORELINE LEASE AND USE AGREEMENT APPLICATION
Bois d'Arc Lake, North Texas Municipal Water District (NTMWD)
To be submitted through MGO Connect

APPLICANT INFORMATION

Date of Application: 9/25/23 E-mail Address: logue@llcinvest.com
 Name of Applicant: BD Acquisitions LLC Address: 9827 Cogdill Rd. Ste 1
 Telephone: (912) 223-4390 City, State, Zip Code: Knoxville, TN 37932

CONTRACTOR INFORMATION

Name of Contractor: JLC Excavation Address: PO Box 1228
 Telephone: (469) 383-4226 City, State, Zip Code: Canton, TX 75169
 E-mail Address: john.canada@jlcexcavation.com

AGREEMENT TYPE (check one)

- ☒ New
- ☐ Change in Ownership (Reissue Agreement); please provide agreement number:
- ☐ Agreement Renewal; please provide agreement number:

TYPE OF FACILITY (check one or more as appropriate)

Water-Based:

- ☐ Single-Owner Boat Dock
- ☒ Community Boat Dock
- ☐ Other/Exception (describe):

Land-Based:

- ☒ Vegetation Modification (including clearing standing timber)
- ☒ Land-based Recreational Facilities
- ☐ Access Path
- ☐ Other/Exception (describe):

PROJECT DESCRIPTION

Brief description of facility location (include adjacent parcel numbers) and the proposed activity on NTMWD land or easement: Adjacent parcel numbers include 138459, 138460, 138398, 138399, 138,391 - (1) 20 slip dock in The Shores, (1) 20 slip dock in The Peninsula, (1) 8 slip dock in The Peninsula. Golf cart path, dog park, multi-purpose field, playground, fire pit

CONSISTENCY WITH STANDARDS, POLICIES, AND PLANS

Please explain how the proposed project is consistent with NTMWD standards and policies and with the Bois d'Arc Lake Shoreline Management Plan (SMP).

The project balances the needs of the development, lake access and amenities. While also keeping in mind the needs of the water supply (NTMWD) and water quality.

PROJECT EXCEPTIONS (if applicable)

Please explain and justify any deviations in the proposed project from NTMWD standards and policies and the Bois d'Arc Lake SMP.

Length of time to complete construction (if applying for a new agreement) (maximum of one year allowed): One year

Date of pre-application site inspection (for new dock construction): _____

ALTERNATE POINT OF CONTACT

The following alternative party will be available on short-notice call and responsible for providing any access to and surveillance of the structure as needed.

Name of Alternate Contact: Brandon Smith Address: 2259 VZ CR 2802 Mabank, Tx
Telephone: (903) 340-9380 Email Address: brandon@llcinvest.com

APPLICATION FEE

See Fee Table. Application fee submitted to _____

Please note that annual fees may also apply to your Agreement.

ATTACHMENTS to be included with Agreement Application (see Appendix F for submittal requirements)

- For all new Agreements:
 - Provide proof of land ownership (e.g. warranty deed, tax assessor notice) that is immediately adjacent to and shares a common boundary with District land. Submit site map, aerial photos, survey plats, or other documents depicting location of private property.

- A copy of the boundary line survey including the seal and signature of a licensed Professional Land Surveyor. The survey should include the boundary line between NTMWD property and the adjacent landowner/applicant along the entire length requested for use plus an additional 100 feet to either side of the requested use footprint or to the property boundary (whichever is shorter).
- A site plan showing the location of the proposed improvements/activities on NTMWD-owned property. The site plan should show the surveyed boundary line and the relative locations of any proposed improvements/activities on NTMWD land as well as any useful landmarks such as an adjacent residence.
- Access paths: include a plan view showing path route and dimensions and materials to be used. Plan should show topography and appropriate erosion control measures proposed.
- Vegetation modification: include a plan view showing the area to be included in the agreement. Describe the existing vegetation including species and type (e.g. trees, shrubs, grasses) to be removed or modified. If planting is proposed, please refer to the native plant list when making selections.
- For applications for new docks, please also attach:
 - One electronic set of structural plans, electrical plans, and specifications for dock facility that have been approved by a structural engineer. Please include all amenities proposed (e.g. storage box, solar battery storage, boat or PWC lift etc.) and provide construction materials and dimensions of facility. Reference to an approved dock plan on file with NTMWD is also acceptable. Please identify any additions or alterations to an approved plan. Structural alterations proposed are required to be stamped by a structural engineer and/or electrician as appropriate.
 - If the adjoining private land is jointly-owned (e.g. Trust, LLC, Non-Profit, etc.), dock applicants must provide documentation indicating their interest in the jointly-owned property.
 - If replacing an existing dock, submit a letter stating the old dock will be dismantled and removed within 30 days of the installation of the new dock.
 - For Community Docks, provide authorized contact and alternates including name, address, and phone numbers.
- For reissuance or renewal of dock agreements only:
 - Electrical Certification (if applicable);
 - Certificate of Compliance or signed statement that all noted deficiencies have been corrected. This signifies the dock meets current inspection criteria.
 - For Community Docks, provide authorized contact and alternates including name, address, and phone numbers.

Please review the conditions that are required of all Shoreline Lease and Use Agreements as found in the SMP. General conditions for Shoreline Lease and Use Agreements are found in Appendix C of the SMP. The general conditions will be applied to all Shoreline Lease and Use Agreements. Additional site-specific conditions may be developed following review of your application.

Note: NTMWD reserves the right to alter this form or to request additional information not specified in this form.

SIGNATURE

I hereby designate and authorize the agent/consultant identified above to act on my behalf in processing of this agreement application, and to furnish, upon request, supplemental information in support of this application for shoreline use.



(Signature of Applicant/Adjacent Landowner) 10/30/2023
(Date)

SCOTT RYE

(Printed Name of Applicant/Adjacent Landowner) 10/30/2023
(Date)

(Signature of Applicant/Adjacent Landowner) _____
(Date)

(Printed Name of Applicant/Adjacent Landowner) _____
(Date)

I certify that the information provided on this form and all attachments related to this project are true and accurate to the best of my knowledge. I understand that failure to provide true and accurate information may result in the Application being denied or a previously approved Agreement being terminated.



(Signature of Applicant) 10/30/23
(Date)

Brian M Logue


(Printed Name of Applicant) 10/30/23
(Date)

(Signature of Applicant)

(Date)

(Printed Name of Applicant)

(Date)


(Signature of Contractor)

10/25/23
(Date)

JOHN CANADA
(Printed Name of Contractor)

10/25/23
(Date)

DRAFT



September 13, 2024

Ms. Jennifer Montgomery, Director
Lake Operations Manager
North Texas Municipal Water District
4989 FM897
Dodd City, TX 75438

Re: The Peninsula and The Shores at The Peninsula
Development Agreement and Shoreline Lease and Use Agreement

Dear Ms. Montgomery,

The following documents have been submitted to the North Texas Water District (the "District") by BD Acquisitions, LLC for inclusion with the Development Agreement and Shoreline Lease and Use Agreement to be executed between BD Acquisitions, LLC and the District for the proposed The Peninsula and The Shores at The Peninsula development. All documents being prepared by Abbott Consulting & Engineering, LLC, generally conform to the Shoreline Management Plan (SMP) with exceptions noted on the documents and are complete, correct and in compliance with the SMP. All documents related to the actual boat docks, structures, electrical, and solar equipment were prepared and provided by others as noted below. The products and materials selected by the Developer, as shown on the documents prepared by Abbott Consulting & Engineering, LLC, are appropriate for the proposed site and application, the proposed size and extent is sufficient and shall meet the minimum specification requirements in the SMP.

- Shoreline Lease and Use Agreement Application (prepared by BD Acquisitions, LLC)
- Recorded Final Plat for The Peninsula and The Shores at The Peninsula (prepared by Hardin Surveying)
- Declaration of Covenants, Conditions and Restrictions for The Peninsula and The Shores at The Peninsula (prepared by BD Acquisitions, LLC)
- Shoreline Development Agreement Exhibit (prepared by Abbott Consulting and Engineering, LLC) depicting proposed improvements on NTMWD property and the following notes and additional information:
 - General Notes and Construction Notes



- Description of Activity on NTMWD Land
- Notes regarding Consistency with Standards, Policies, and Plans
- Project Exceptions and Justifications
- Community Docks and Shared Docks Plans (prepared by Childers Engineering Services)
- Solar/Electrical Plans (prepared by Flotation Systems, INC)
- Typical Cross-Sections for each Community Dock and Shared Dock (prepared by Flotation Systems, INC)
- Shoreline Stabilization Measures (prepared by Abbott Consulting and Engineering, LLC)

Based on the specifications, the proposed shoreline stabilization system is appropriate for this application and the specifications meet the minimum requirements for revetments in the SMP (unless otherwise noted). The proposed width and limits of the revetment are appropriate in order to meet the requirements of the site and the SMP.

Sincerely,



Brian C. Abbott, P.E.

CIVIL CONSTRUCTION PLANS

FOR

THE PENINSULA & THE SHORES


AT BOIS D'ARC LAKE

FANNIN COUNTY, TEXAS

DEVELOPER
BD ACQUISITIONS, LLC
9827 COGHILL ROAD, SUITE 1
KNOXVILLE, TN 37932
865.777.1170 PH
MATT LOGUE

SURVEYOR
HARDIN SURVEYING
127 E MARKET STREET
MABANK, TX 75147
903.887.5674 PH
JOEY PATRICK, RPLS

ENGINEER
ABBOTT CONSULTING &
ENGINEERING, LLC
P.O. BOX 997
CANTON, TEXAS 75103
214.616.0787 PH
BRIAN C. ABBOTT, P.E.

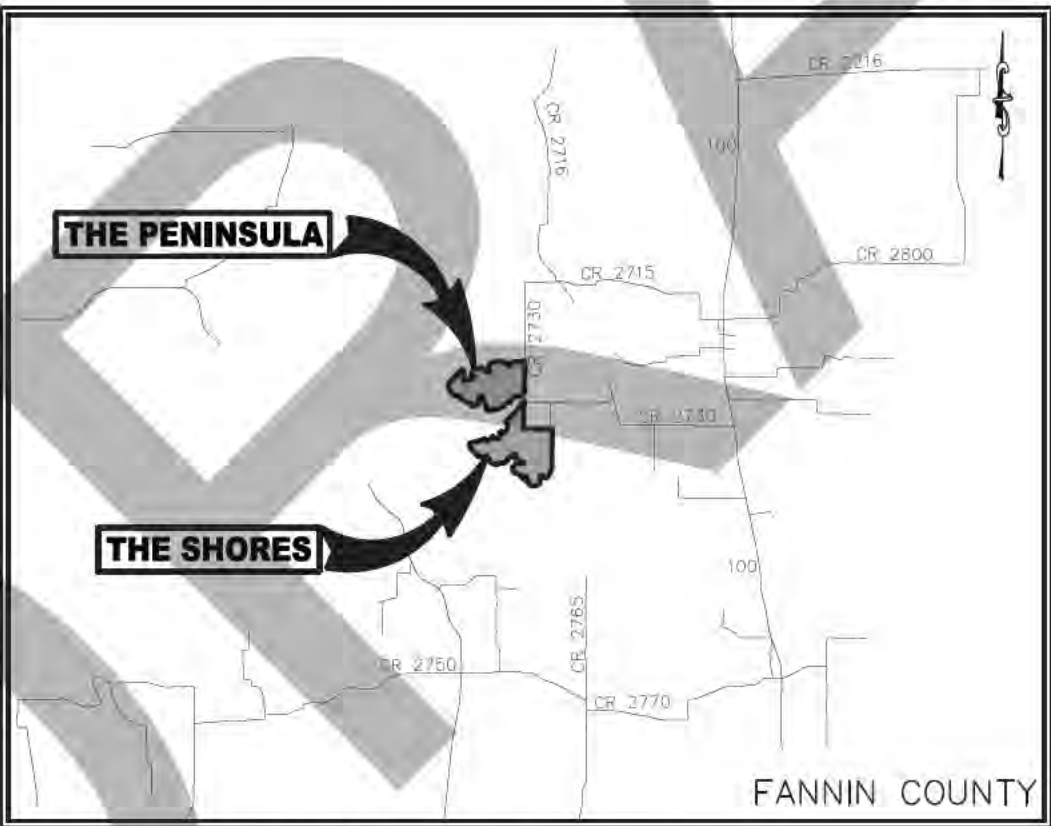

VICINITY MAP
(NOT TO SCALE)

SHEET INDEX

SHEET NO.	SHEET TITLE
C000	COVER SHEET
C001	THE PENINSULA FINAL PLAT
C002	THE SHORES AT THE PENINSULA FINAL PLAT
C003	THE SHORES AT THE PENINSULA FINAL PLAT
C100	OVERALL SITE PLAN
C200	THE PENINSULA COMMUNITY AREA SITE PLAN
C201	THE PENINSULA BOAT DOCK - LOTS P-16-P-23
C300	THE SHORES COMMUNITY AREA SITE PLAN
C301	THE SHORES EROSION & SHORELINE STABILIZATION
C302	THE SHORES PLAYGROUND
C303	THE SHORES DOG PARK
C304	THE SHORES TENNIS/PICKLEBALL COURT
C305	THE SHORES CART PARKING, FIRE PIT, AND FLAG POLE
C400	CONSTRUCTION DETAILS
C401	CONSTRUCTION DETAILS
C402	CONSTRUCTION DETAILS

I HEREBY CERTIFY THAT THESE CIVIL ENGINEERING PLANS
HAVE BEEN PREPARED BY ME OR UNDER MY DIRECT
SUPERVISION. I FURTHER CERTIFY THAT THE PLANS ARE
COMPLETE, ACCURATE, AND IN COMPLIANCE WITH THE
BOIS D'ARC LAKE SHORELINE MANAGEMENT PLAN.

THE PENINSULA &
THE SHORES AT
BOIS D'ARC LAKE
FANNIN COUNTY, TEXAS

COVER SHEET

09/13/2024

REVISIONS	DATE	COMMENTS



09/13/2024


SHEET NO.
C000

ABBOTT
CONSULTING &
ENGINEERING, LLC




P.O. Box 997
Canton, TX 75103
Brian@abbott-ce.com
Phone: (214) 616-0787
Texas Firm # F-21189

THE PENINSULA & THE SHORES - Fannin County, Texas - ACE Project No. 23158-03

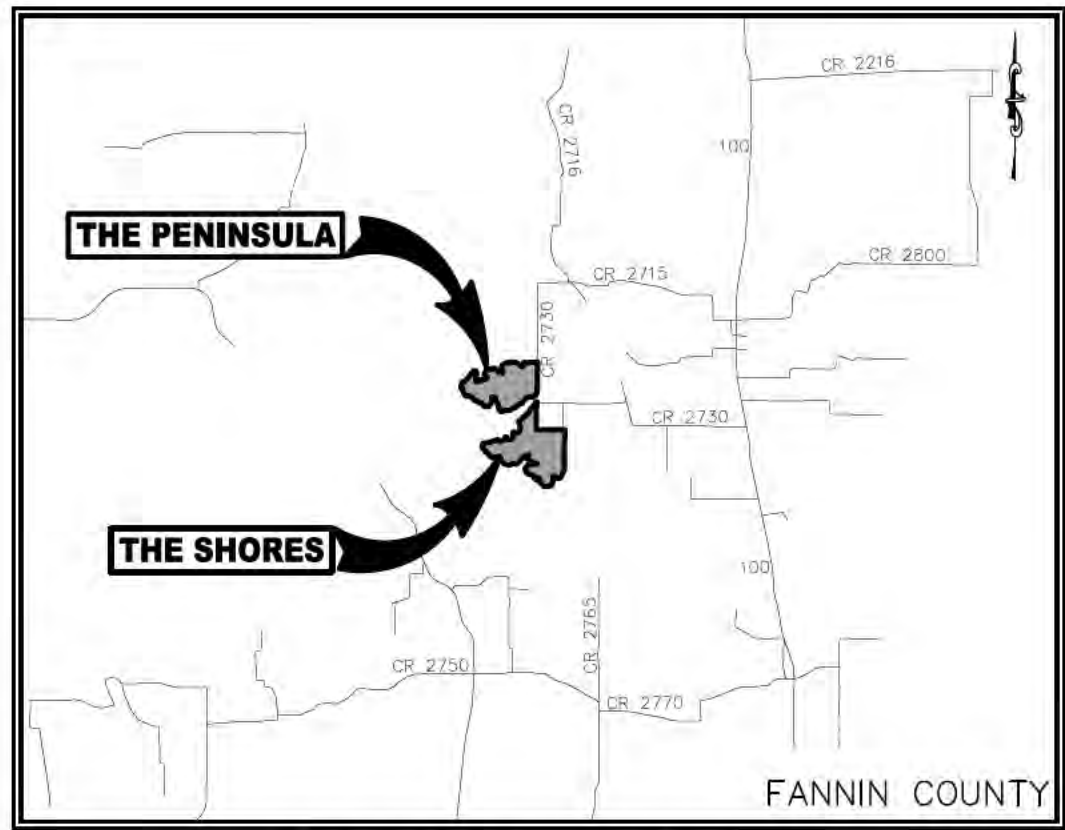

VICINITY MAP
(NOT TO SCALE)

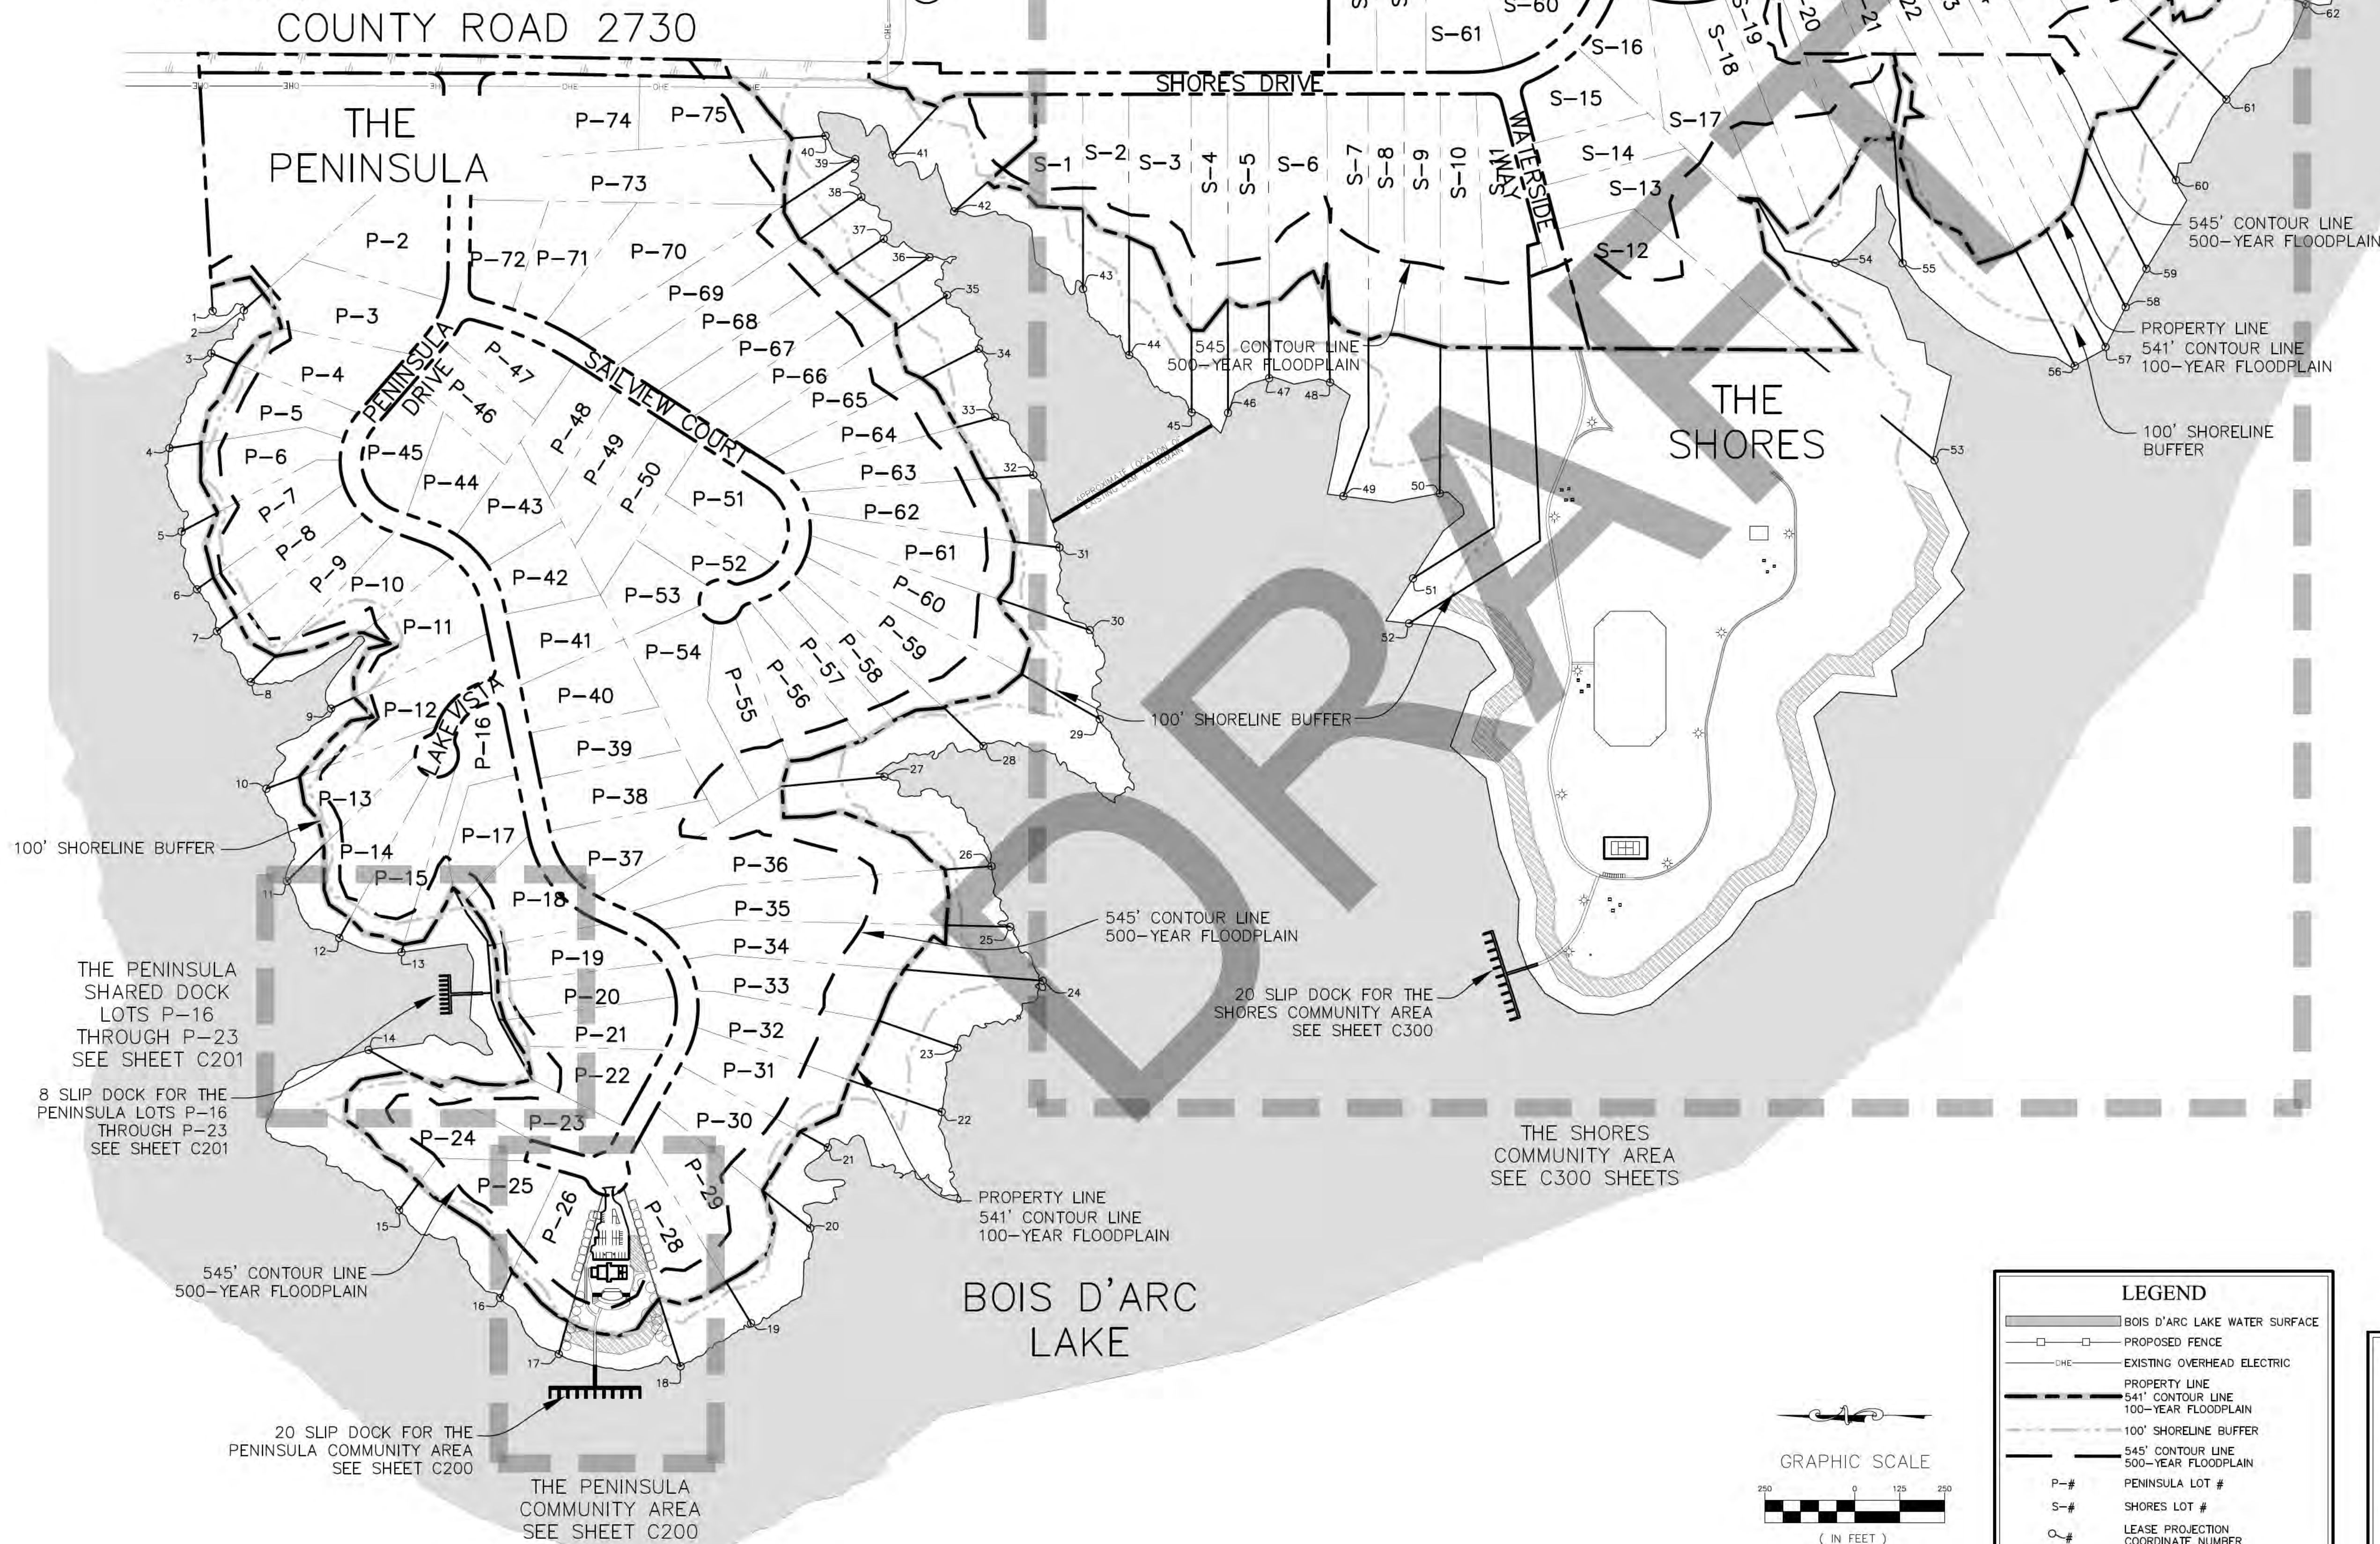

PROJECTION LINE COORDINATE TABLE		
POINT #	NORTHING	EASTING
1	7307951.60	2744112.05
2	7307864.93	2744114.29
3	7307955.47	2743994.85
4	7308071.96	2743731.11
5	7308038.01	2743499.03
6	7307995.10	2743338.42
7	7307939.61	2743221.91
8	7307845.45	2743080.75
9	7307622.58	2743005.70
10	7307802.36	2742784.11
11	7307744.88	2742527.01
12	7307599.49	2742368.93
13	7307426.60	2742329.54
14	7307518.19	2742057.88
15	7307433.08	2741611.98
16	7307152.35	2741368.12
17	7306989.16	2741212.41
18	7306650.41	2741178.28
19	7306454.27	2741297.76
20	7306289.57	2741562.22
21	7306241.01	2741786.75
22	7305924.08	2741885.25
23	7305880.32	2742063.60
24	7305643.38	2742250.35
25	7305734.25	2742400.35
26	7305785.74	2742568.68
27	7306083.49	2742817.46
28	7305807.95	2742902.93
29	7305484.77	2742977.64
30	7305512.12	2743225.19
31	7305596.76	2743454.91
32	7305669.47	2743656.43
33	7305775.84	2743817.72
34	7305820.45	2744007.28
35	7305909.10	2744156.63
36	7305958.17	2744262.29
37	7306085.52	2744313.24
38	7306147.60	2744429.71
39	7306184.47	2744534.99
40	7306247.27	2744599.51
41	7306061.50	2744546.16
42	7305889.78	2744389.34
43	7305531.19	2744173.42
44	7305402.92	2743989.67
45	7305229.21	2743630.50
46	7305127.93	2743829.15
47	7305013.63	2743925.56
48	7304844.25	2743913.82
49	7304807.16	2743597.48
50	7304539.12	2743605.28
51	7304613.72	2743368.87
52	7304624.78	2743243.79
53	7303183.45	2743697.51
54	7303438.99	2744246.11
55	7303252.12	2744245.05
56	7303273.20	2743960.05
57	7302687.70	2744012.50
58	7302631.92	2744123.20
59	7302574.05	2744229.79
60	7302491.95	2744476.41
61	7302351.57	2744700.54
62	7302130.45	2744965.45
63	7302026.90	2745219.46
64	7302056.14	2745457.67
65	7302126.44	2745637.02
66	7302277.77	2745711.46
67	7302390.68	2745853.60
68	7302427.70	2745943.64
69	7302545.01	2746036.02
70	7302716.08	2746115.93

LEGEND

- BOIS D'ARC LAKE WATER SURFACE
- PROPOSED FENCE
- EXISTING OVERHEAD ELECTRIC
- PROPERTY LINE
- 541' CONTOUR LINE
- 100-YEAR FLOODPLAIN
- 100' SHORELINE BUFFER
- 545' CONTOUR LINE
- 500-YEAR FLOODPLAIN
- P-# PENINSULA LOT #
- S-# SHORES LOT #
- Q-# LEASE PROJECTION COORDINATE NUMBER

- NOTES**
- NO LAND DISTURBING ACTIVITIES ON NTMWD SHALL OCCUR WITHOUT PRIOR WRITTEN AUTHORIZATION FROM NTMWD.
 - NTMWD FLOWAGE EASEMENT CONSISTS OF THAT LAND BETWEEN THE 541' MSL CONTOUR AND 545' MSL CONTOUR.
 - ALL FACILITIES TO BE DESIGNED AND CONSTRUCTED TO CONFORM TO ADA STANDARDS.
 - EXCEPT AS SHOWN ON THESE PLANS, ALL NTMWD BOUNDARY MARKERS SHALL BE PLACED BY THE INDIVIDUAL LOT OWNERS.
 - THE PENINSULA PLAT INSTRUMENT #2023000017.
 - THE SHORES AT THE PENINSULA PLAT INSTRUMENT #2023000018.
 - THE ONLY BOAT DOCKS INCLUDED AS PART OF THIS PERMIT ARE THE "20 SLIP DOCK FOR THE PENINSULA COMMON AREA", "8 SLIP DOCK FOR THE PENINSULA LOTS P-16 THROUGH P-23", AND "20 SLIP DOCK FOR THE SHORES COMMON AREA".

ABBOTT CONSULTING & ENGINEERING, LLC

THE PENINSULA & THE SHORES AT BOIS D'ARC LAKE

OVERALL SITE PLAN




Phone: (214) 616-0787
Texas Firm # F-21189

P.O. Box 997
Canton, TX 75103
Brian@abbott-ce.com

09/13/2024

SHEET NO. C100

THE PENINSULA & THE SHORES - Fannin County, Texas - ACE Project No. 23158-03

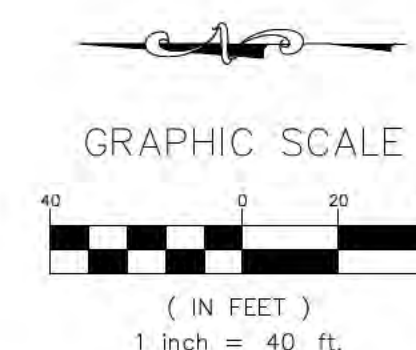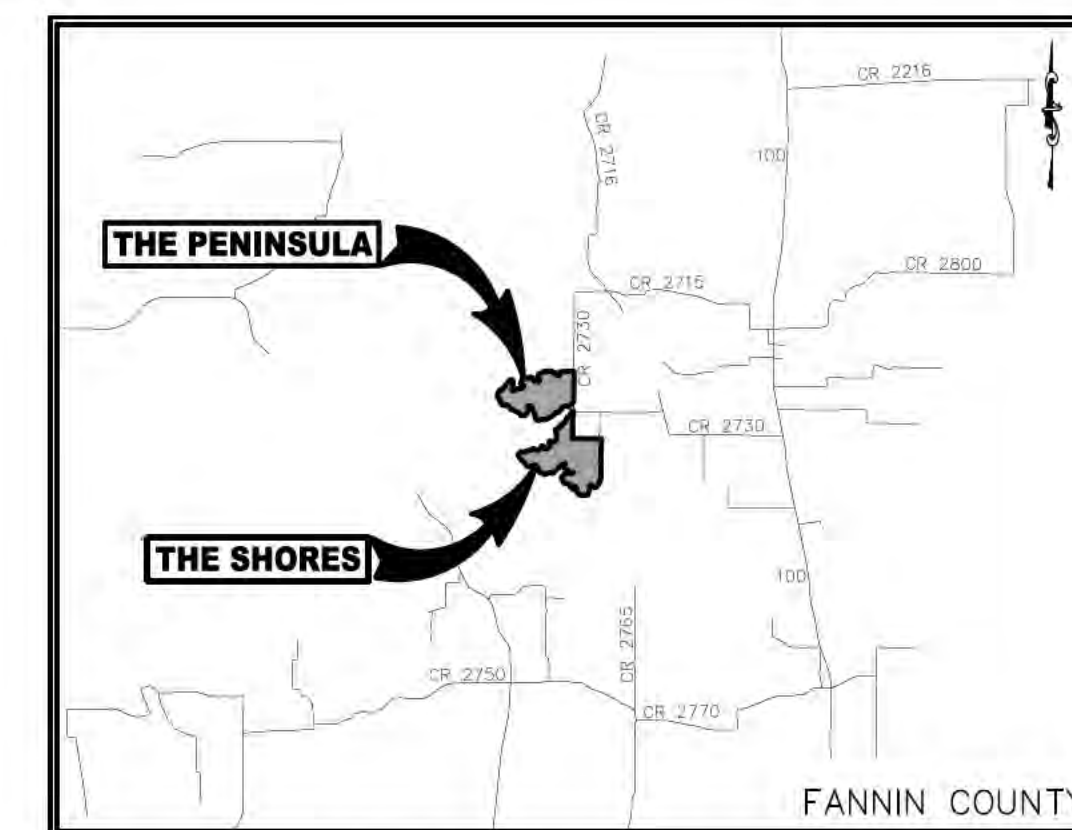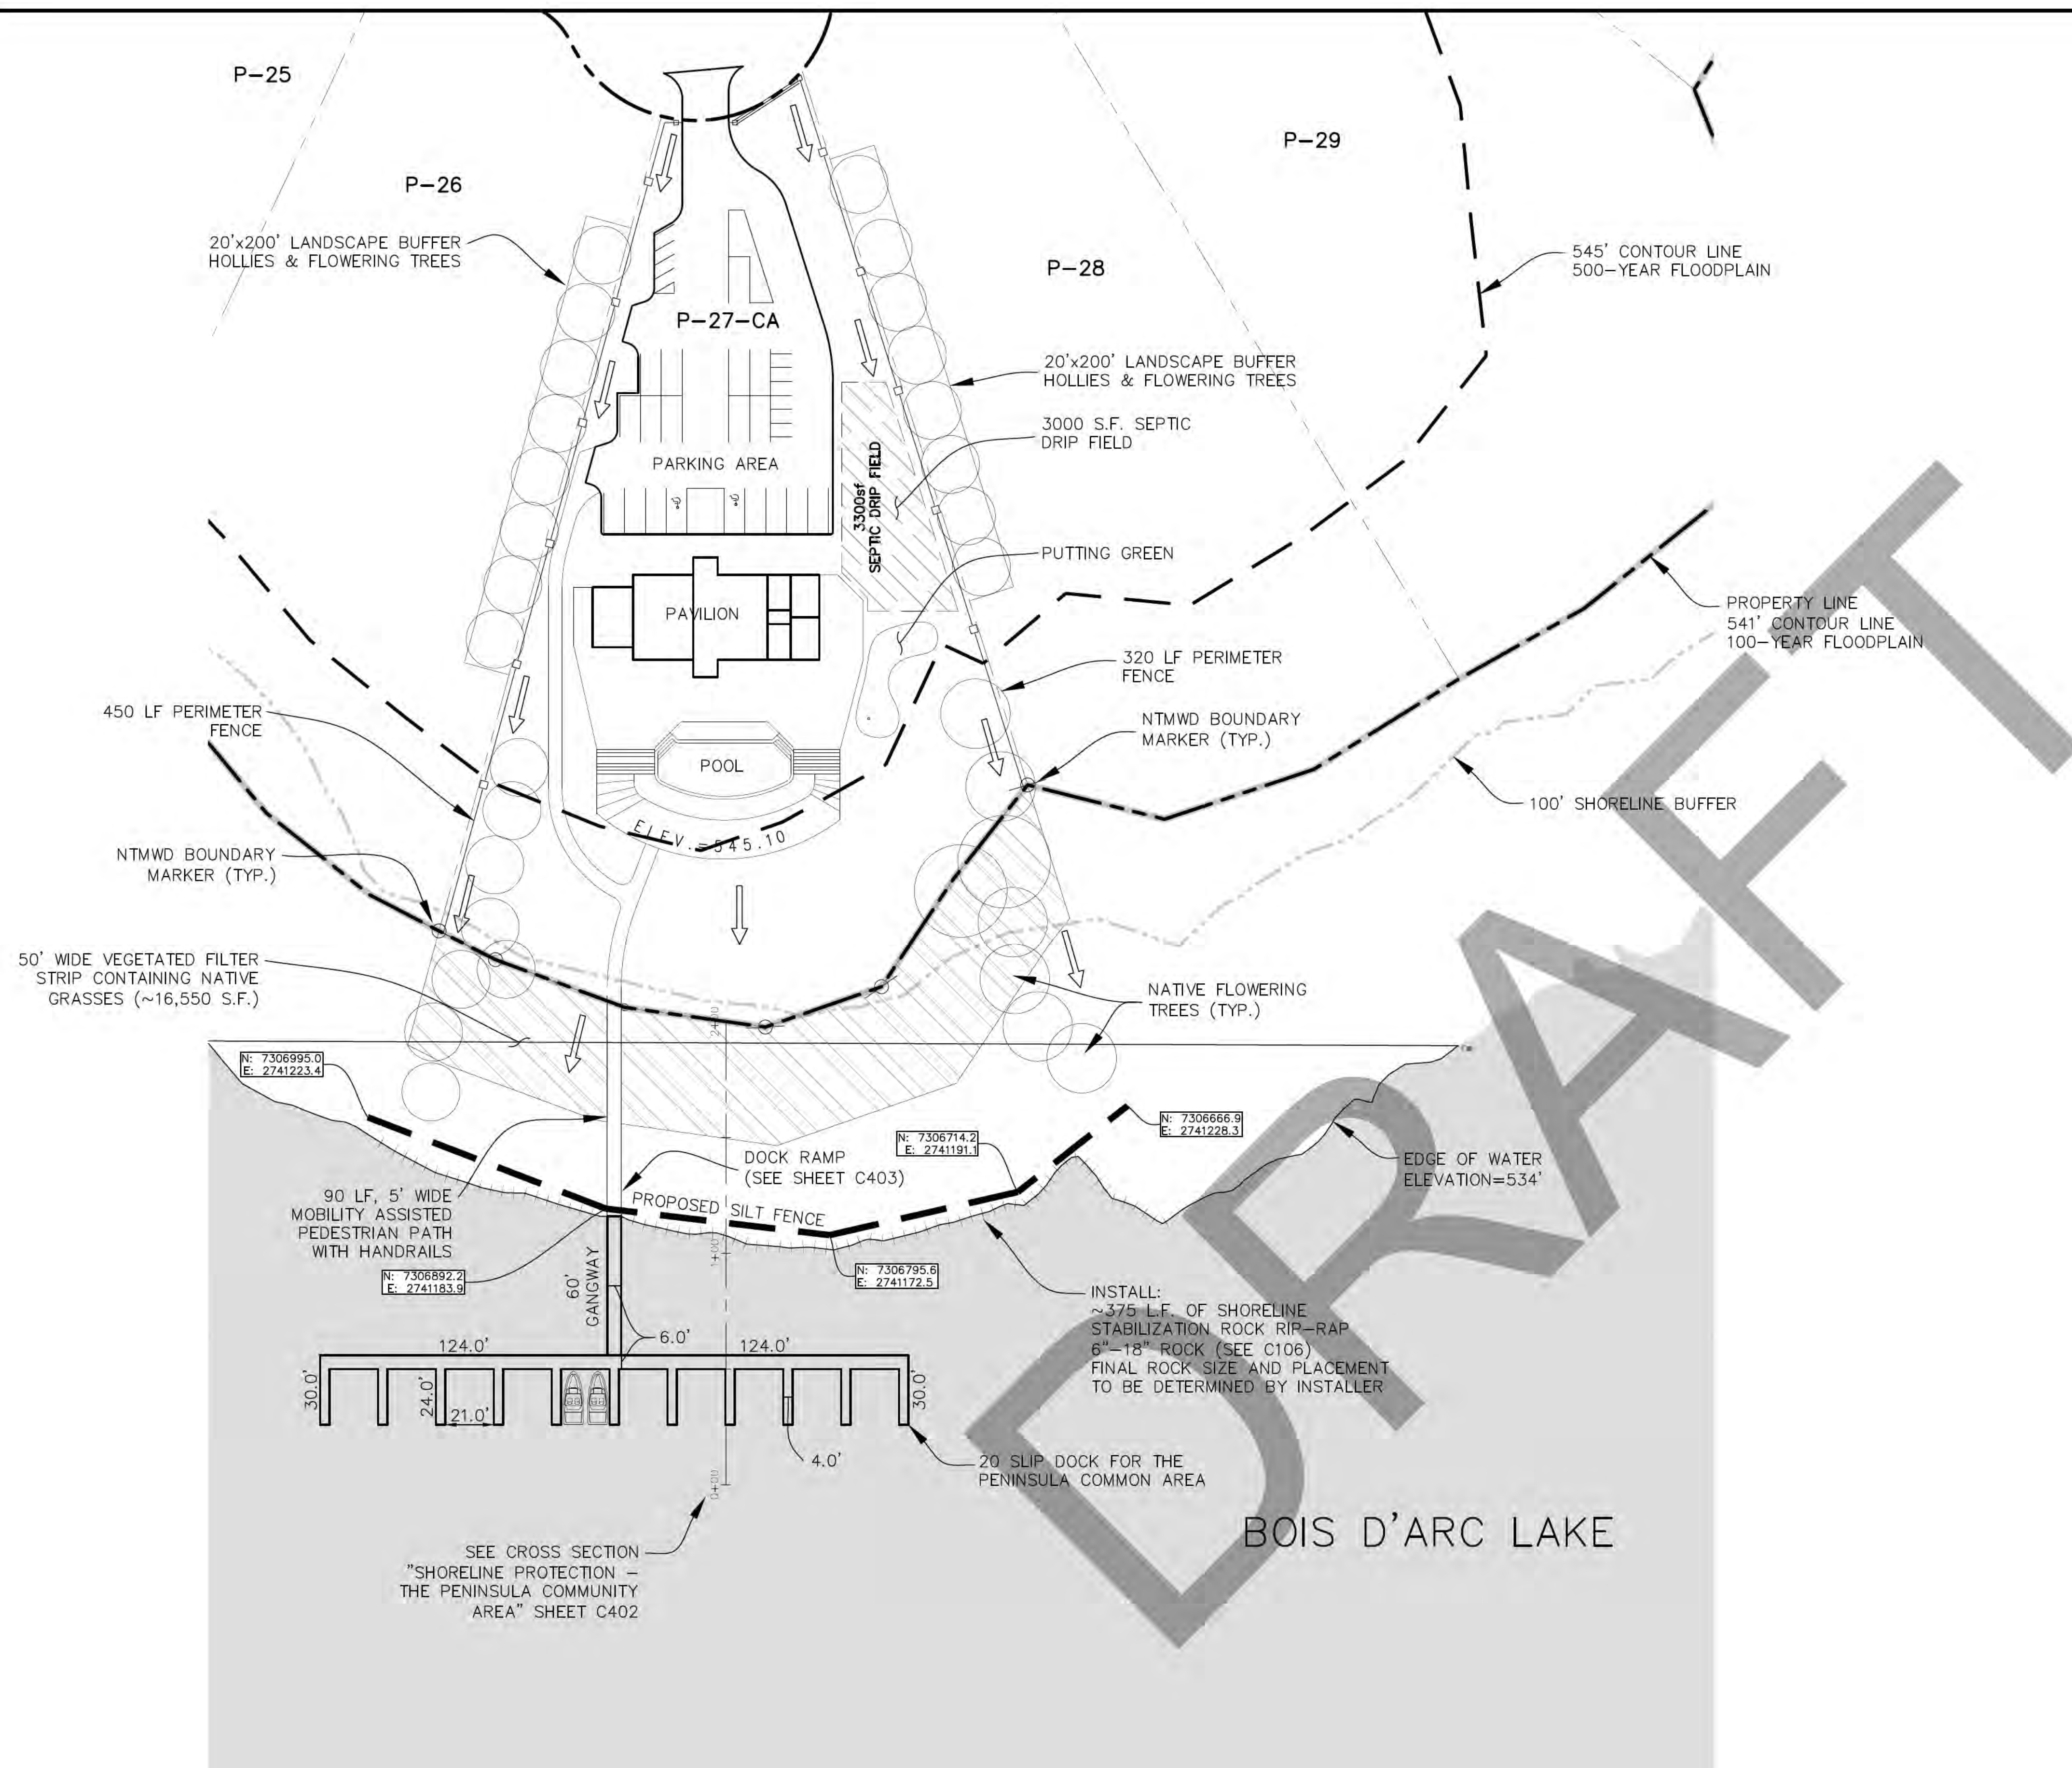

LEGEND

- BOIS D'ARC LAKE WATER SURFACE
- DRAINAGE DIRECTION
- PROPOSED FENCE
- PROPERTY BOUNDARY
- 541' CONTOUR LINE
- 100-YEAR FLOODPLAIN
- 100' SHORELINE BUFFER
- 545' CONTOUR LINE
- 500-YEAR FLOODPLAIN
- TRAFFIC FLOW DIRECTION
- PROPOSED SOLAR POWERED LIGHT

- # NOTES
1. REFERENCE SEPARATE DOCK PLANS FOR STRUCTURAL, ELECTRICAL AND ELEVATIONS.
 2. ALL ELEVATIONS SHOWN ARE BASED ON CONTOUR DATA OBTAINED FROM THE SURVEY. VERIFY ELEVATIONS PRIOR TO CONSTRUCTION.
 3. ALL DISTURBED AREAS BELOW THE 541' CONTOUR LINE SHALL BE RESTORED TO PRE-DEVELOPED CONDITIONS.
 4. POSITIVE DRAINAGE SHALL BE PROVIDED AT ALL LOCATIONS.
 5. SEE SHEET C400-C402 FOR DETAILS.
 6. NO LAND DISTURBING ACTIVITIES ON NTWMD SHALL OCCUR WITHOUT PRIOR WRITTEN AUTHORIZATION FROM NTWMD.
 7. NTWMD FLOWAGE EASEMENT CONSISTS OF THAT LAND BETWEEN THE 541' MS CONTOUR AND 545'.
 8. ALL FACILITIES TO BE DESIGNED AND CONSTRUCTED TO CONFORM TO ADA STANDARDS.
 9. ALL LIGHTING SHOWN TO BE INDIVIDUAL SOLAR POWERED.
 10. EXACT ALIGNMENT OF PATHS ON NTWMD PROPERTY TO BE DETERMINED BY NTWMD PRIOR TO CONSTRUCTION.
 11. EXCEPT AS SHOWN ON THESE PLANS, ALL NTWMD BOUNDARY MARKERS SHALL BE PLACED BY THE INDIVIDUAL LOT OWNERS.
 12. THE PENINSULA PLAT INSTRUMENT #2023000018.
 13. THE SHORES AT THE PENINSULA PLAT INSTRUMENT #2023000018.

**ABBOTT
CONSULTING &
ENGINEERING, LLC**



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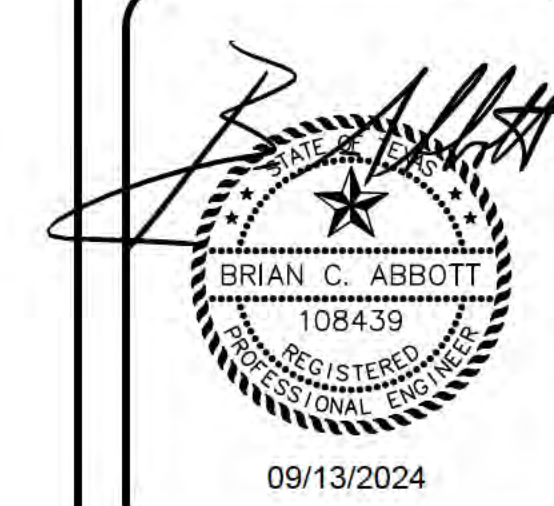
THE PENINSULA & THE SHORES — Fannin County, Texas — ACE Project No. 23158-03

THE PENINSULA &
THE SHORES AT
BOIS D'ARC LAKE

EANNIN COUNTY TEXAS

THE PENINSULA COMMUNITY AREA SITE PLAN

7/9/13/2024



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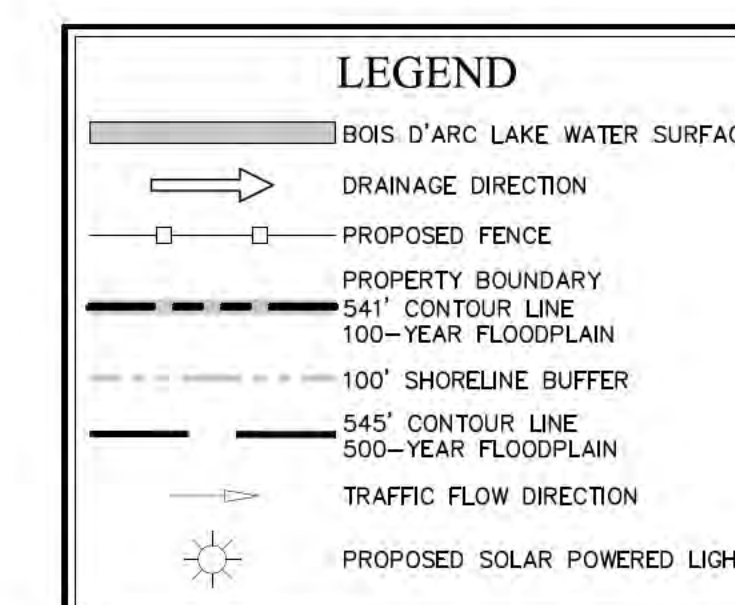
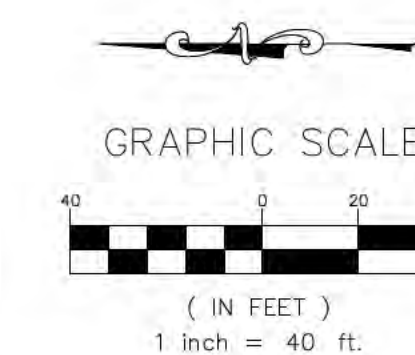
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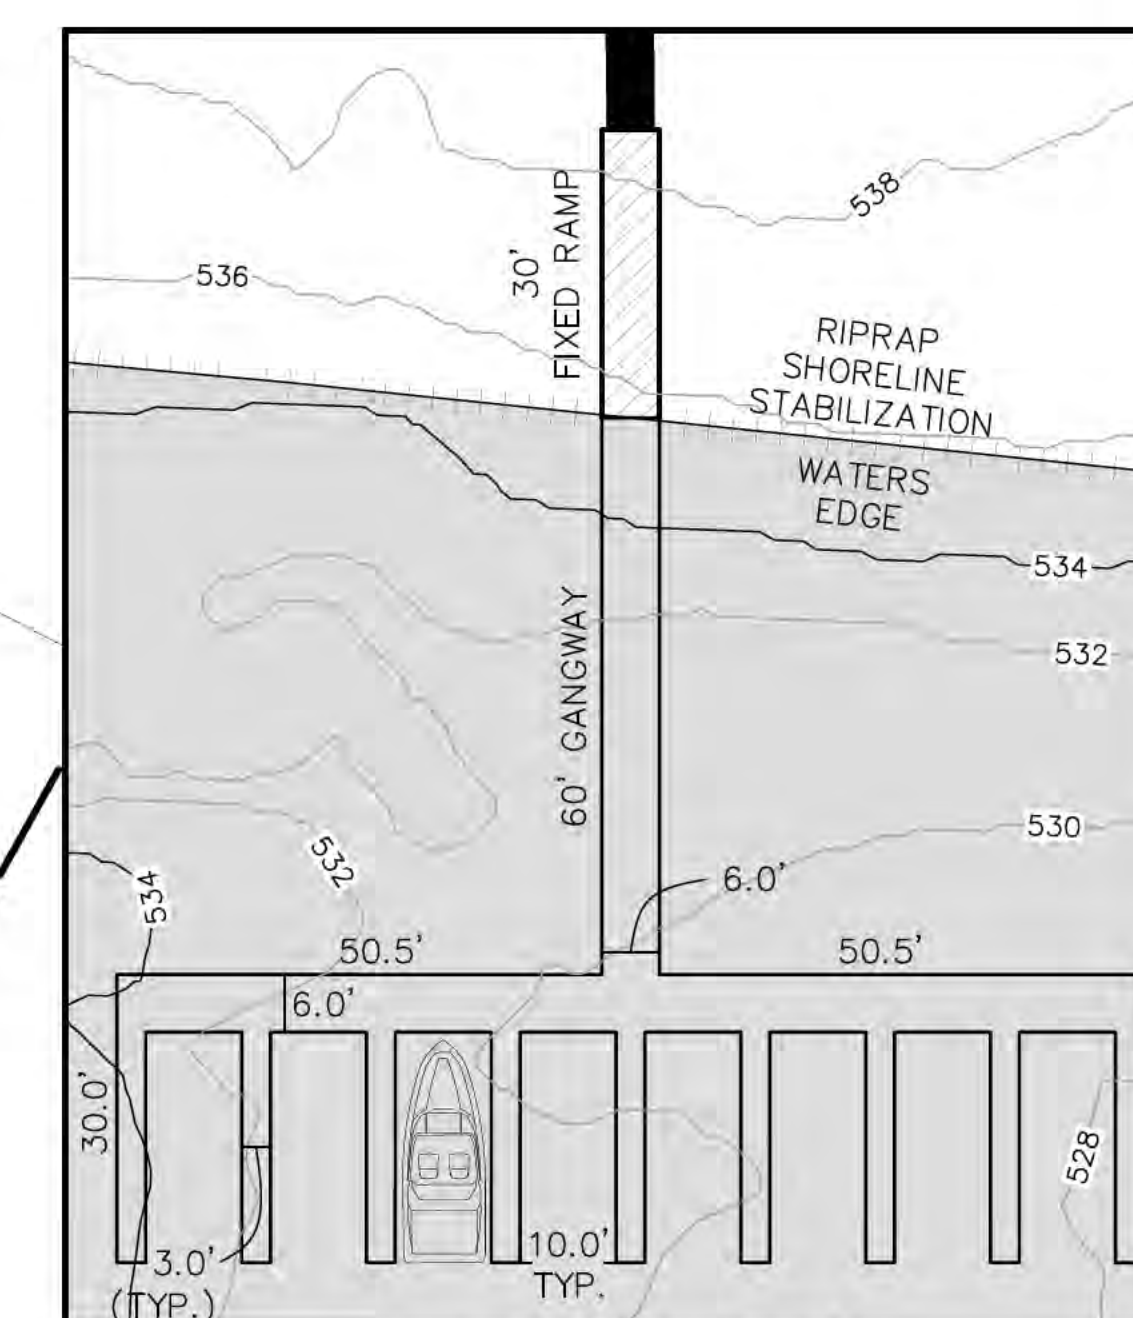


VICINITY MAP



NOTES

1. REFERENCE SEPARATE COCK PLANS FOR STRUCTURAL, ELECTRICAL AND ELEVATIONS.
2. ALL ELEVATIONS SHOWN ARE BASED ON CONTOUR DATA OBTAINED FROM THE NTMS DATABASE. VERTY ELEVATIONS PRIOR TO CONSTRUCTION.
3. ALL TERRAIN AREAS WITHIN THE 541' CONTOUR LINE SHALL BE RESTORED TO PRE-DEVELOPED CONDITIONS.
4. POSITIVE DRAINAGE SHALL BE PROVIDED AT ALL LOCATIONS.
5. SEE SHEET C400-C402 FOR DETAILS.
6. NO LAND DISTURBING ACTIVITIES OCCUR WITHOUT PRIOR WRITTEN AUTHORIZATION FROM NTMWD.
7. NTMWD FLOWAGE ESCAPEMENT CONSISTS OF THAT LAND BETWEEN THE 541' MSL CONTOUR AND 545' MSL CONTOUR.
8. ALL PATHWAYS TO BE DESIGNED AND CONSTRUCTED TO CONFORM TO ADA STANDARDS.
9. ALL LIGHTING SHOWN TO BE INDIVIDUAL SOLAR POWERED.
10. EXACT ALIGNMENT OF ALL PATHS ON NTMWD PROPERTY TO BE DETERMINED BY LAND RECORDS FOR CONSTRUCTION.
11. EXCEPT AS SHOWN ON THESE PLANS, ALL NTMWD BOUNDARY MARKERS SHALL BE PLACED BY THE INDIVIDUAL LOT OWNERS.
12. THE PENINSULA PLAT INSTRUMENT #2023000018.
13. THE SHORES AT THE PENINSULA PLAT INSTRUMENT #2023000018.
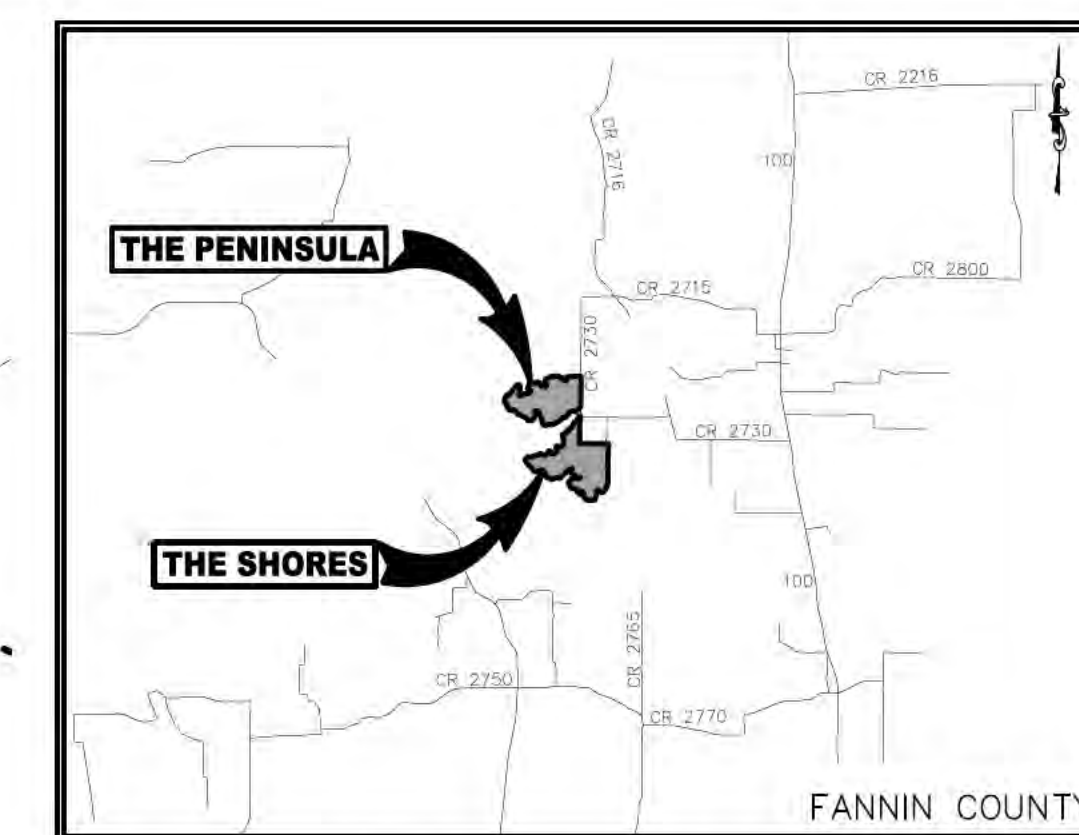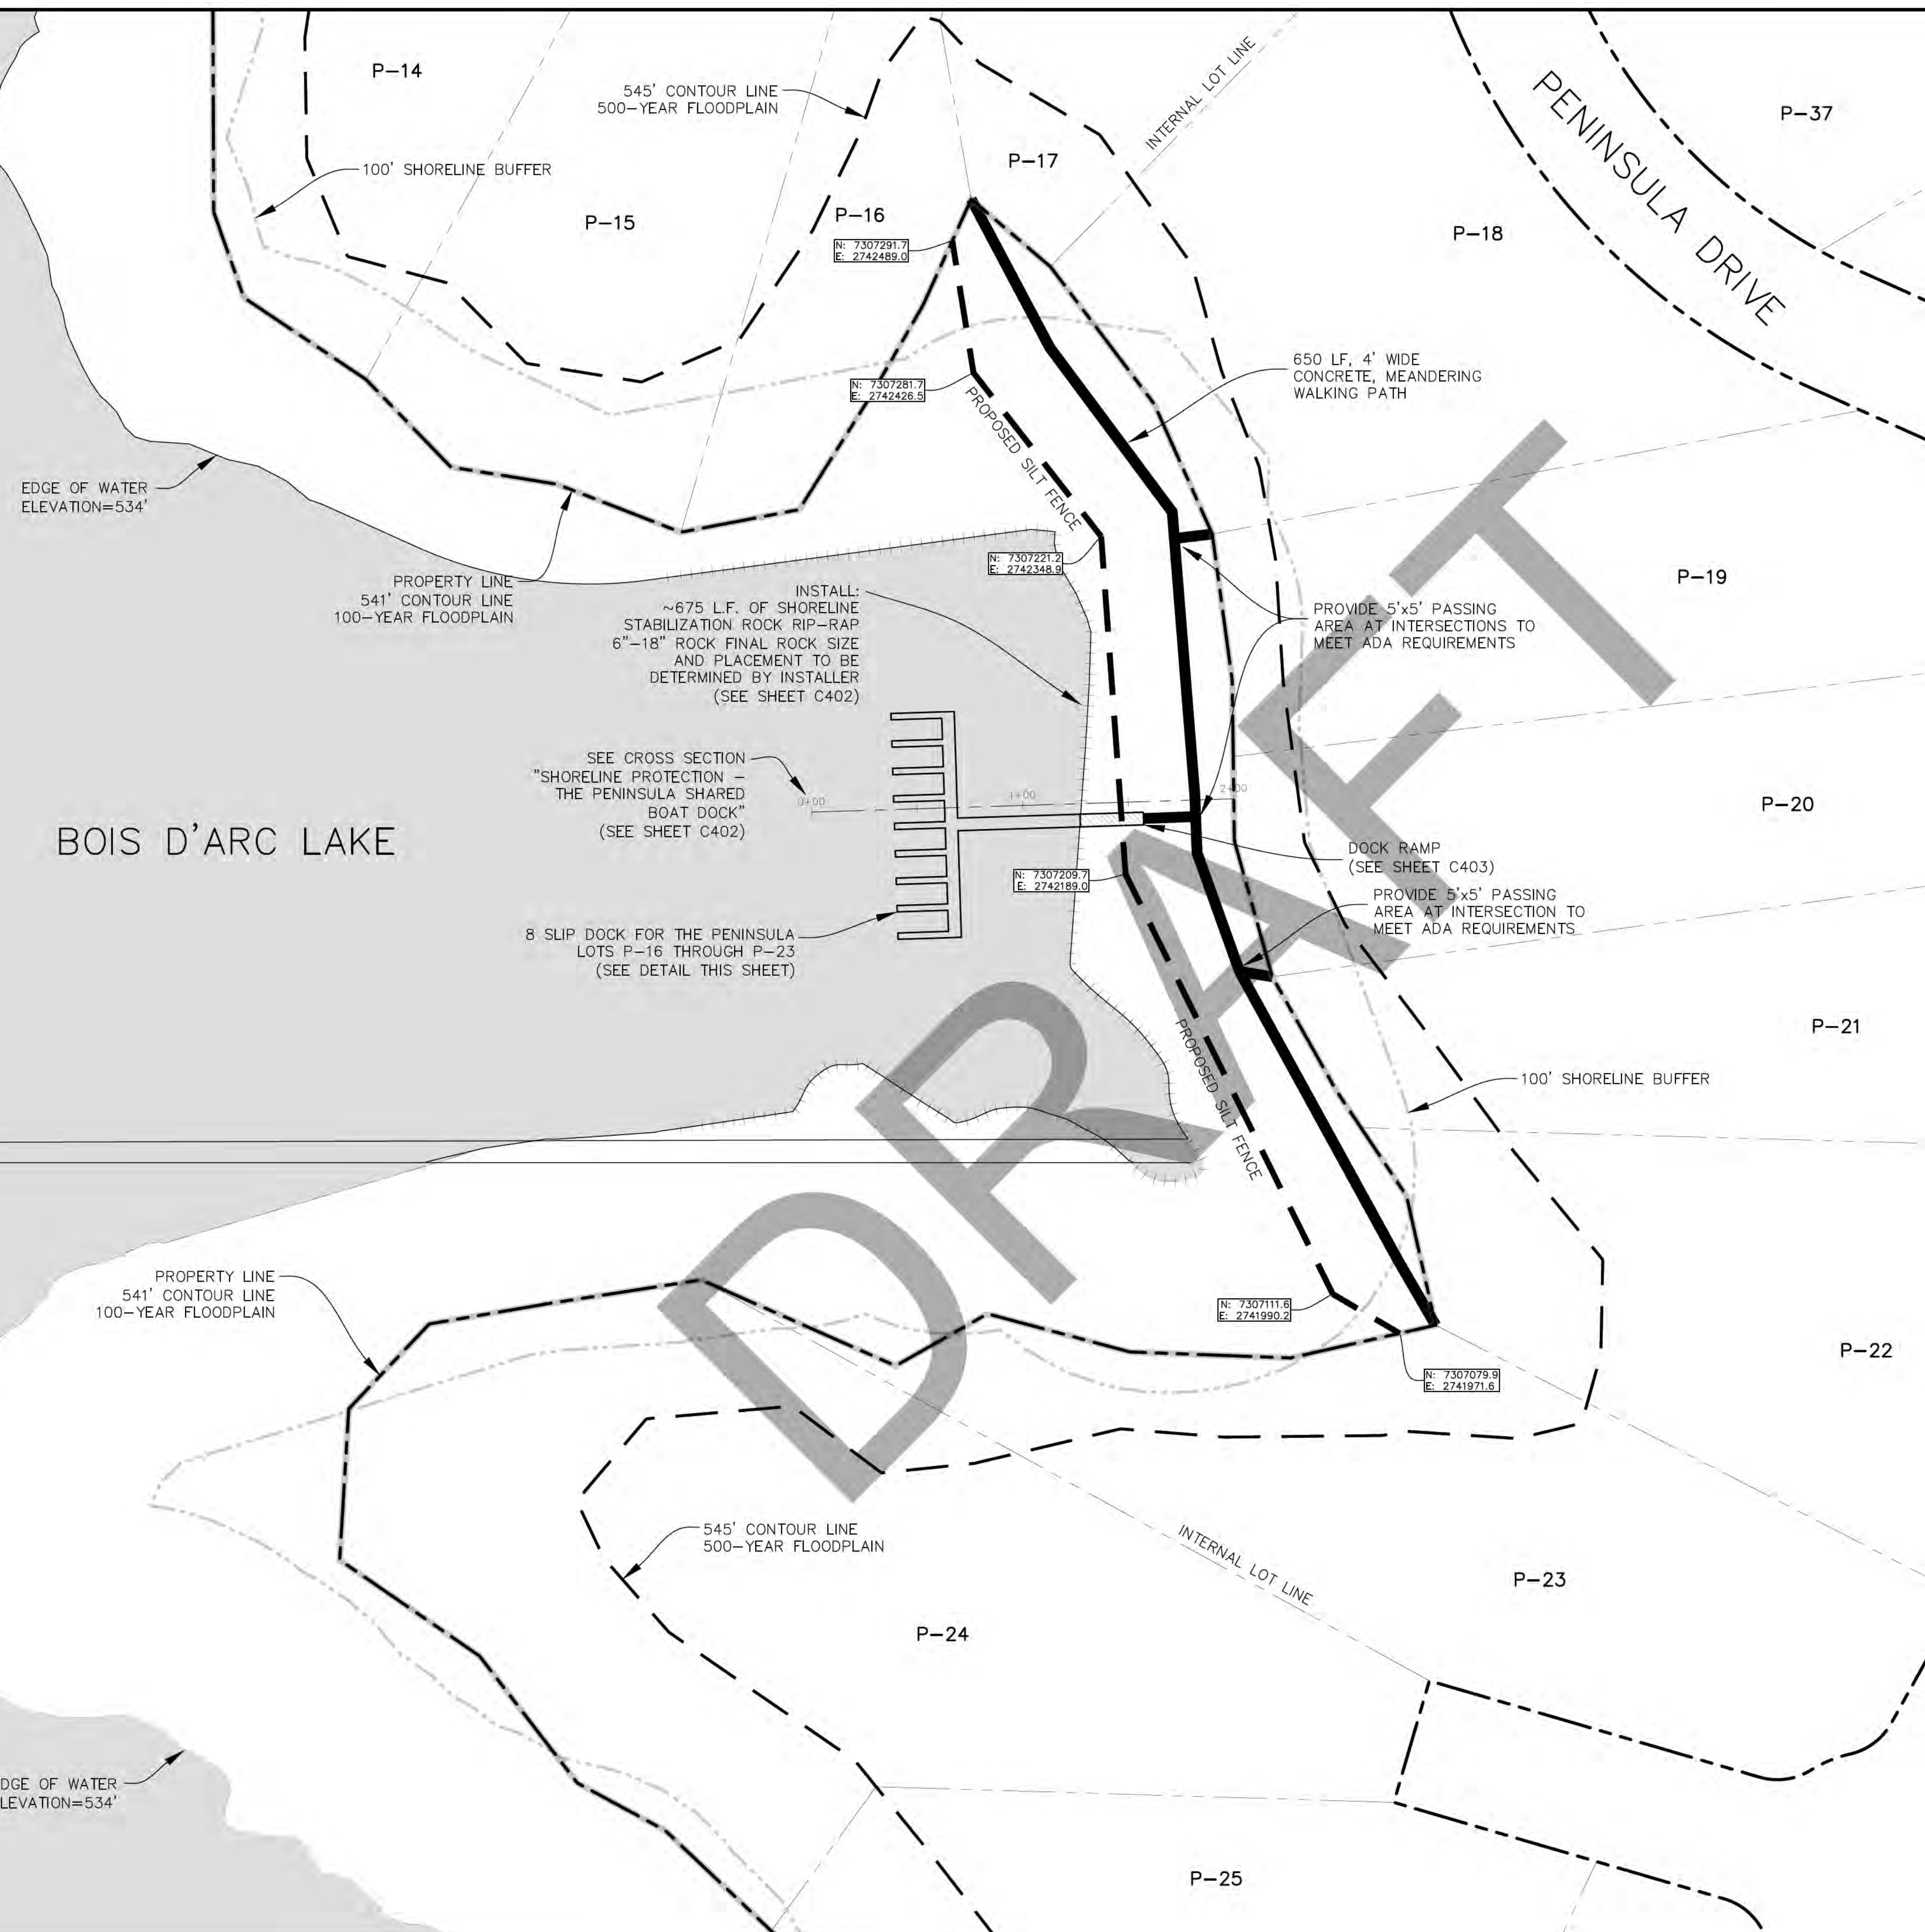
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SHEET NO.
C201



**THE PENINSULA &
THE SHORES AT
BOIS D'ARC LAKE**
FANNIN COUNTY, TEXAS

**ABBOTT
CONSULTING &
ENGINEERING, LLC**



P.O. Box 997
Canton, TX 75103
Brian@Abbott-CE.com

THE PENINSULA & THE SHORES - Fannin County, Texas - ACE Project No. 23158-03

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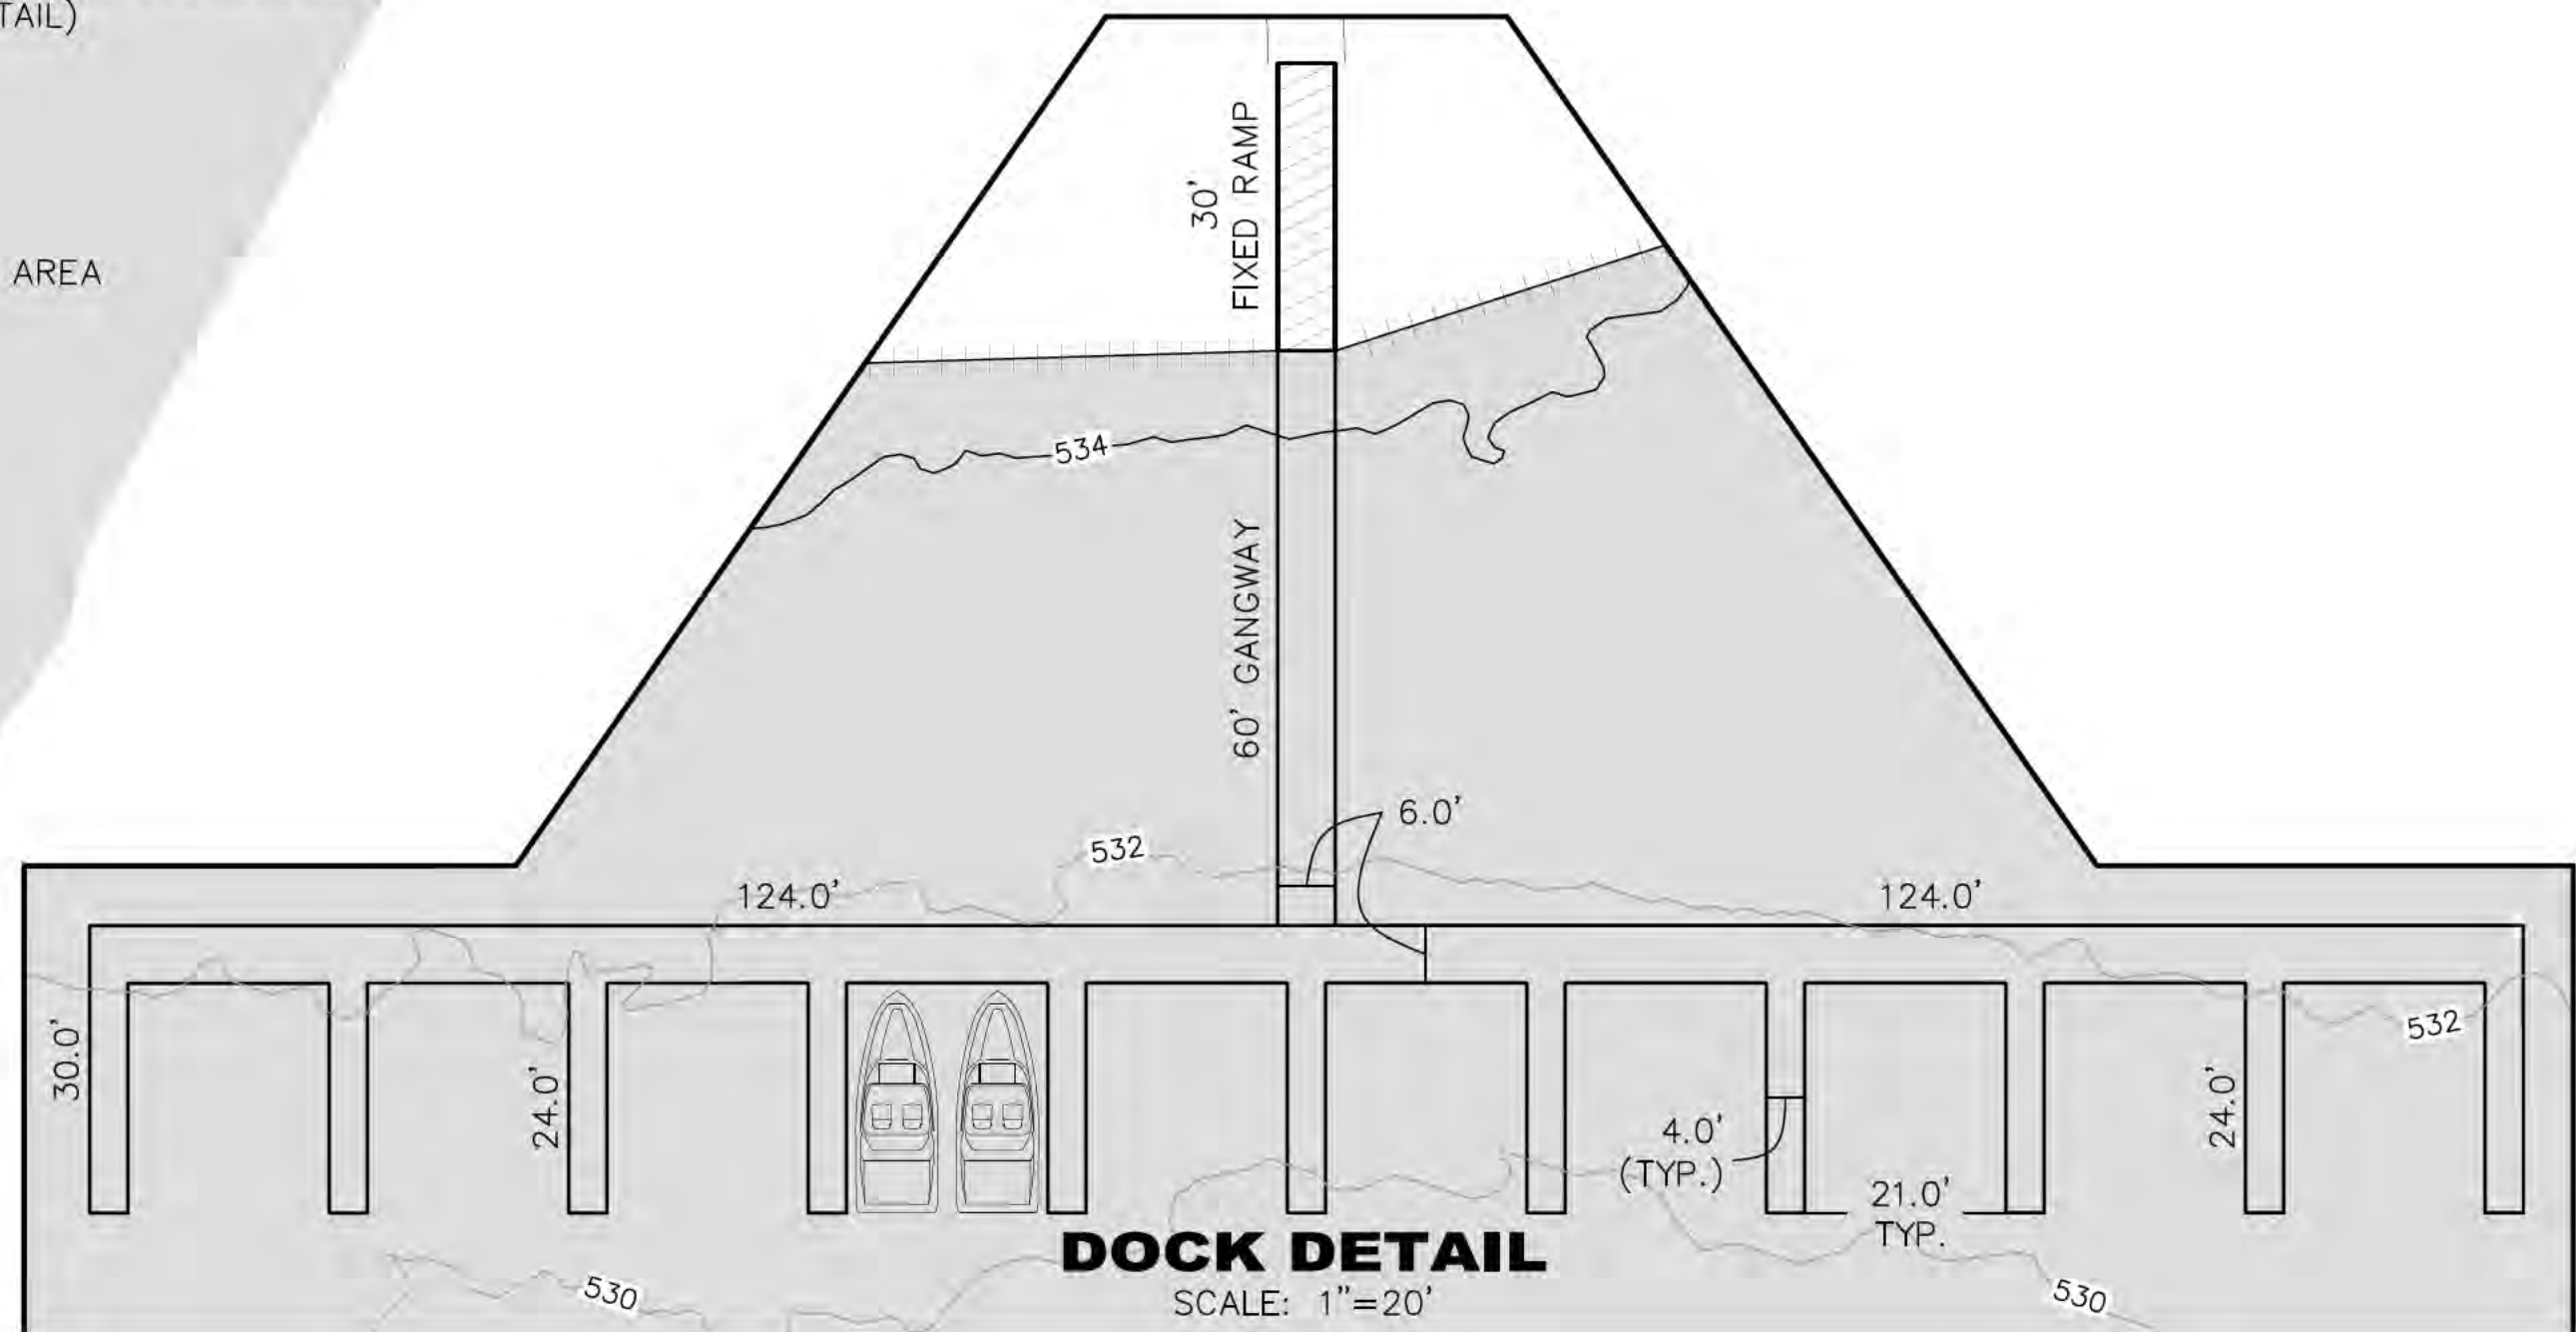


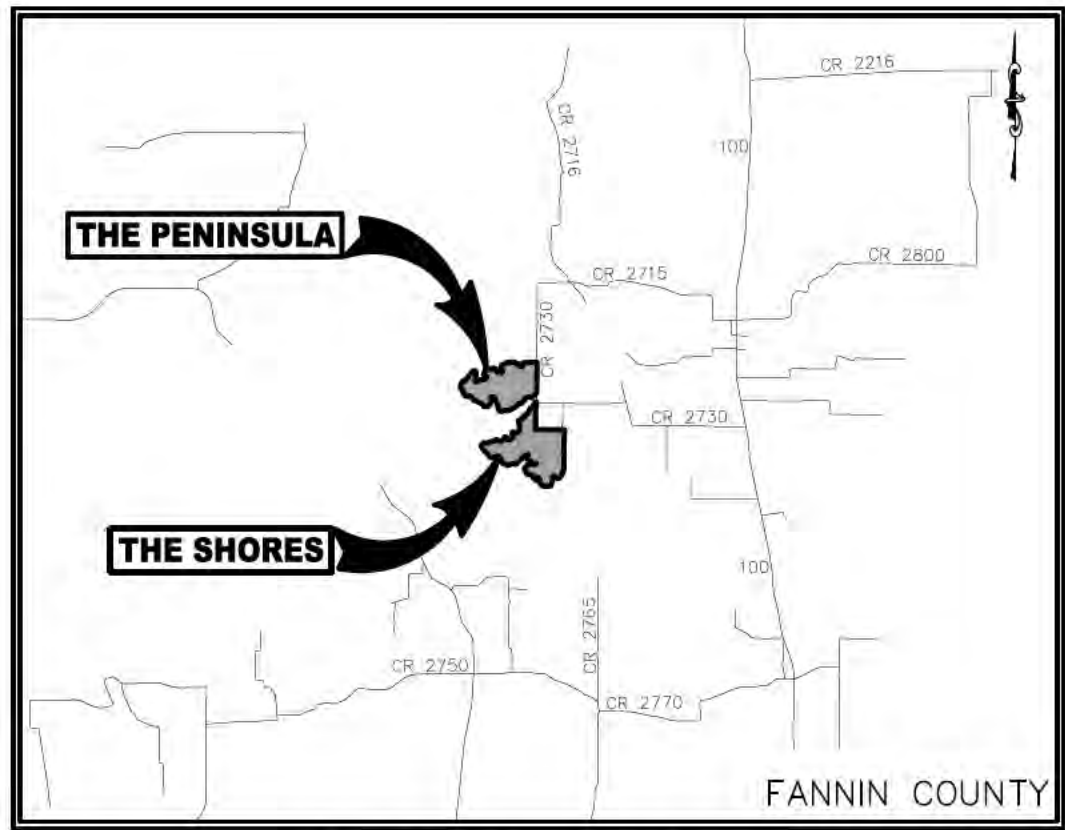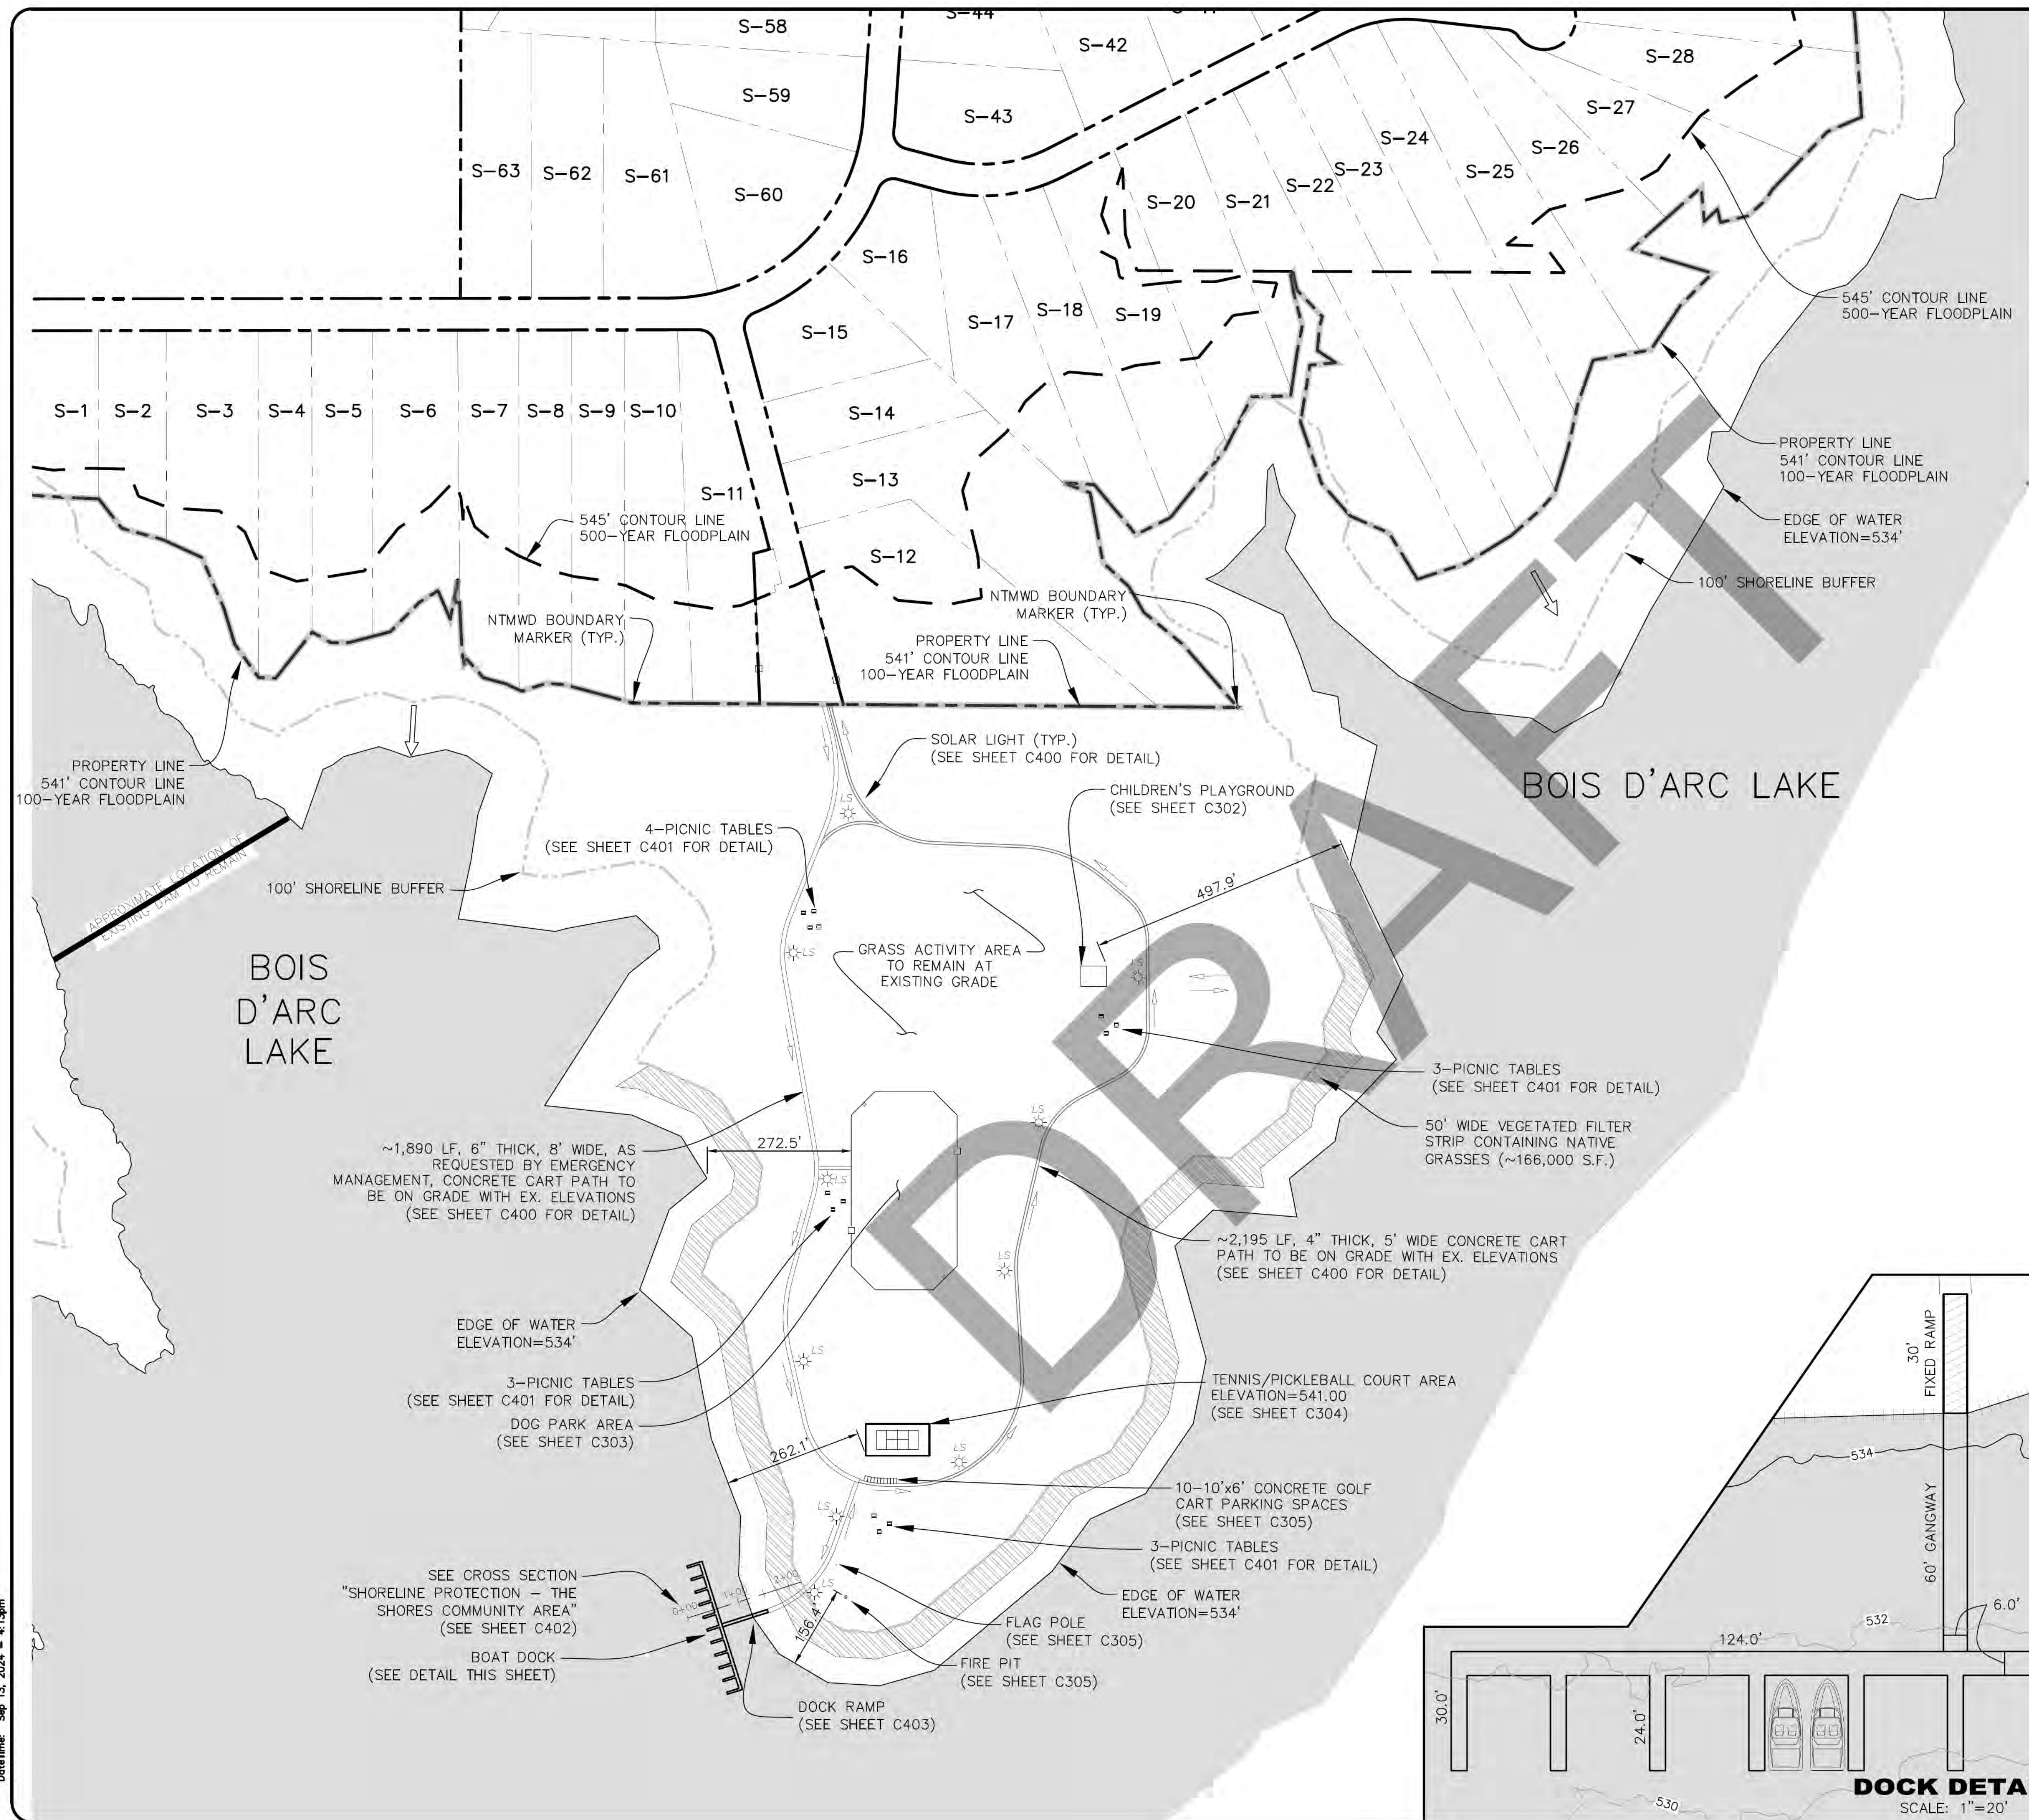VICINITY MAP
(NOT TO SCALE)

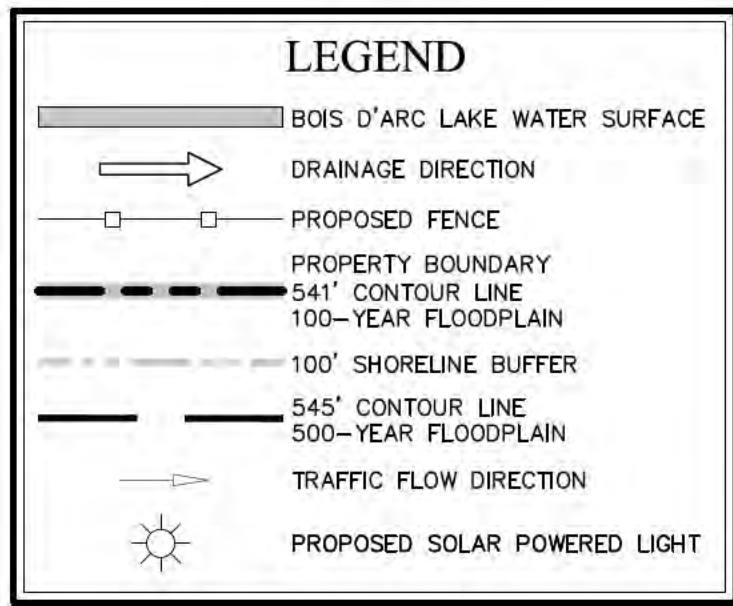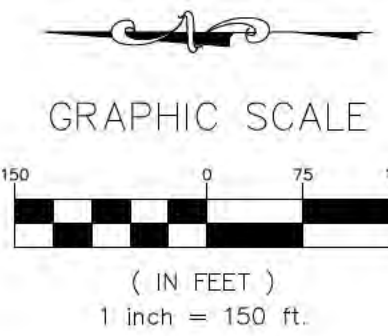

NOTES

1. REFERENCE SEPARATE DOCK PLANS FOR STRUCTURAL, ELECTRICAL AND ELEVATIONS.
2. ALL ELEVATIONS SHOWN ARE BASED ON CONTOUR DATA OBTAINED FROM THE TNRS DATABASE. VERIFY ELEVATIONS PRIOR TO CONSTRUCTION.
3. ALL DISTURBED AREAS BELOW THE 541' CONTOUR LINE SHALL BE RESTORED TO PRE-DEVELOPED CONDITIONS.
4. POSITIVE DRAINAGE SHALL BE PROVIDED AT ALL LOCATIONS.
5. SEE SHEET C400-C402 FOR DETAILS.
6. NO LAND DISTURBING ACTIVITIES ON NTMWD SHALL OCCUR WITHOUT PRIOR WRITTEN AUTHORIZATION FROM NTMWD.
7. NTMWD FLOWAGE EASEMENT CONSISTS OF THAT LAND BETWEEN THE 541' MSL CONTOUR AND 545' MSL CONTOUR.
8. ALL FACILITIES TO BE DESIGNED AND CONSTRUCTED TO CONFORM TO ADA STANDARDS.
9. ALL LIGHTING SHOWN TO BE INDIVIDUAL SOLAR POWERED.
10. EXACT ALIGNMENT OF ALL PATHS ON NTMWD PROPERTY TO BE DETERMINED BY NTMWD PRIOR TO CONSTRUCTION.
11. EXCEPT AS SHOWN ON THESE PLANS, ALL NTMWD BOUNDARY MARKERS SHALL BE PLACED BY THE INDIVIDUAL LOT OWNERS.
12. THE PENINSULA PLAT INSTRUMENT #P2023000017.
13. THE SHORES AT THE PENINSULA PLAT INSTRUMENT #P2023000018.
14. A SIGNAGE PLAN WILL BE REQUIRED PRIOR TO CONSTRUCTION.



DOCK DETAIL
SCALE: 1"=20'

ABBOTT
CONSULTING &
ENGINEERING, LLC



P.O. Box 997
Canton, TX 75103
Bran@abbott-ce.com
Phone: (214) 616-0787
Texas Firm # F-21189

THE PENINSULA &
THE SHORES AT
BOIS D'ARC LAKE
FANNIN COUNTY, TEXAS

THE SHORES COMMUNITY
AREA SITE PLAN

09/13/2024

REVISIONS		COMMENTS	
NO.	DATE	DESCRIPTION	BY





09/13/2024

SHEET NO.
C300

THE PENINSULA & THE SHORES - Fannin County, Texas - ACE Project No. 23158-03

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Date/Time: Sep 13, 2024 - 4:14pm

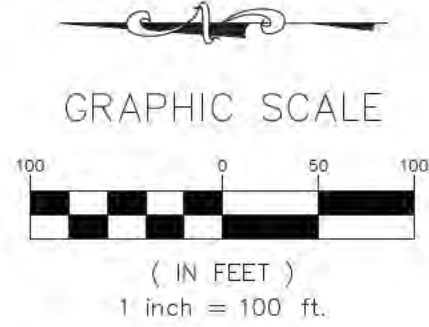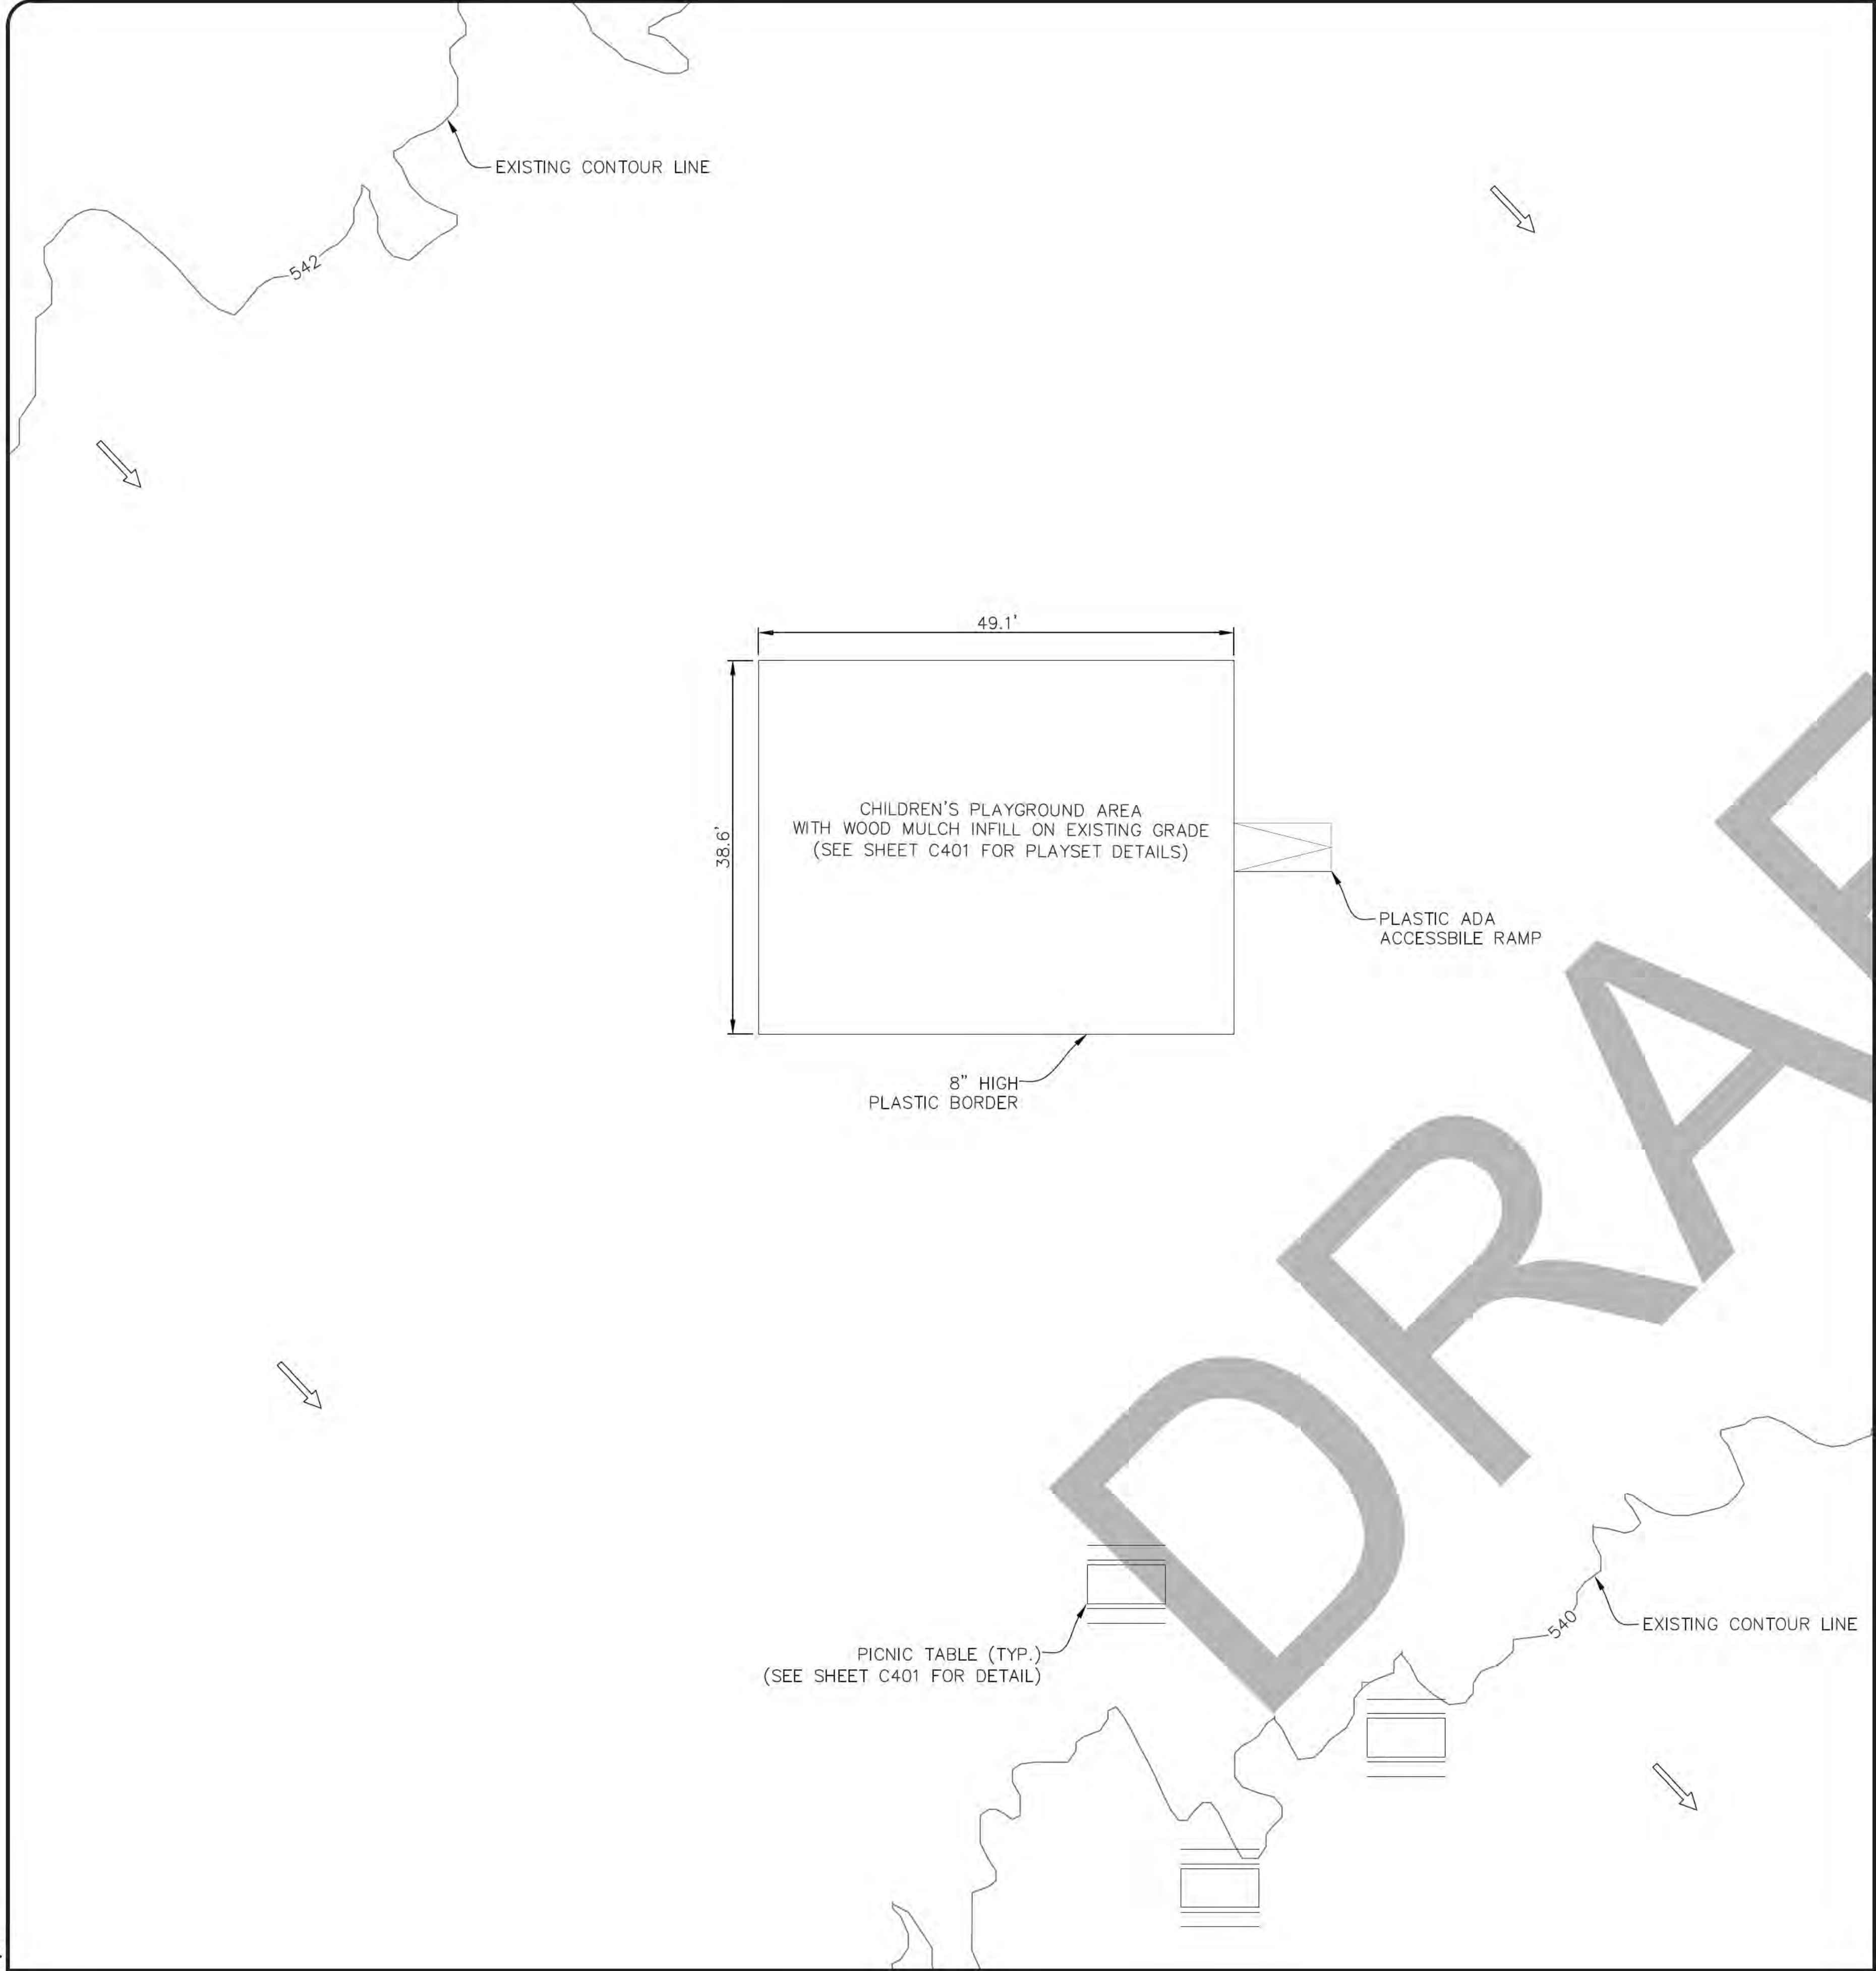

NOTES

1. REFERENCE SEPARATE DOCK PLANS FOR STRUCTURAL, ELECTRICAL AND ELEVATIONS.
2. ALL ELEVATIONS SHOWN ARE BASED ON CONTOUR DATA OBTAINED FROM THE TNRS DATABASE. VERIFY ELEVATIONS PRIOR TO CONSTRUCTION.
3. ALL DISTURBED AREAS BELOW THE 541' CONTOUR LINE SHALL BE RESTORED TO PRE-DEVELOPED CONDITIONS.
4. POSITIVE DRAINAGE SHALL BE PROVIDED AT ALL LOCATIONS.
5. SEE SHEET C400-C402 FOR DETAILS.
6. NO LAND DISTURBING ACTIVITIES ON NTMWD SHALL OCCUR WITHOUT PRIOR WRITTEN AUTHORIZATION FROM NTMWD.
7. NTMWD FLOWAGE EASEMENT CONSISTS OF THAT LAND BETWEEN THE 541' MSL CONTOUR AND 545' MSL CONTOUR.
8. ALL FACILITIES TO BE DESIGNED AND CONSTRUCTED TO CONFORM TO ADA STANDARDS.
9. ALL LIGHTING SHOWN TO BE INDIVIDUAL SOLAR POWERED.
10. EXACT ALIGNMENT OF ALL PATHS ON NTMWD PROPERTY TO BE DETERMINED BY NTMWD PRIOR TO CONSTRUCTION.
11. EXCEPT AS SHOWN ON THESE PLANS, ALL NTMWD BOUNDARY MARKERS SHALL BE PLACED BY THE INDIVIDUAL LOT OWNERS.
12. THE PENINSULA PLAT INSTRUMENT #P2023000017.
13. THE SHORES AT THE PENINSULA PLAT INSTRUMENT #P2023000018.
14. CONTOURS SHOWN ARE FROM THE TEXAS NATURAL RESOURCES INFORMATION SYSTEM (TNRS) DATAHUB DATED 04/21/2021.

REVISIONS		COMMENTS	
#	DATE		



SHEET NO.
C302

THE PENINSULA &
THE SHORES AT
BOIS D'ARC LAKE
FANNIN COUNTY, TEXAS


THE SHORES
CHILDREN'S PLAYGROUND
09/13/2024



**ABBOTT
CONSULTING &
ENGINEERING, LLC**

P.O. Box 997
Canton, TX 75103
Brian@abbott-ce.com

Phone: (214) 616-0787
Texas Firm # F-21189

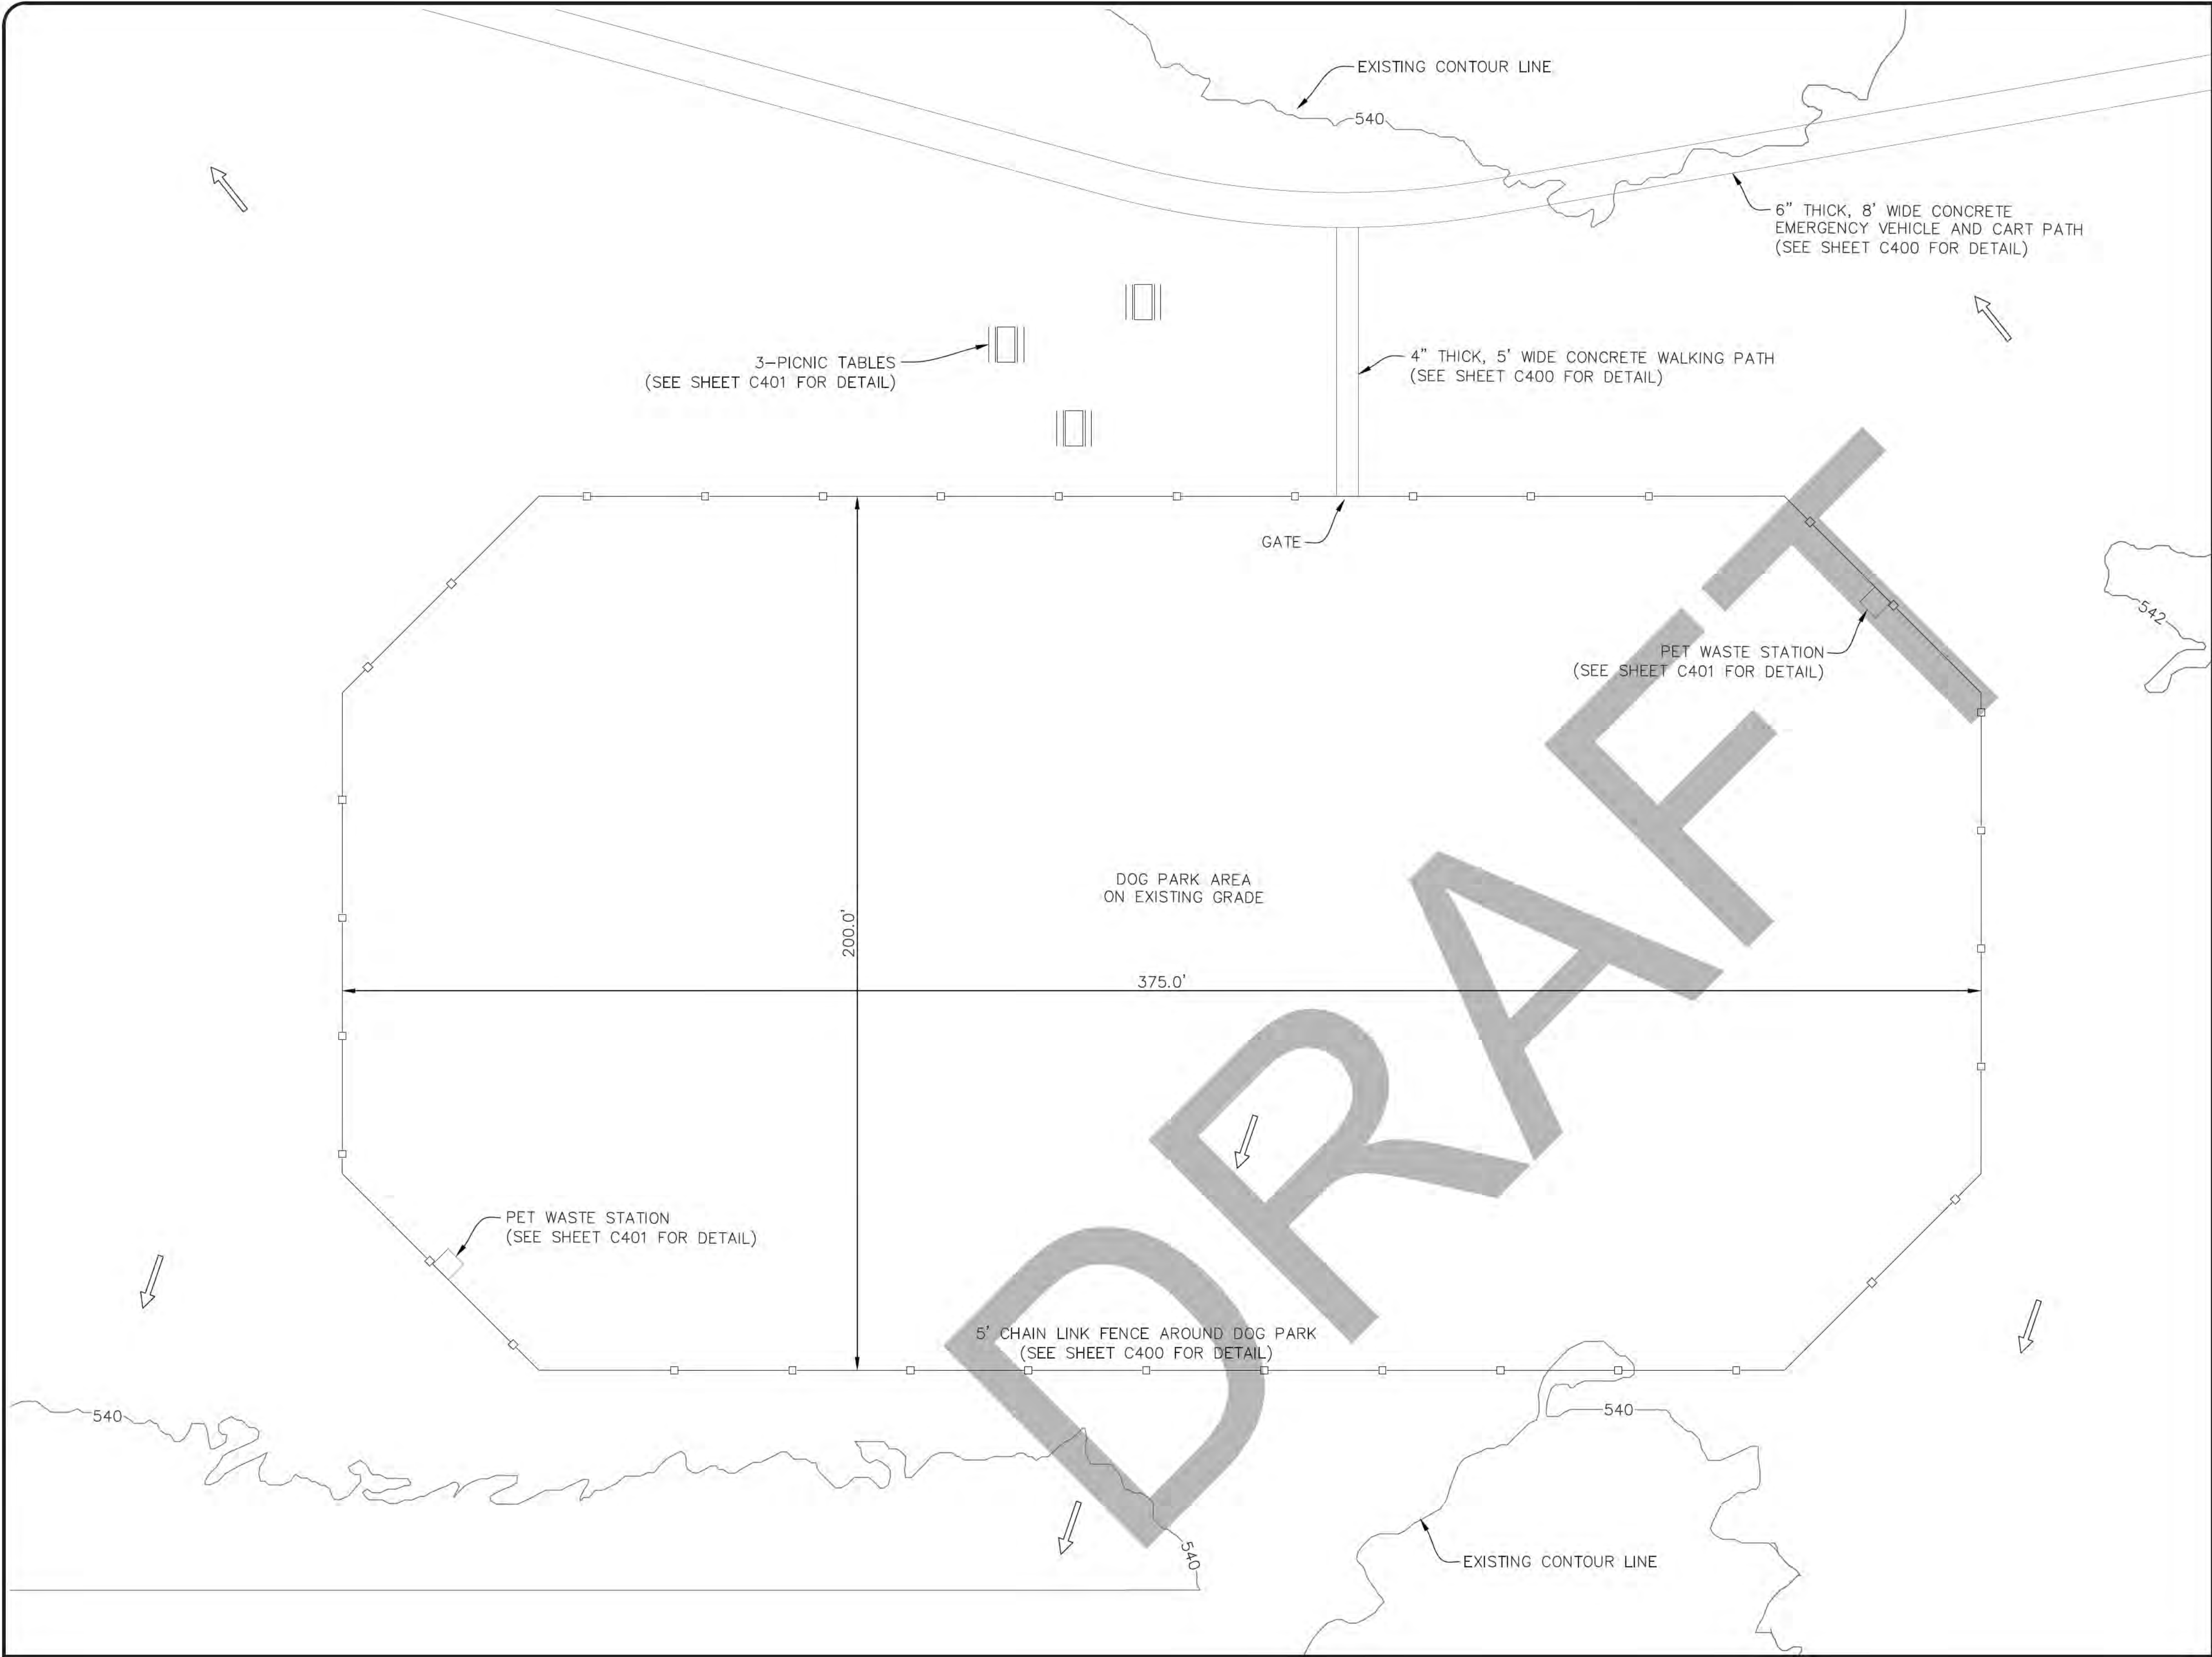

GRAPHIC SCALE

(IN FEET)
1 inch = 20 ft.

LEGEND

→ DRAINAGE DIRECTION

NOTES

1. REFERENCE SEPARATE DOCK PLANS FOR STRUCTURAL, ELECTRICAL AND ELEVATIONS.
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14. CONTOURS SHOWN ARE FROM THE TEXAS NATURAL RESOURCES INFORMATION SYSTEM (TNRS) DATAHUB DATED 04/21/2021.

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Canton, TX 75103
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Texas Firm # F-21189

THE PENINSULA &
THE SHORES AT
BOIS D'ARC LAKE
FANNIN COUNTY, TEXAS

THE SHORES
DOG PARK


09/13/2024

REVISIONS		COMMENTS	
#	DATE		




SHEET NO.
C303

Drawing File: C:\5_G40_23159-03.dwg
Date/Time: Sep 13, 2024 - 4:14pm

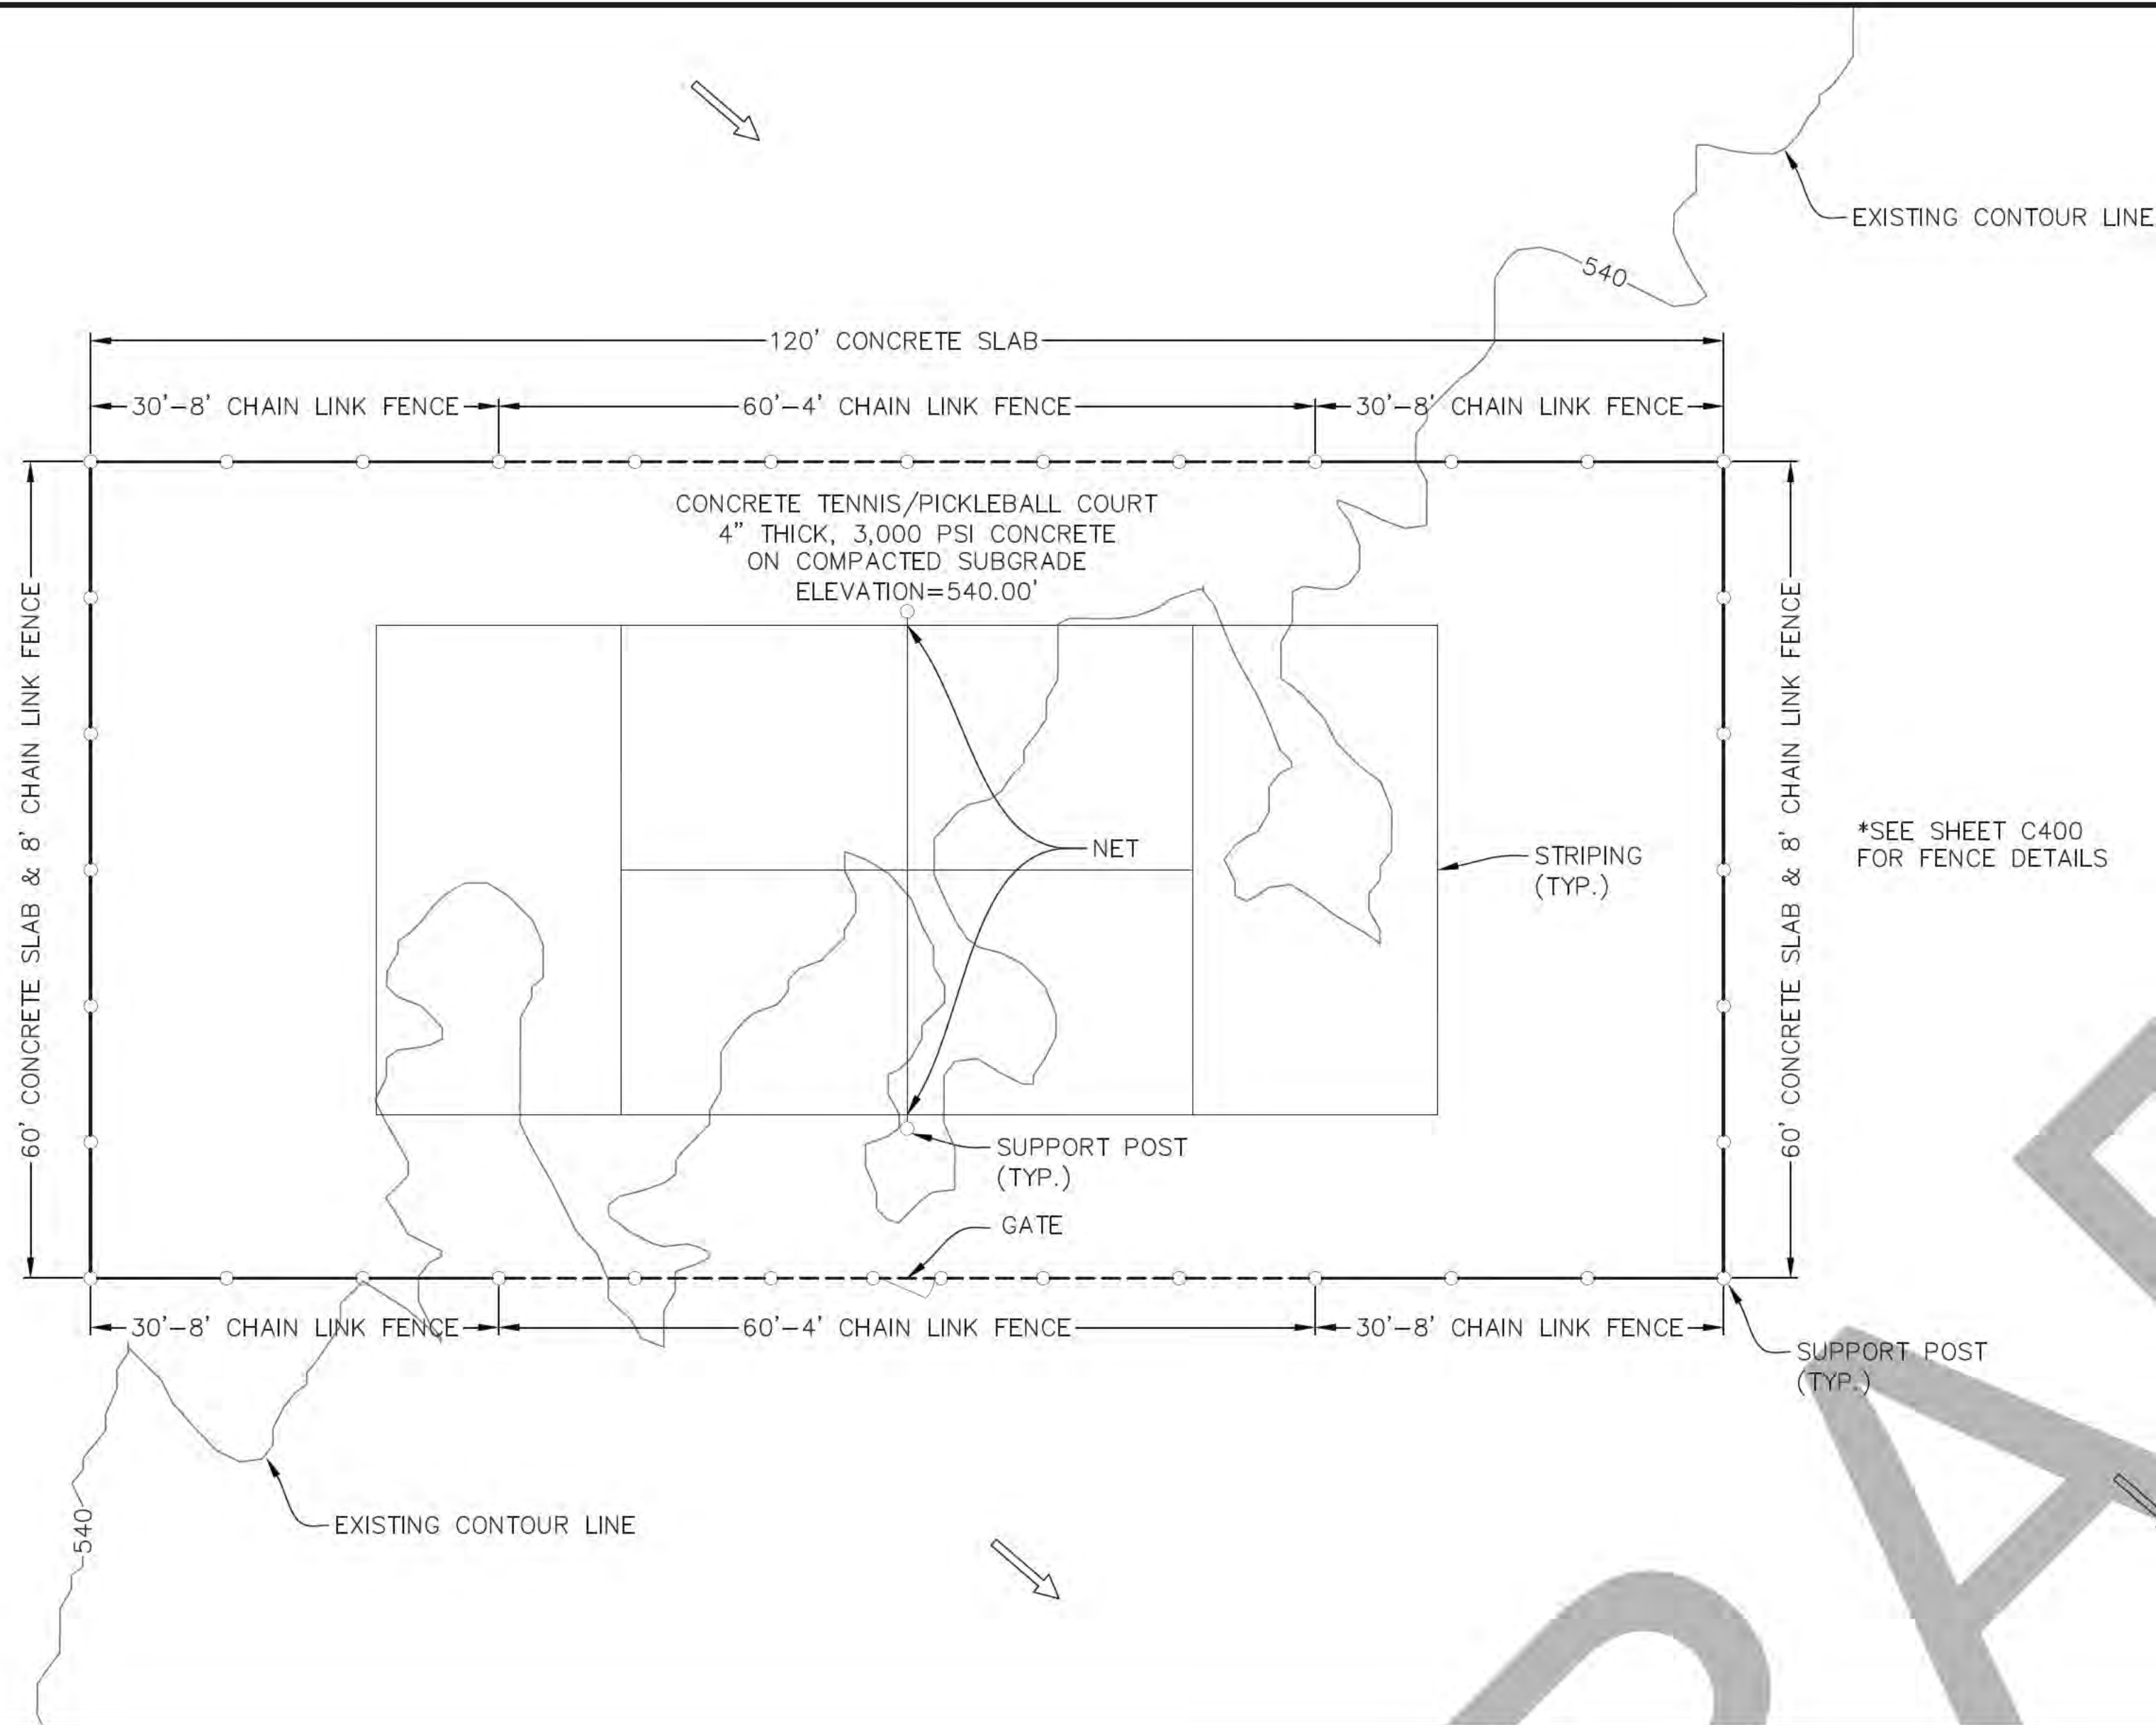

*SEE SHEET C400
FOR FENCE DETAILS

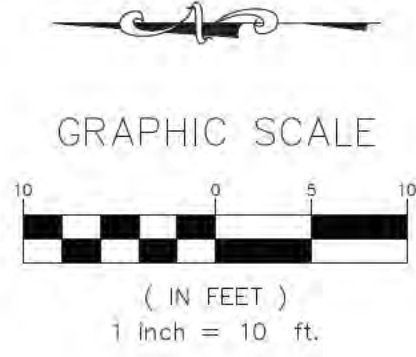

NOTES

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13. THE SHORES AT THE PENINSULA PLAT INSTRUMENT #P2023000018.
14. CONTOURS SHOWN ARE FROM THE TEXAS NATURAL RESOURCES INFORMATION SYSTEM (TNRS) DATAHUB DATED 04/21/2021.

THE SHORES TENNIS/
PICKLEBALL COURT

09/13/2024

REVISIONS		COMMENTS	
#	DATE		



09/13/2024

SHEET NO.
C304

THE PENINSULA &
THE SHORES AT
BOIS D'ARC LAKE
FANNIN COUNTY, TEXAS


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CONSULTING &
ENGINEERING, LLC




P.O. Box 997
Canton, TX 75103
Brian@abbott-ce.com
Phone: (214) 616-0787
Texas Firm # F-21189

THE PENINSULA & THE SHORES - Fannin County, Texas - ACE Project No. 23159-03


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Date/Time: Sep 13, 2024 - 4:14pm

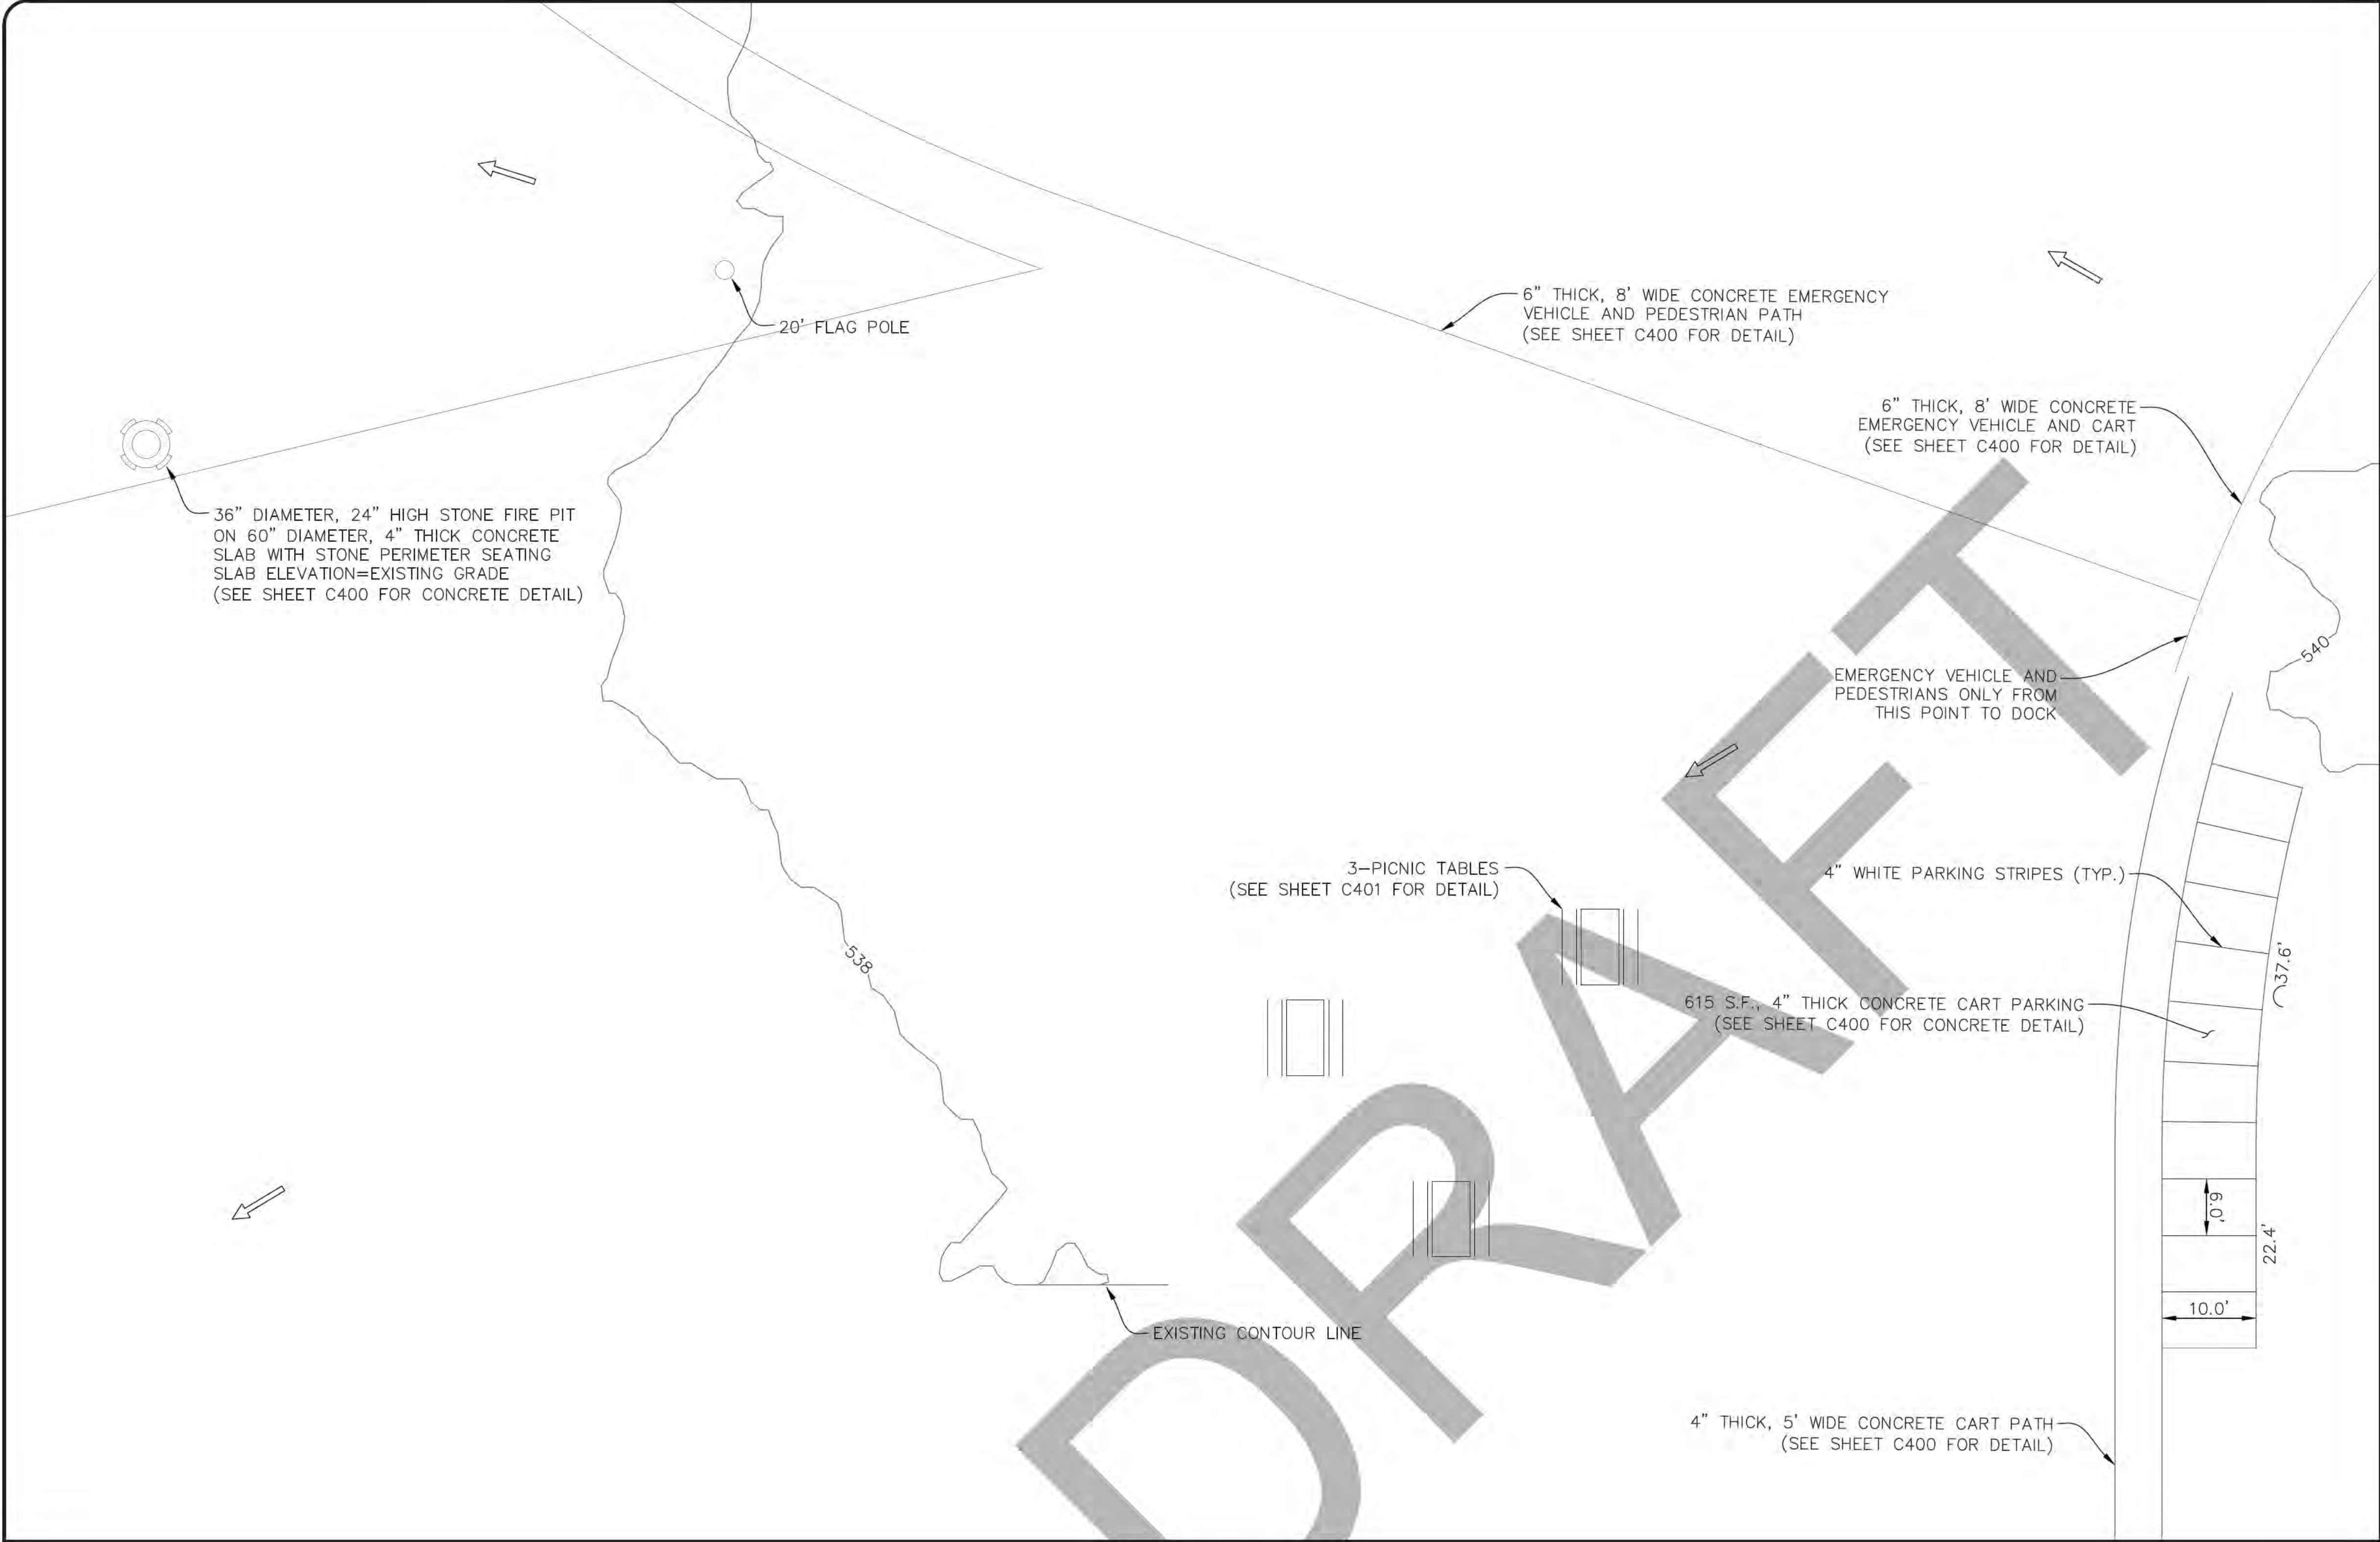

- NOTES**
1. REFERENCE SEPARATE DOCK PLANS FOR STRUCTURAL, ELECTRICAL AND ELEVATIONS.
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 11. EXCEPT AS SHOWN ON THESE PLANS, ALL NTMWD BOUNDARY MARKERS SHALL BE PLACED BY THE INDIVIDUAL LOT OWNERS.
 12. ADEQUATE TURNAROUND SPACE SHALL BE PROVIDED ADJACENT TO GOLF CART PARKING AREA.
 13. THE PENINSULA PLAT INSTRUMENT #P2023000017.
 14. THE SHORES AT THE PENINSULA PLAT INSTRUMENT #P2023000018.
 15. CONTOURS SHOWN ARE FROM THE TEXAS NATURAL RESOURCES INFORMATION SYSTEM (TNRIS) DATAHUB DATED 04/21/2021.

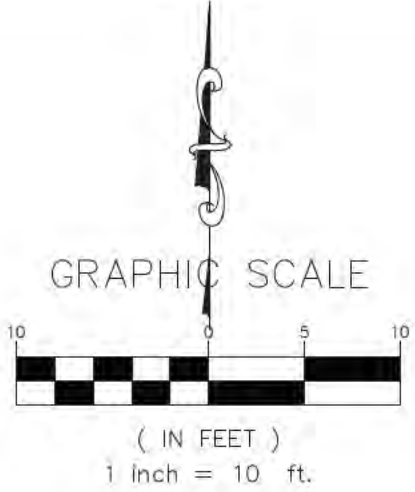

REVISIONS		COMMENTS	
#	DATE		

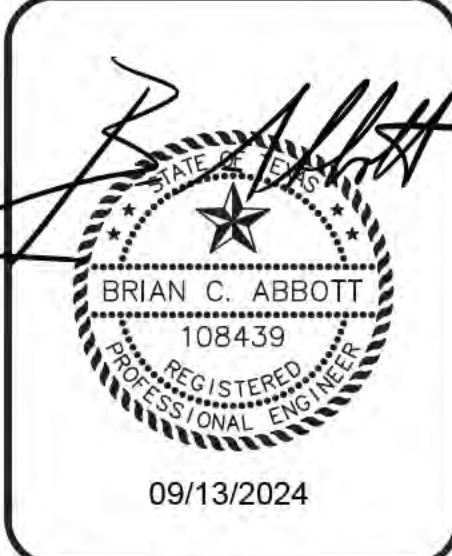

SHEET NO.
C305

THE SHORES CART PARKING
FIRE PIT, AND FLAG POLE

09/13/2024

THE PENINSULA &
THE SHORES AT
BOIS D'ARC LAKE
FANNIN COUNTY, TEXAS




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P.O. Box 997
Canton, TX 75103
Brian@abbott-ce.com


Phone: (214) 616-0787
Texas Firm # F-21189

THE PENINSULA & THE SHORES - Fannin County, Texas - ACE Project No. 23159-03

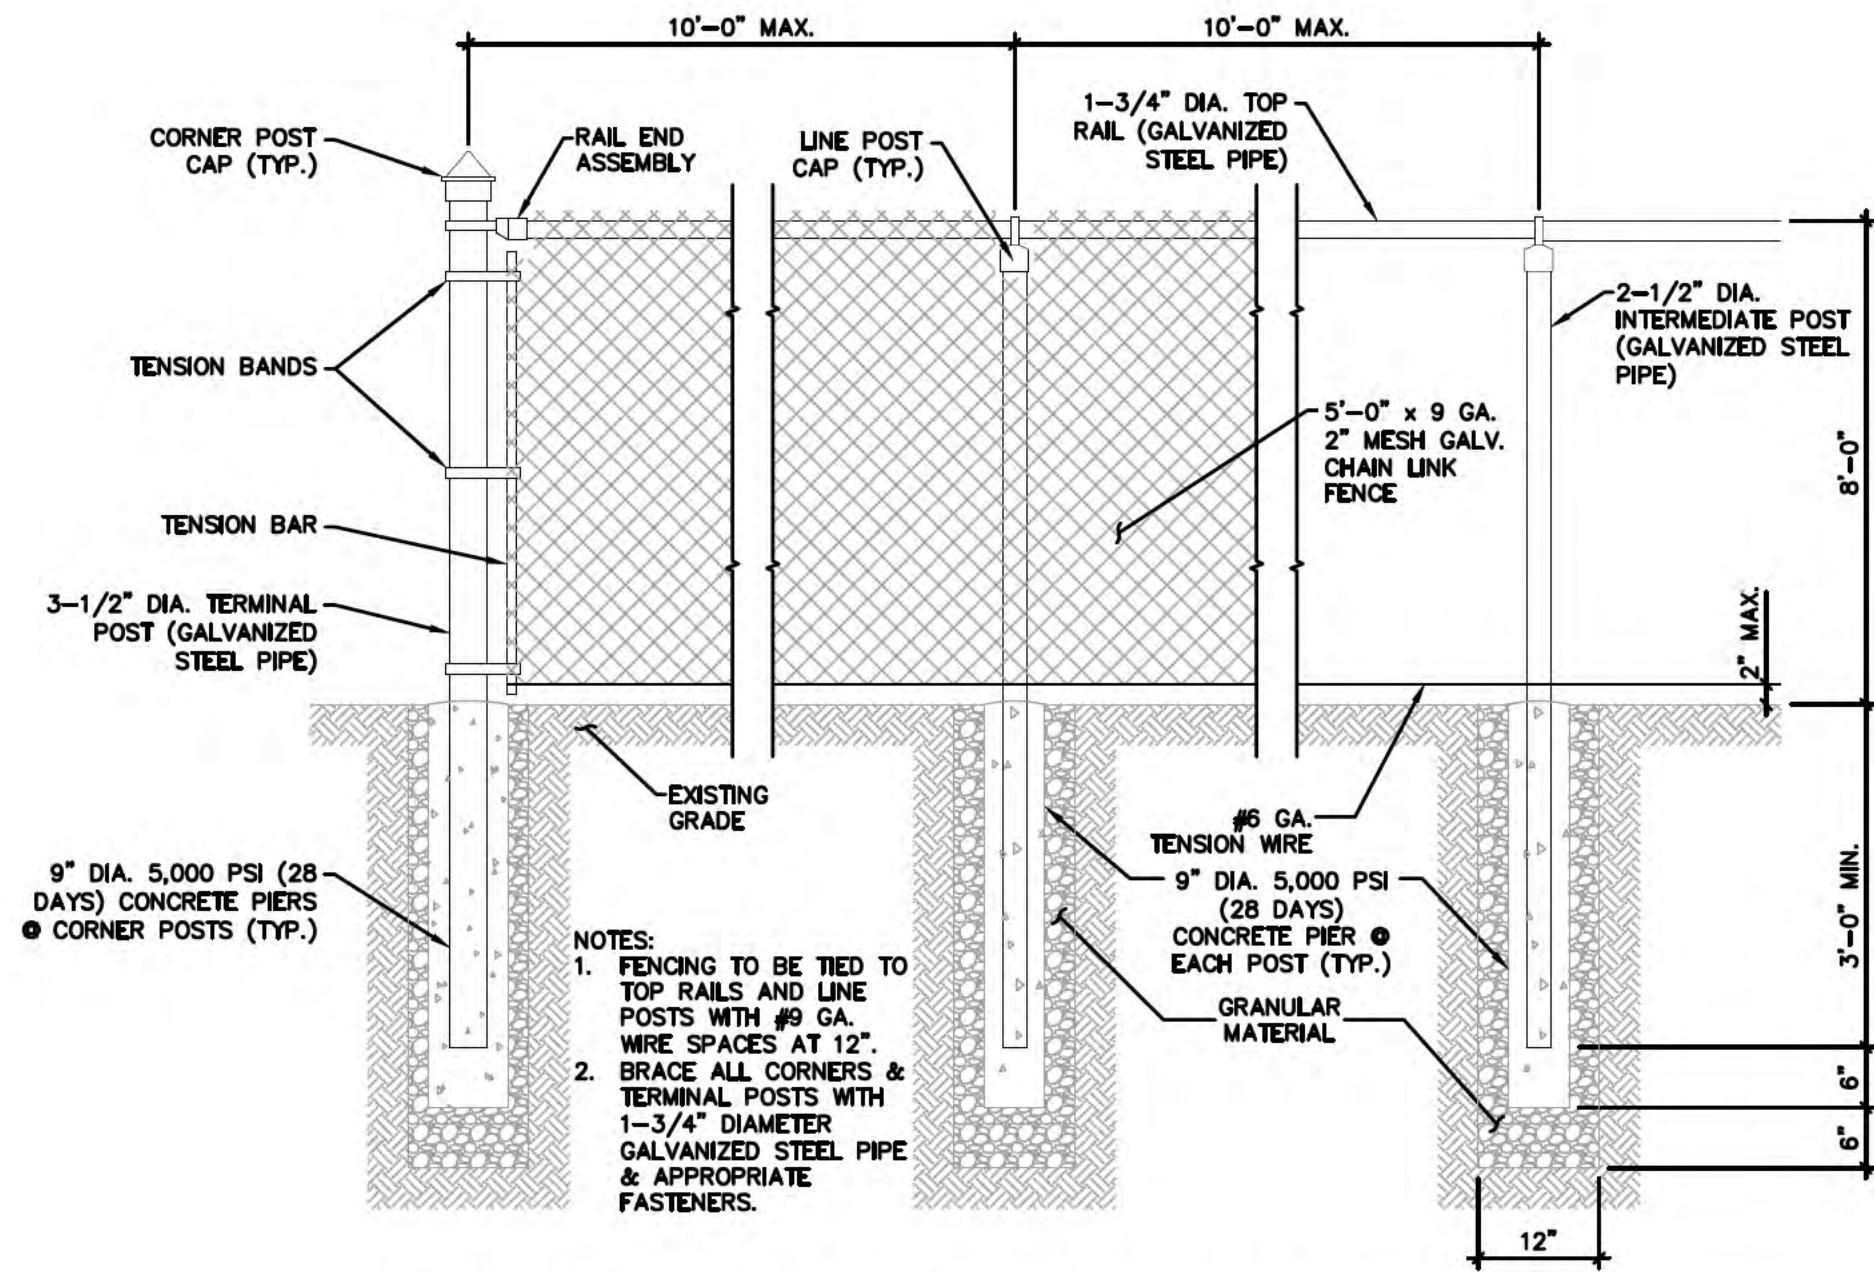


5' CHAIN LINK FENCE - DOG PARK

NTS

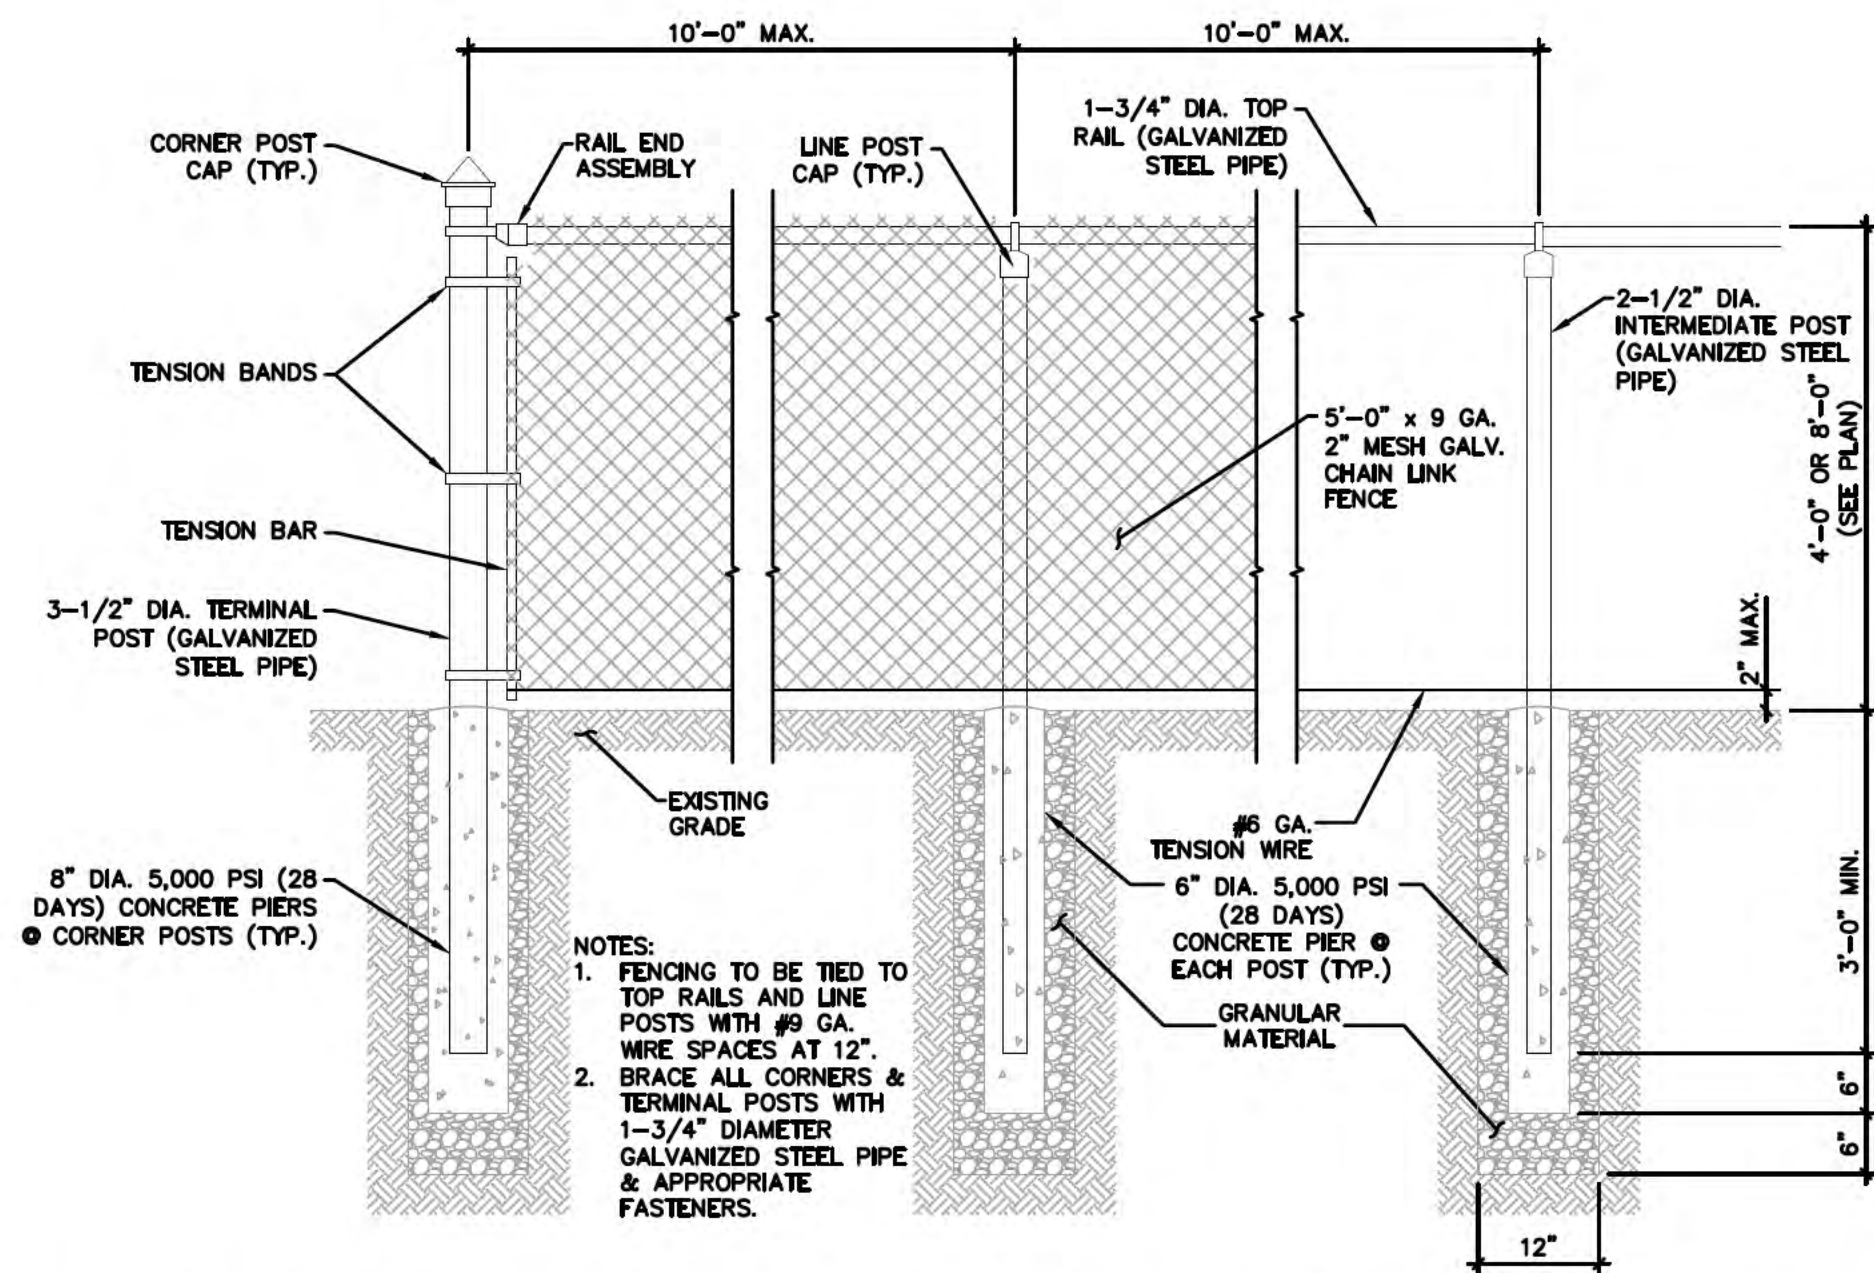

4'8" CHAIN LINK FENCE - TENNIS/PICKLEBALL COURT

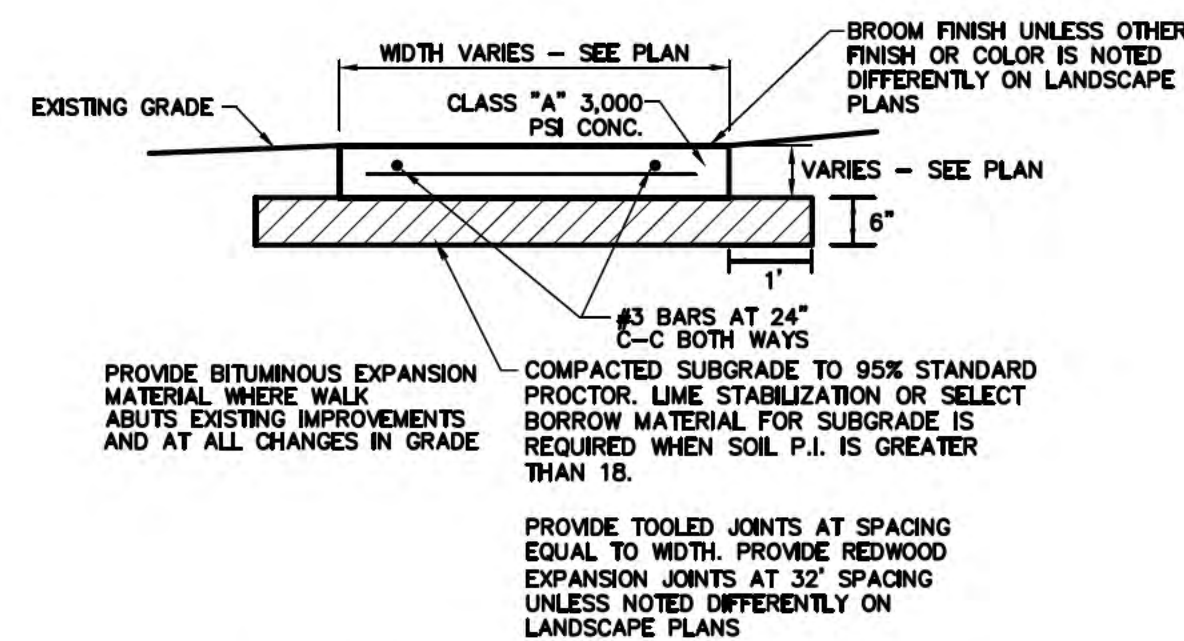

CONCRETE SECTION

STAINLESS STEEL BOLLARD SOLAR LAMP SERIES
WITH MINI EZ ANCHOR

100 LUMENS, 12 HOURS, 3.2V, 1W, 2 YEAR WARRANTY

The Gama Sonic CS-214 Stainless Steel Bollard Solar Lamp is designed with stainless-steel to last throughout the years for a lifetime of enjoyment.

- Powered by efficient tempered glass monocrystalline solar panel
- Automatic dusk to dawn operation
- The Gama Sonic Stainless Steel solar lamp duration will last 12 hours in the HIGH setting once all batteries have been fully charged in the direct sun
- Cast-aluminum weather resistant structure
- Maintenance free
- (2) Li-Ion Rechargeable Battery Included (3.2V/1900mAh) (12A)
- Black and Silver Finish

Model #	Part #	Dimensions (in)	UPC	LED color
CS-214 Silver	214801	8L x 8W x 24.25H	853153005961	
CS-214 Black	214001	8L x 8W x 24.25H	853153007202	Warm White (2700K)

Pkg. Qty.	Pkg. Size (in)	Pkg. Wgt. (lbs)
1	15.5L x 19W x 7.5H	6
1	15.5L x 19W x 7.5H	6

GAMA SONIC SOLAR LIGHTING
GAMA SONIC USA, INC.
PHONE 1-800 835 4173
FAX 1-800 835 4173
commercial@gamasonic.com
www.gamasonic.com

SOLAR LIGHTS FOR SIDEWALK

NTS

GS SOLAR LED light bulb
a U.S. Utility Patent-No. 9458970

The GS Solar LED light bulb boasts a 10-year lifespan (approximately 50,000 hours) for use in Gama Sonic solar-powered lamps.

Model #	Part #	COLOR LIGHT
A-60 27 LEDs	A60WW30W	Warm White
A-60 27 LEDs	A60BW30W	Bright White
A-60 15 LEDs	A60WW25W	Warm White
A-60 15 LEDs	A60BW25W	Bright White
A-60 11 LEDs	A60WW20W	Warm White
A-60 11 LEDs	A60BW20W	Bright White

Model #	Part #	COLOR LIGHT
A-50	A50WW10W	Bright White
A-50	A50BW10W	Warm White
C-37	C37WW10W	Warm White
C-37	C37BW10W	Bright White
T-45	T45WW10W	Warm White
F-37	F30WW05W	Warm White

GAMA SONIC SOLAR LIGHTING
GAMA SONIC USA, INC.
PHONE 1-800 835 4173
FAX 1-800 835 4173
info@gamasonic.com
www.gamasonic.com

IMPERIAL III SOLAR LAMP SERIES
Install anywhere around your property

300 LUMENS, 36-72 HOURS, 5 YEAR WARRANTY, 8W, DUAL-COLOR (BRIGHT/WHITE), BATTERY: LI-ION

Each Imperial III lamp head provides a stunning 300 lumens of bright-white light or warm-white, making the series ideal for residential and commercial applications.

- Powered by efficient Mono-crystalline Solar Panels
- Integrated switch allows user to conveniently toggle between 2700K (Warm White) and 6000K (Bright White)
- High/Low switch controls brightness and duration
- Automatic dusk to dawn operation
- The Imperial III solar light duration will last 72 hours in the LOW setting and 36 hours in the HIGH setting once all batteries have been fully charged in the direct sun
- Cast-aluminum weather resistant structure
- Maintenance free
- (4) Li-Ion Rechargeable Batteries Included (3.2V/5000mAh) (12A)
- Matte Black Finish

Model #	Part #	Dimensions (in)	UPC	LED color
97K012	97K012	10.5L x 10.5W x 10.5H	853153005961	
97NWK10	97NWK10	10.5L x 10.5W x 10.5H	853153007202	Warm White (2700K)
97KF20	97KF20	10.5L x 10.5W x 10.5H	853153007202	Bright White (6000K)
97KF30	97KF30	10.5L x 10.5W x 10.5H	853153007202	Bright White (6000K)

GAMA SONIC SOLAR LIGHTING
GAMA SONIC USA, INC.
PHONE 1-800 835 4173
FAX 1-800 835 4173
commercial@gamasonic.com
www.gamasonic.com

SOLAR LIGHTS FOR GOLF CART TRAIL

NTS



GAMA SONIC GS-97SP 6.5 FT STANDARD POST - 3" FITTER


ABBOTT CONSULTING & ENGINEERING, LLC



THE PENINSULA & THE SHORES AT BOIS D'ARC LAKE
FANNIN COUNTY, TEXAS

CONSTRUCTION DETAILS

REVISIONS	DATE	COMMENTS

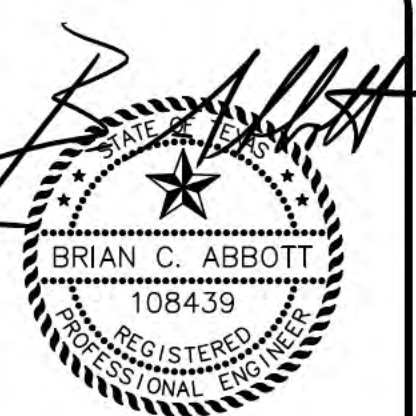

09/13/2024

SHEET NO. C400

09/13/2024

Phone: (214) 616-0787
Texas Firm # F-21189
P.O. Box 997
Canton, TX 75103
Bran@abbott-ce.com
THE PENINSULA & THE SHORES - Fannin County, Texas - ACE Project No. 23158-03

Drawing File: C2 DETAILS 23158-03.dwg
Date/Time: Sep 13, 2024 - 4:16pm

GENERAL SPECIFICATIONS:

MANUFACTURER'S QUALIFICATIONS

Highland Products Group maintains at all times a quality control program as herein outlines so as to insure that all precast meets all requirements as specified under physical requirements. All precast shall be manufactured by skilled workmen who have at least five years experience in similar work and supervised by foreman certified by the ACI (American Concrete Institute).

MANUFACTURING

All precast work shall be true to dimension and have clean, accurate arises and details faithfully executed. Reinforcing steel shall conform to work and shall have a minimum compressive strength of 5,000 psi at 28 days of age when tested by means of cylinder molds (6x12) from the materials. There shall be a maximum of 4-6% air entrainment for all precast according to ASTM standards.

REINFORCEMENT

All concrete products have reinforcement characteristics such as rebar or fiberglass.

MOLDS

The forms for the precast units shall be constructed of metal or fiberglass laminated designed to withstand casting pressures without distortion. All anchors, inserts, bolts, ect. will be placed and secured in the forms as required for the attachment and handling of the units. These shall be clamped so as to hold them in position during fabrication.

PHYSICAL CHARACTERISTICS

All exposed surfaces are treated to remove the surface matrix and exposed the aggregate produced by chemical retardant - not sand blasting. All precast shall have the water-repellent sealer treatment applied in strict accordance with manufacturer's specifications. All tolerances shall be within 1/8" of specified dimensions, designed for structural analysis and calculation.

COLOR

Color to be uniform throughout as approved by owner or specifier in accordance with manufacturer's recommendation.

MATERIALS

Portland Cement: ASTM C150 Type 1 or 3

All aggregate to meet ASTM C33 Specifications

REQUIRED MATERIALS FOR APPROVAL


A. Shop drawings with dimensions, general contraction component parts, anchoring details and installation.

B. Samples upon request of architects.

C. Complete dates on manufacturer's and technical information.


ITEM: 154-1166

WEIGHT: 1,000 LBS

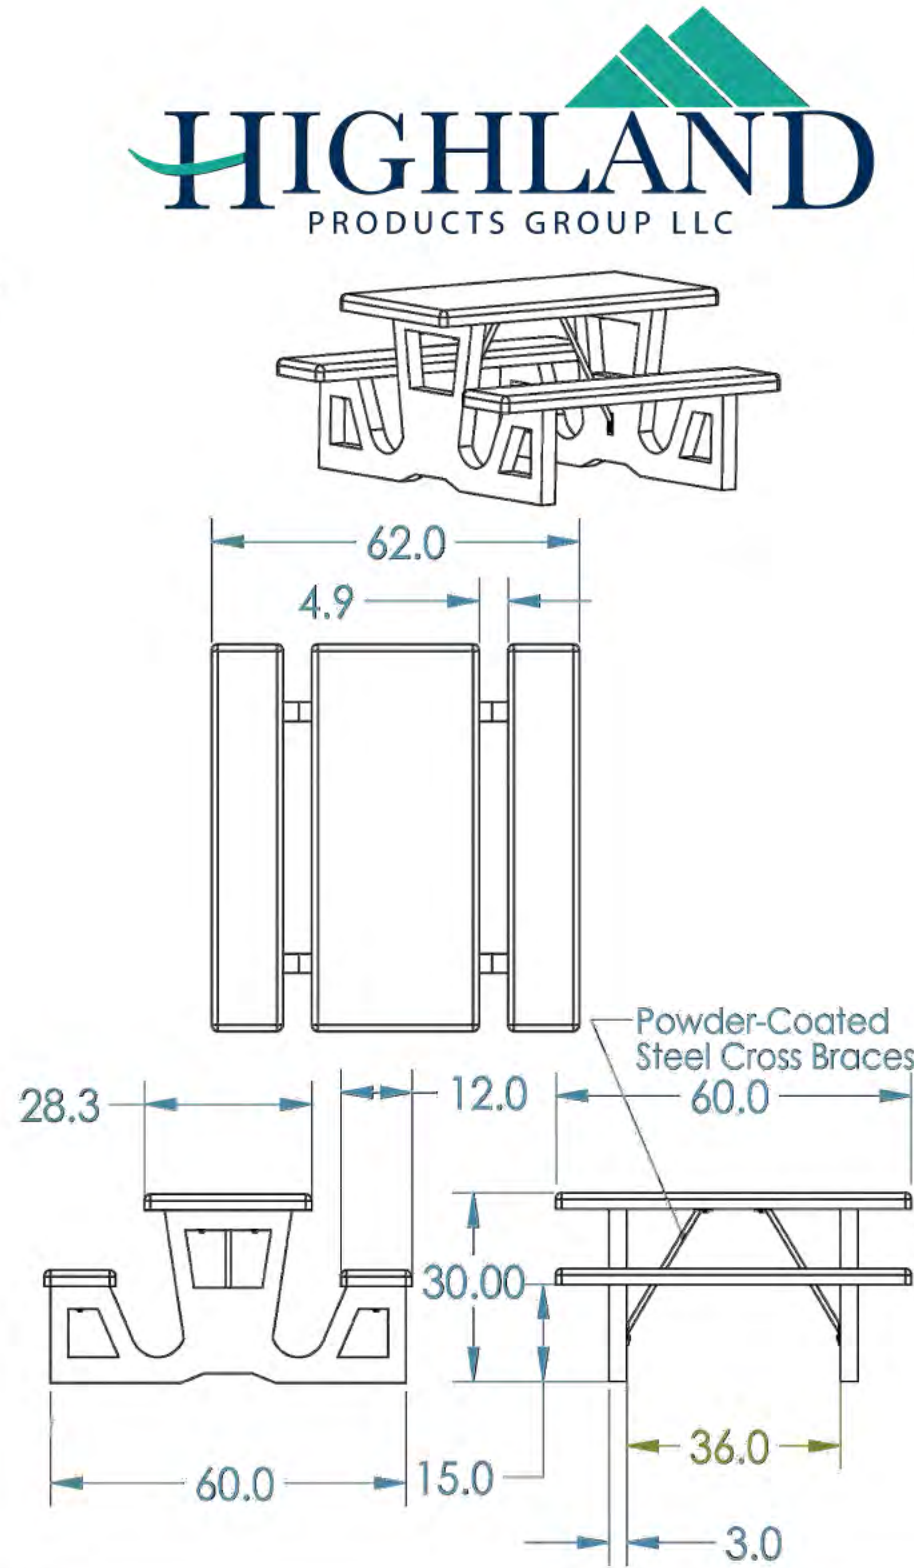

PICNIC TABLE

BC1300 REV# 2 7-15-2016
BC1301
BC1302
BC1303

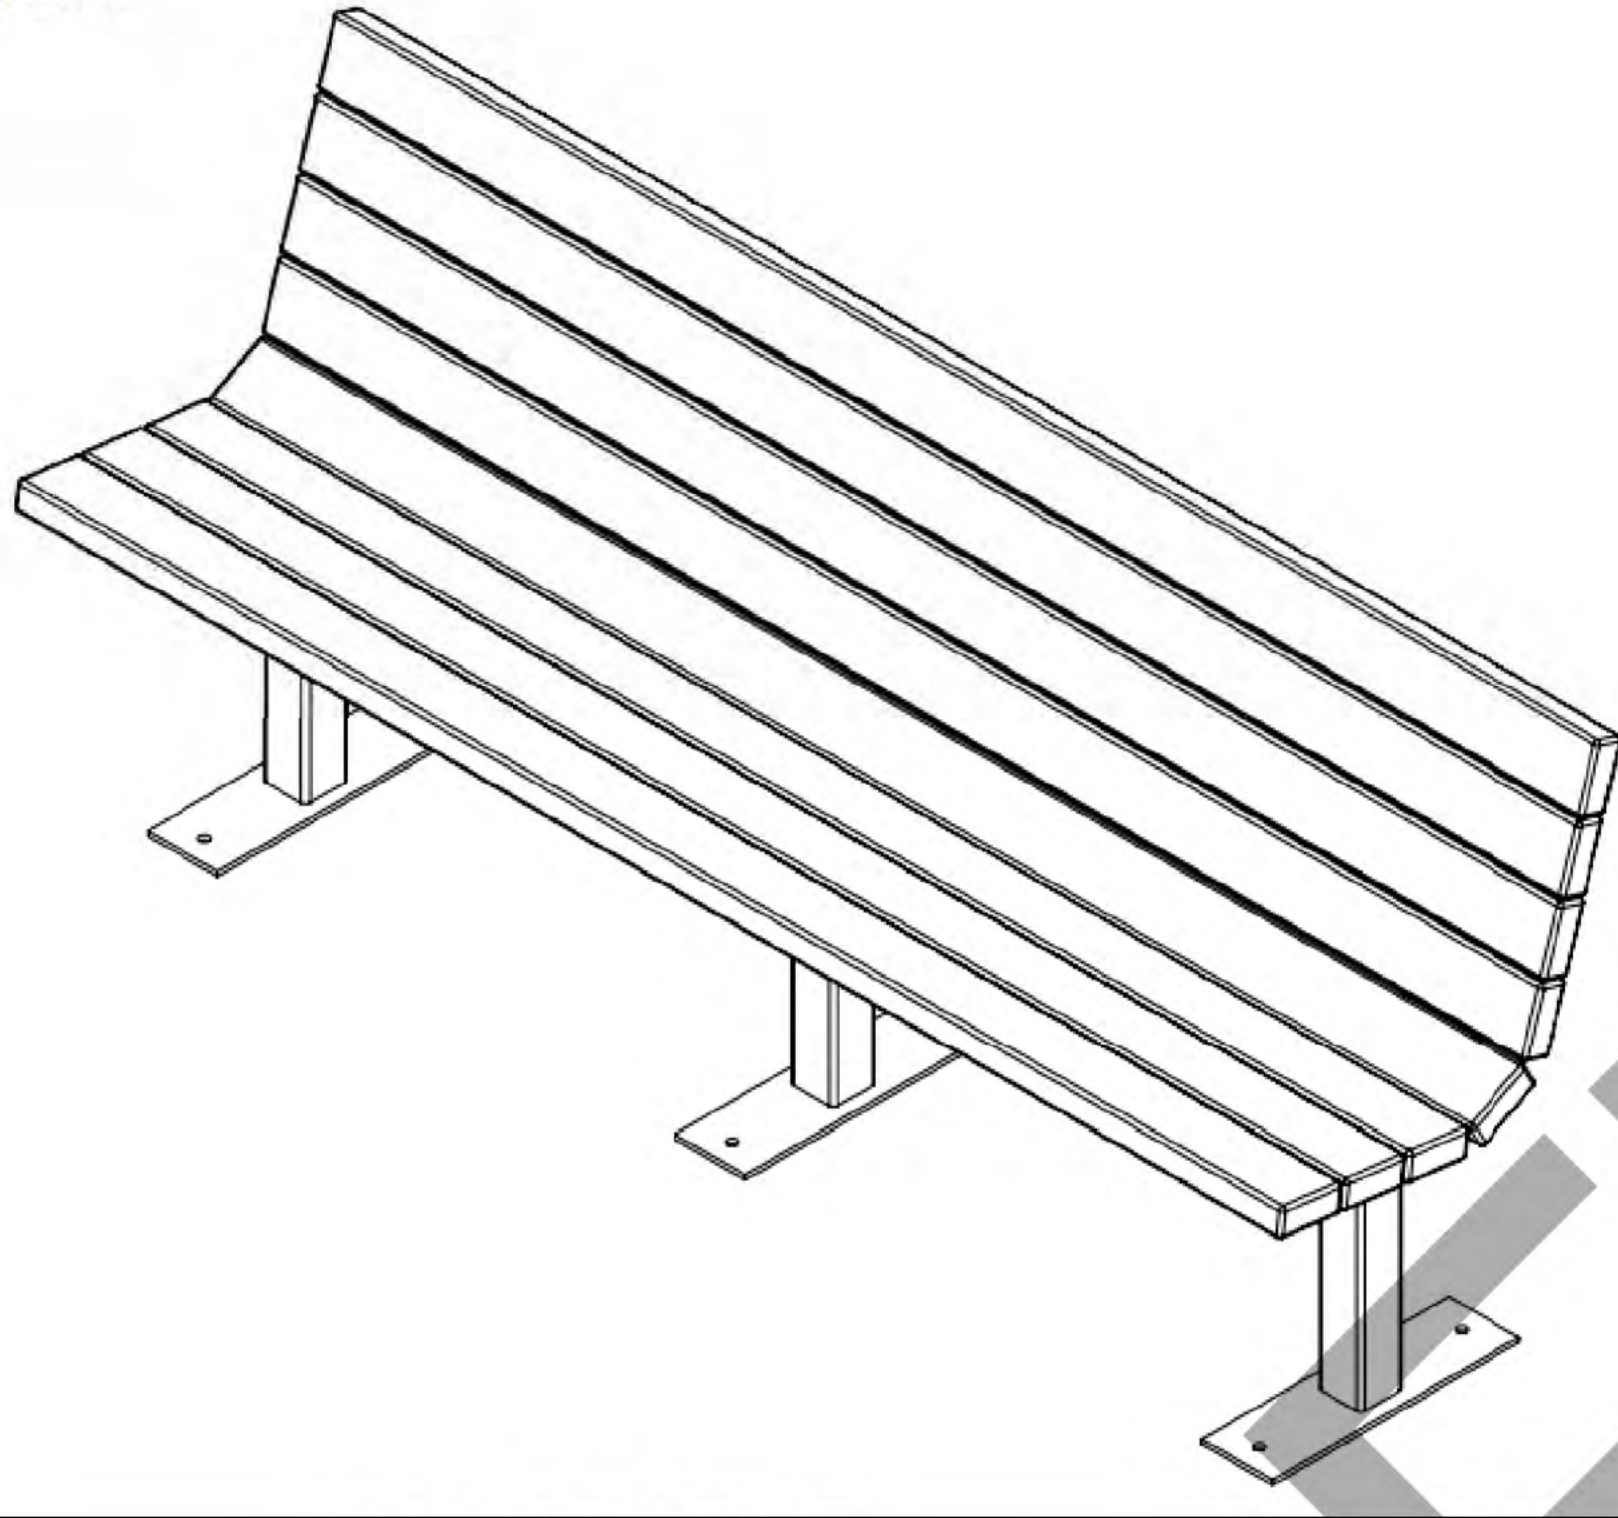

PARK BENCH



PET WASTE STATION




Treasure Hunt - Peacock Colors
Structure 5654-PP

Signature: _____

Note: Colors above are for representational purposes only. Actual colors may vary slightly.

Posts: Spring Green • Decks, Super Sonic Slide, Bongos: Blue • Metals: Sky Blue • Bubble Panel, Surge Climber, Double Super Sonic Slide: Beige

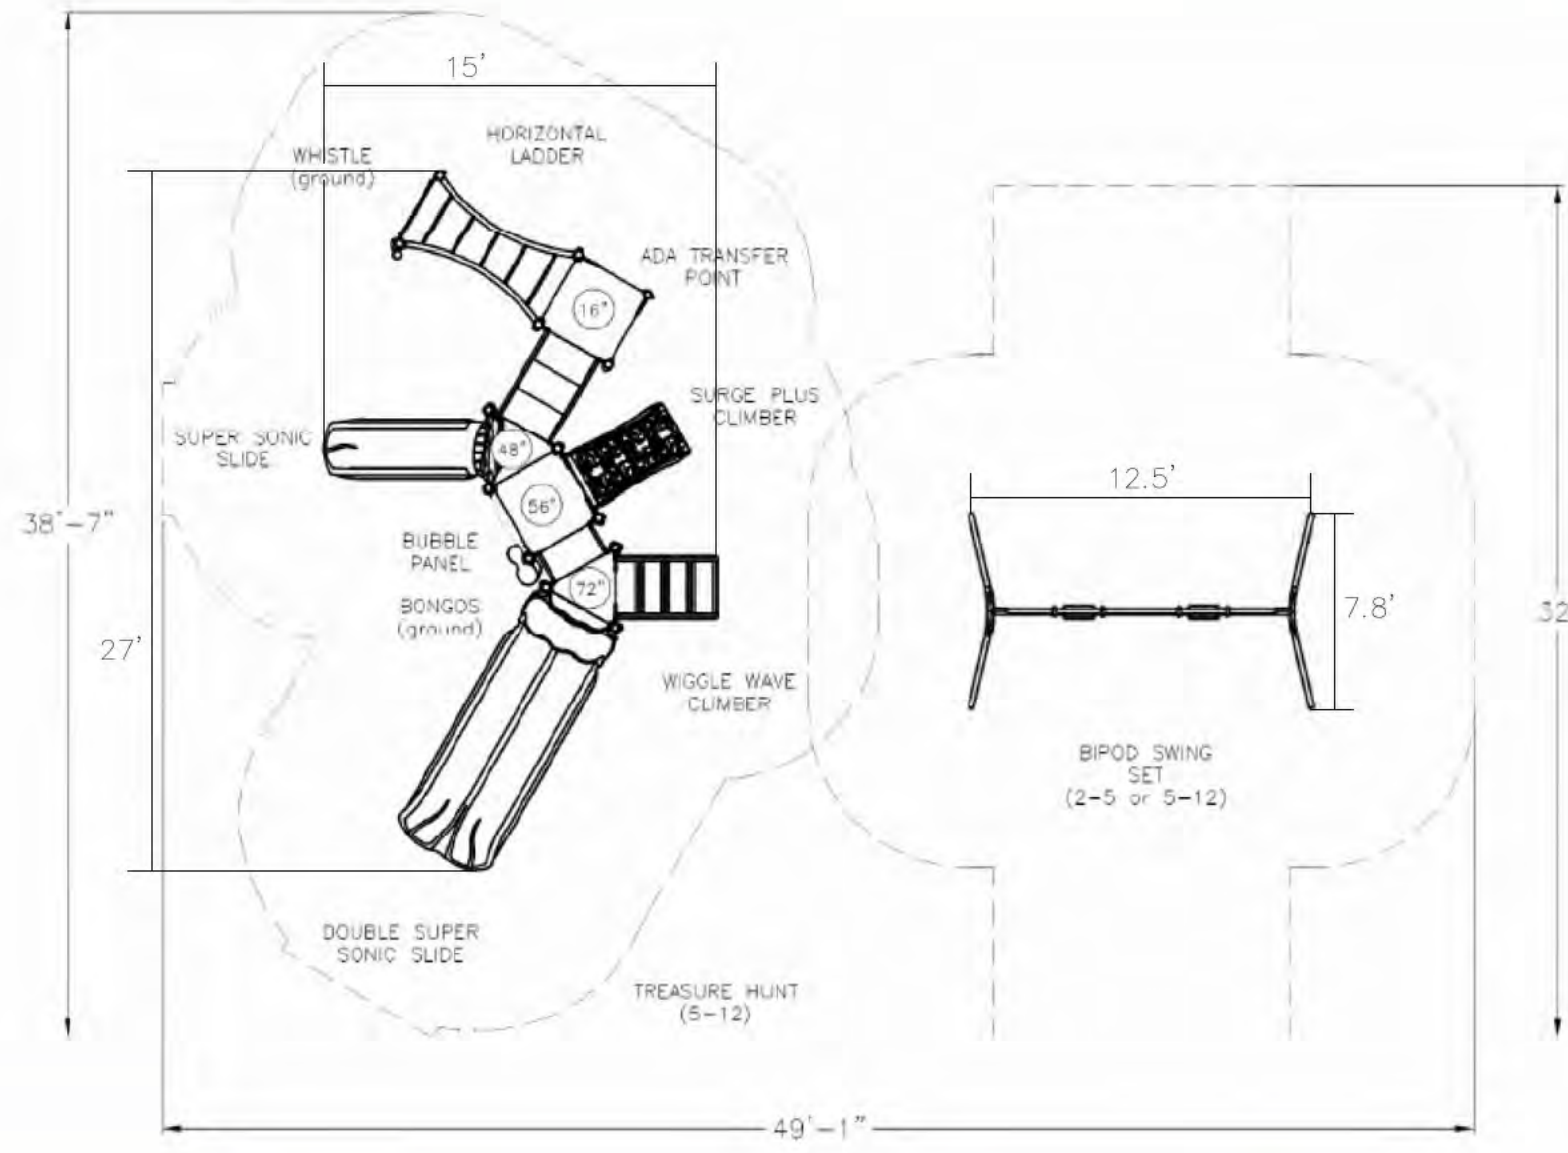

Lakewood Land LLC

Signature: _____

Equipment Age Range: 2-5 or 5-12
Critical Fall Height: 8'
User Capacity: Up to 37
Total Play Components: 9
Total Accessible Components: 8

The above layout:
✓ COMPLIES TO ASTM
✓ COMPLIES TO CPSC
✓ COMPLIES TO ADA

Space Required: 38'-7" x 45'-1"
Surfacing Area: 1,893 s.f.
Surfacing Material: By Others
Surfacing Depth Required: N/A
Border Info: By Others

Drawn By: S. Nance
Date: 4/23/2021
Revision:
Scale: 3/32" = 1'-0"
Drawing scaling possible only when in 8.5" x 11" format




PLAYGROUND

CONSTRUCTION DETAILS

09/13/2024

REVISIONS	COMMENTS	DATE

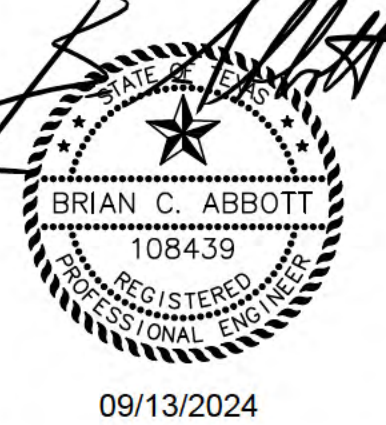

09/13/2024

SHEET NO.
C401


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CONSULTING &
ENGINEERING, LLC




P.O. Box 997
Canton, TX 75103
Brian@abbott-ce.com
Phone: (214) 616-0787
Texas Firm #: F-21189

THE PENINSULA &
THE SHORES AT
BOIS D'ARC LAKE
FANNIN COUNTY, TEXAS


THE PENINSULA & THE SHORES - Fannin County, Texas - ACE Project No. 23158-03

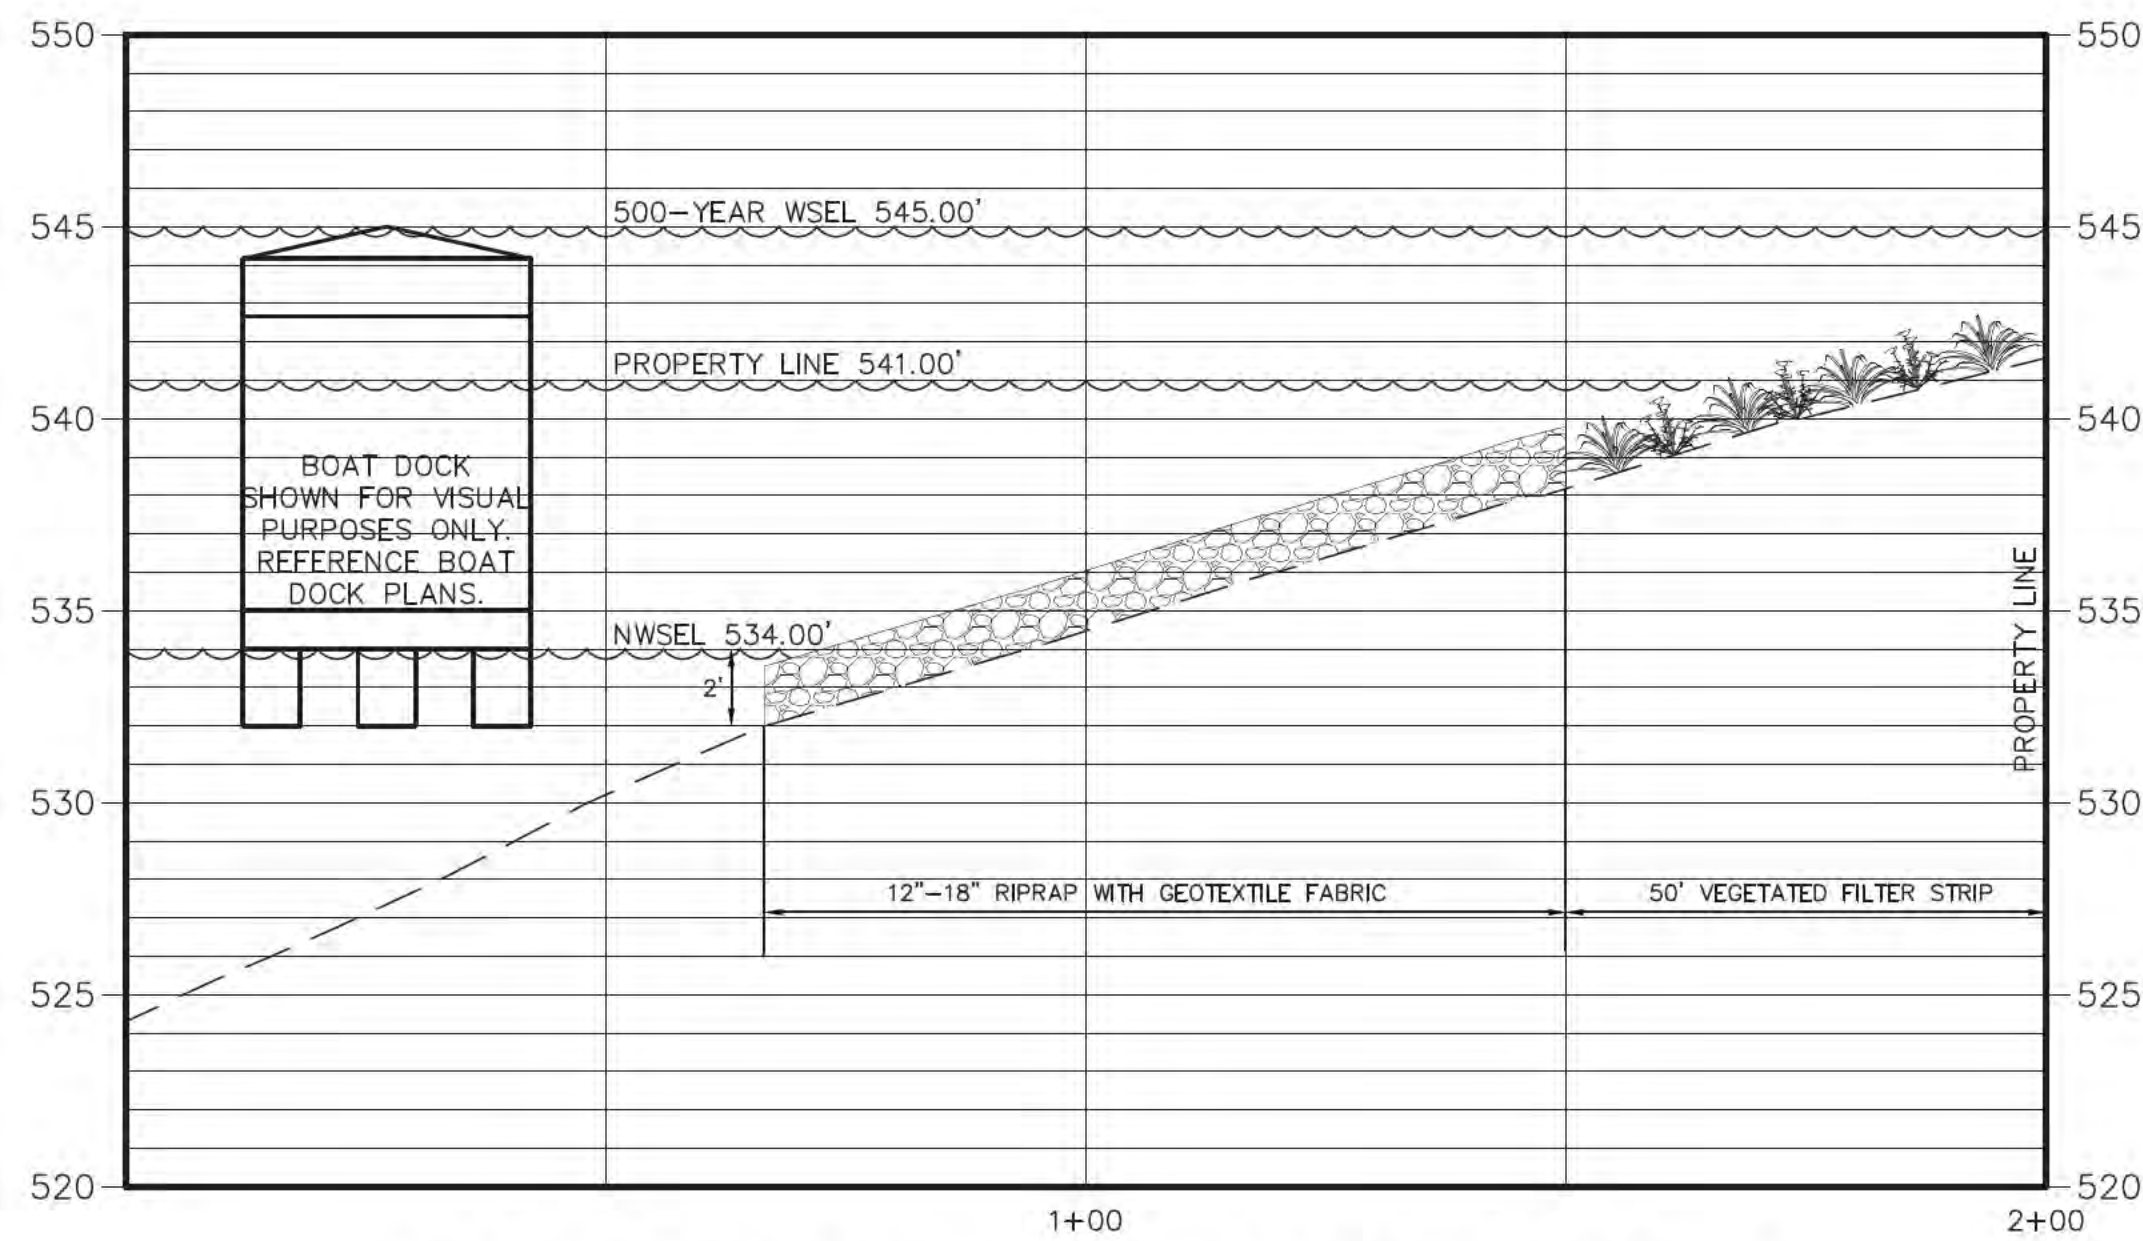

SHORELINE PROTECTION - THE PENINSULA COMMUNITY AREA
H: 1"=20'
V: 1"=5'

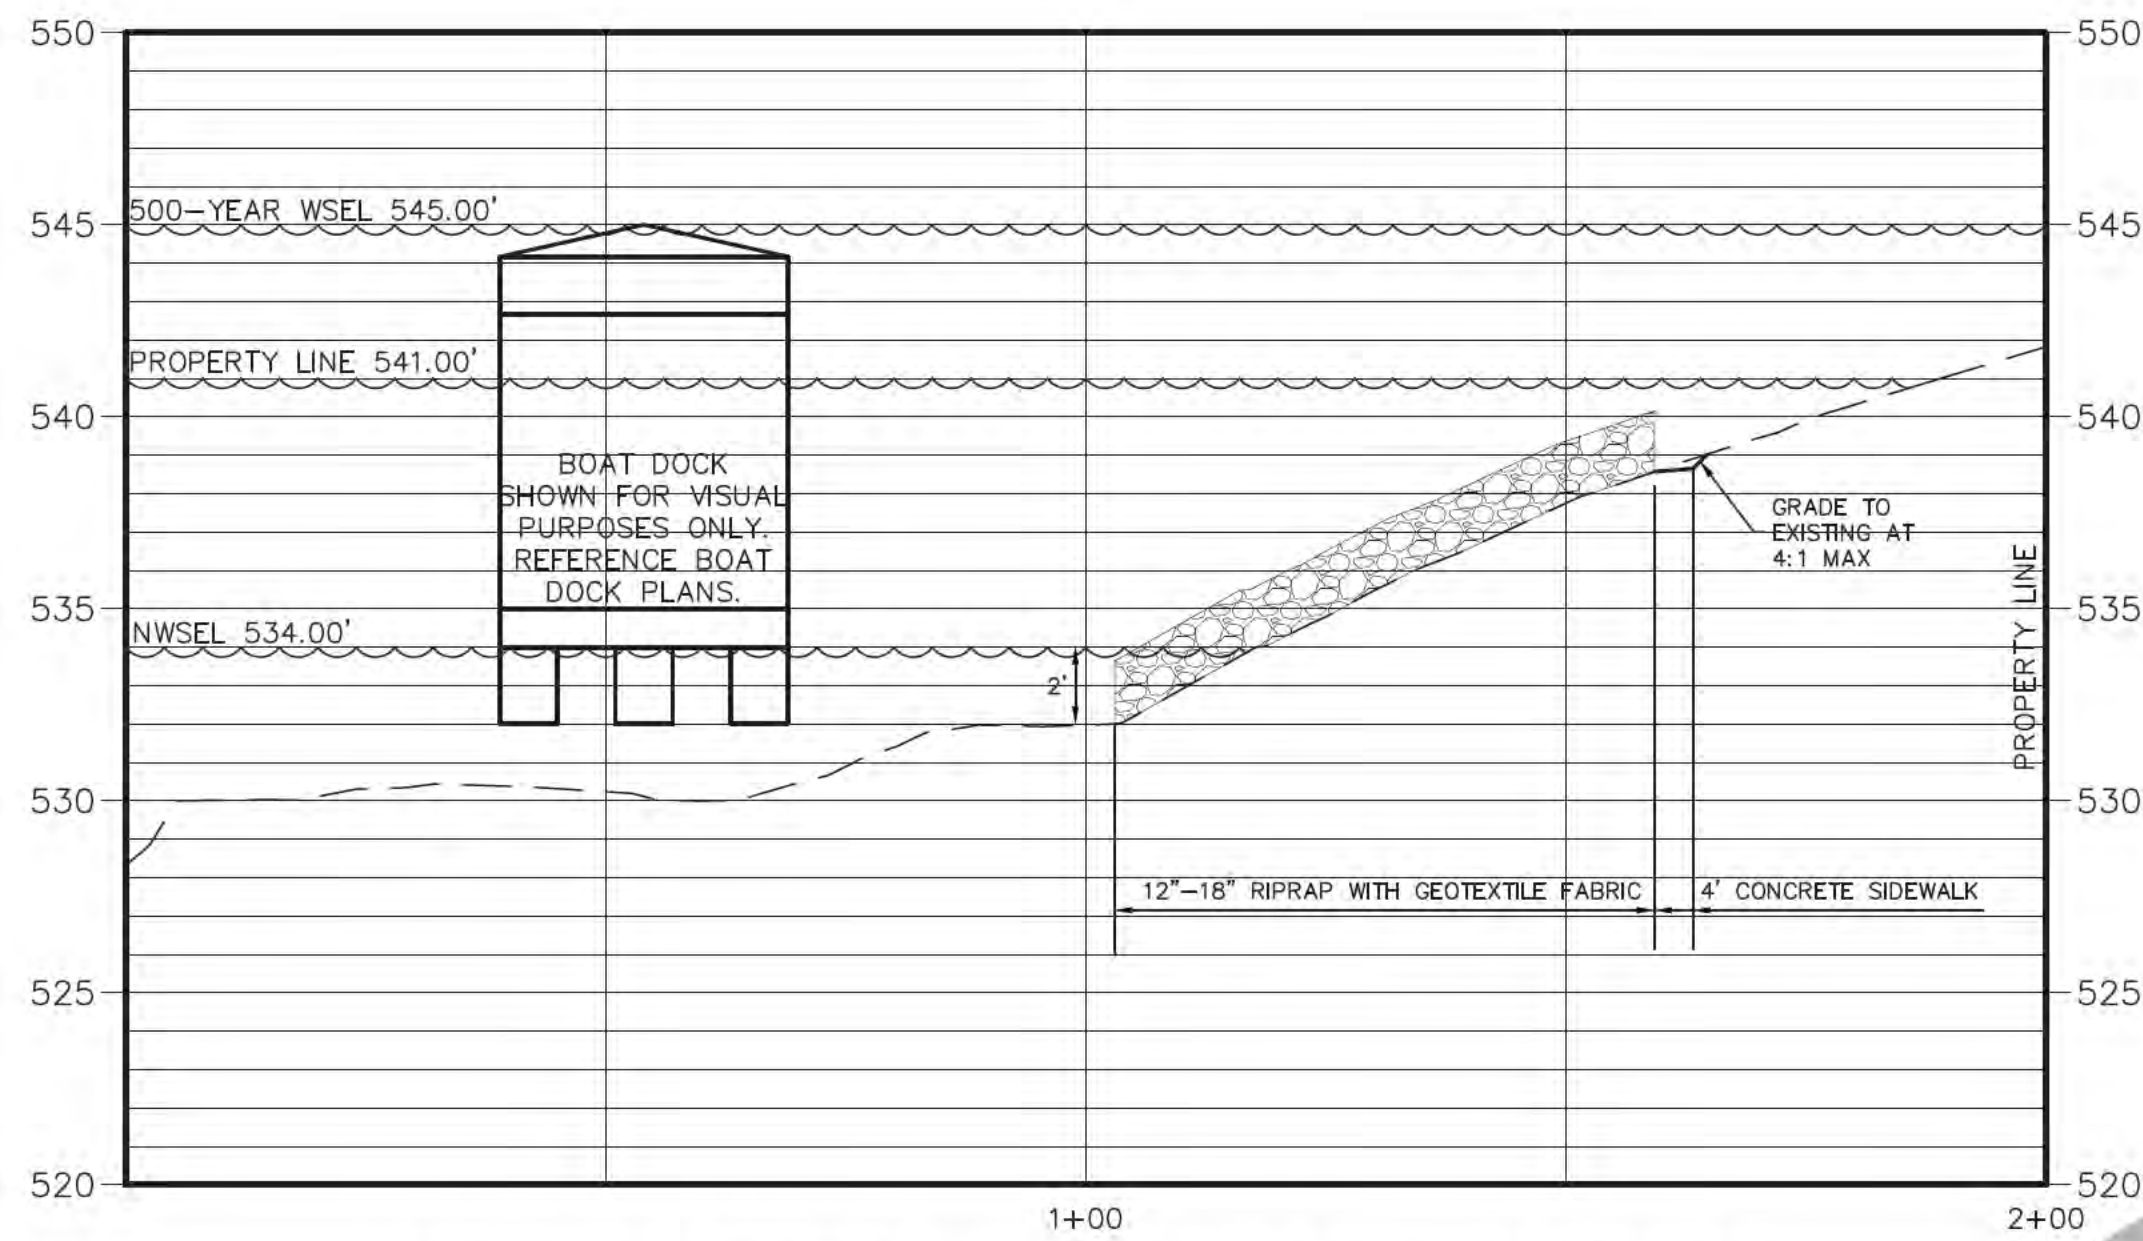

SHORELINE PROTECTION - THE PENINSULA SHARED BOAT DOCK
H: 1"=20'
V: 1"=5'

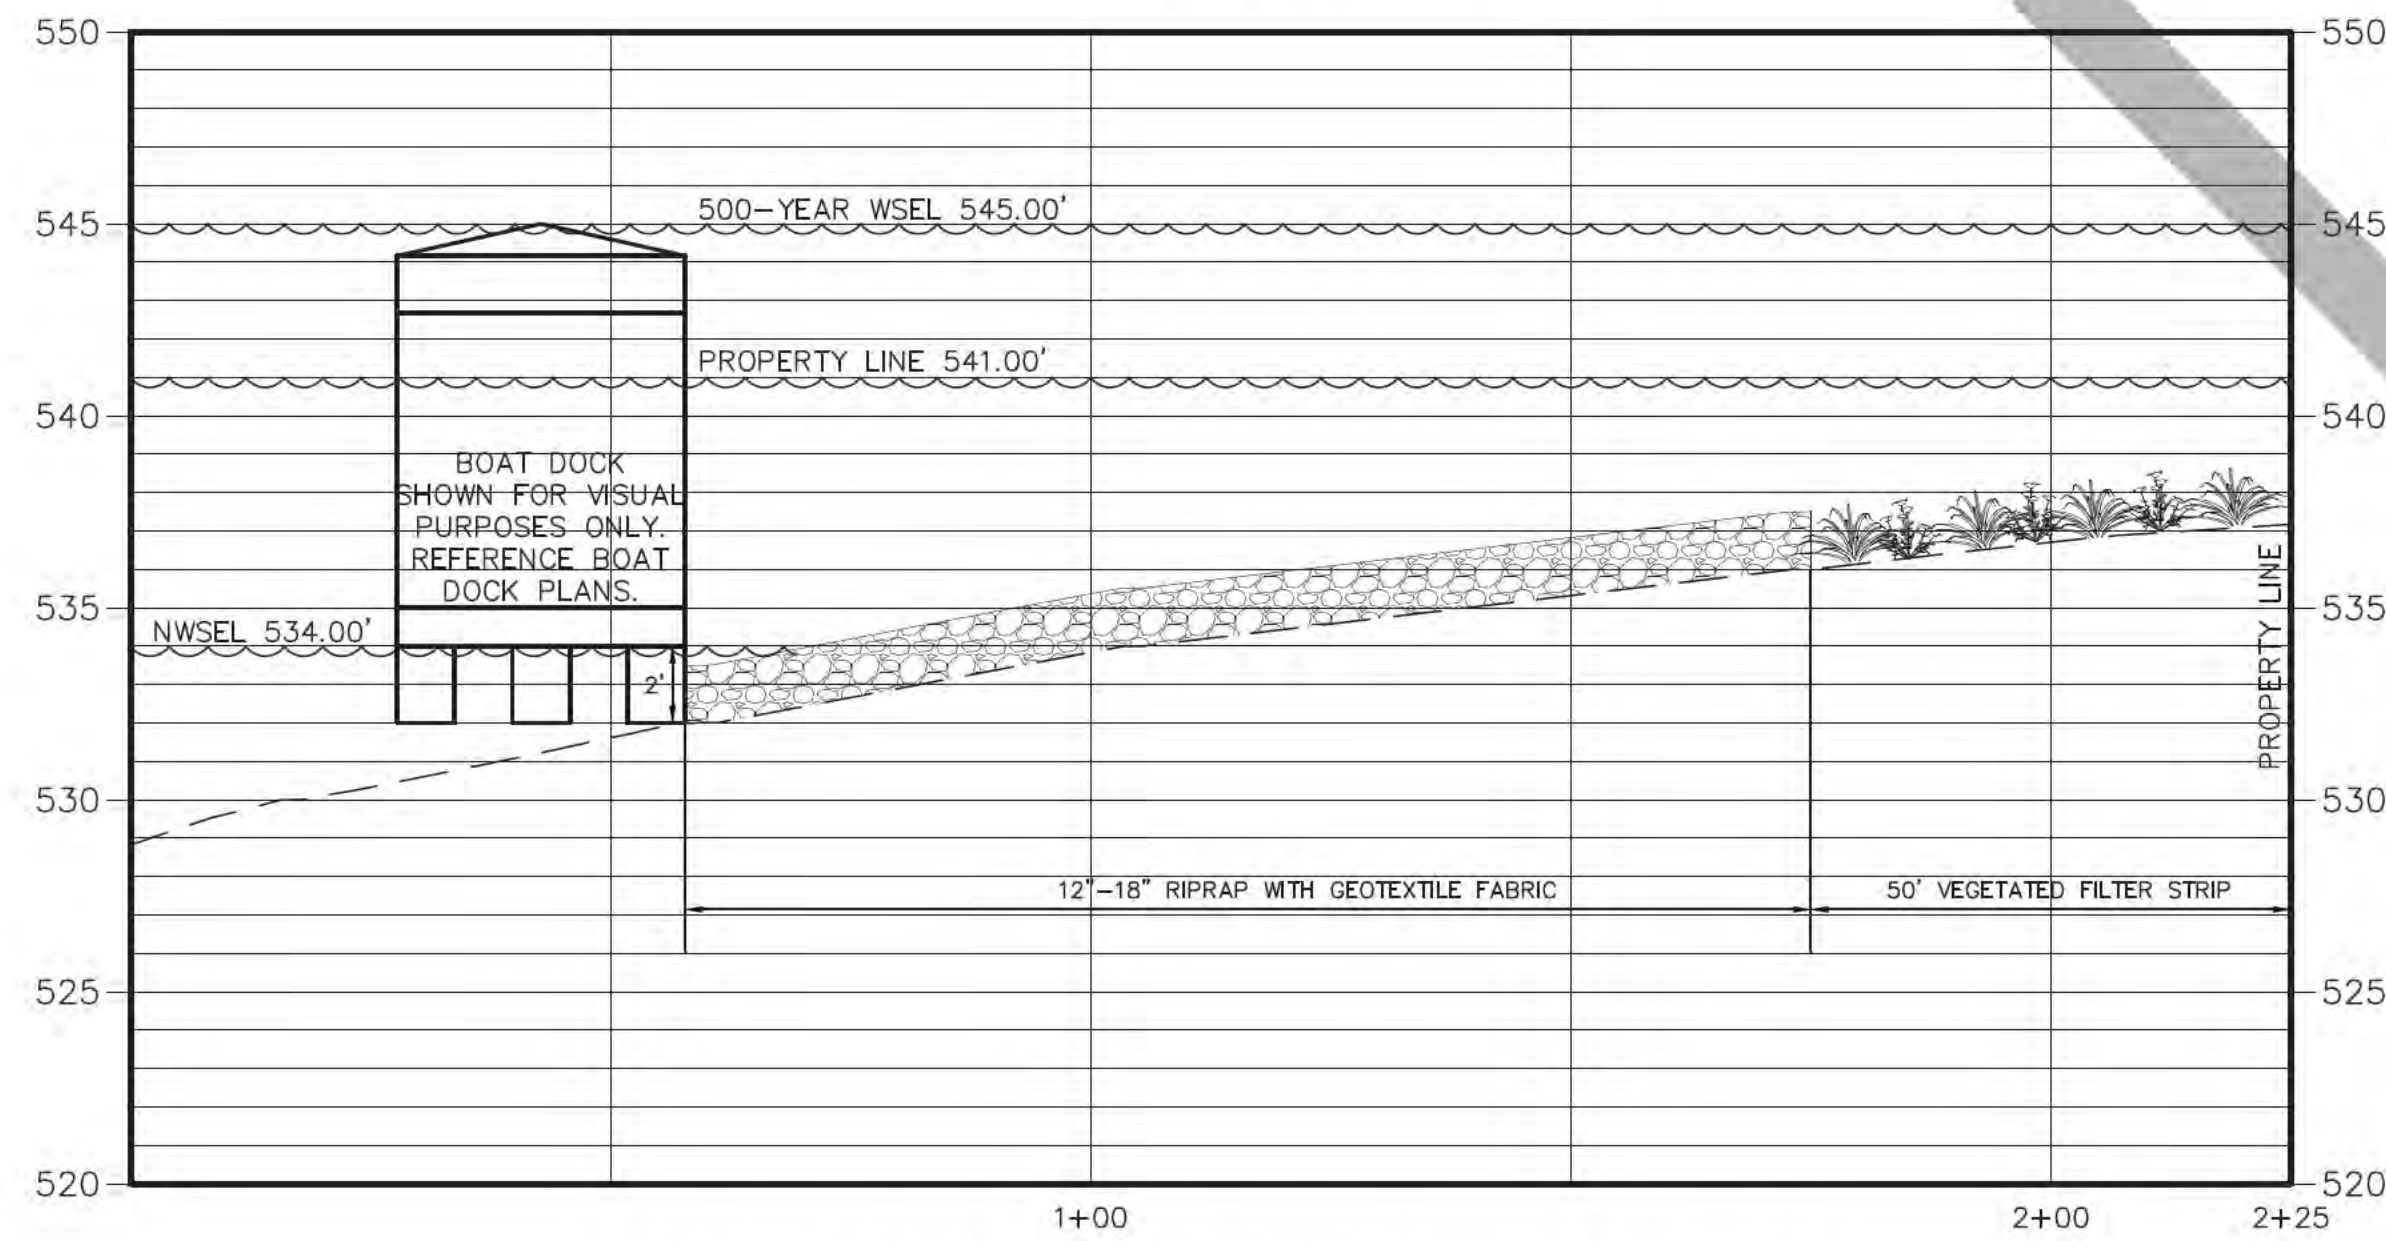

SHORELINE PROTECTION - THE SHORES SHARED BOAT DOCK
H: 1"=20'
V: 1"=5'

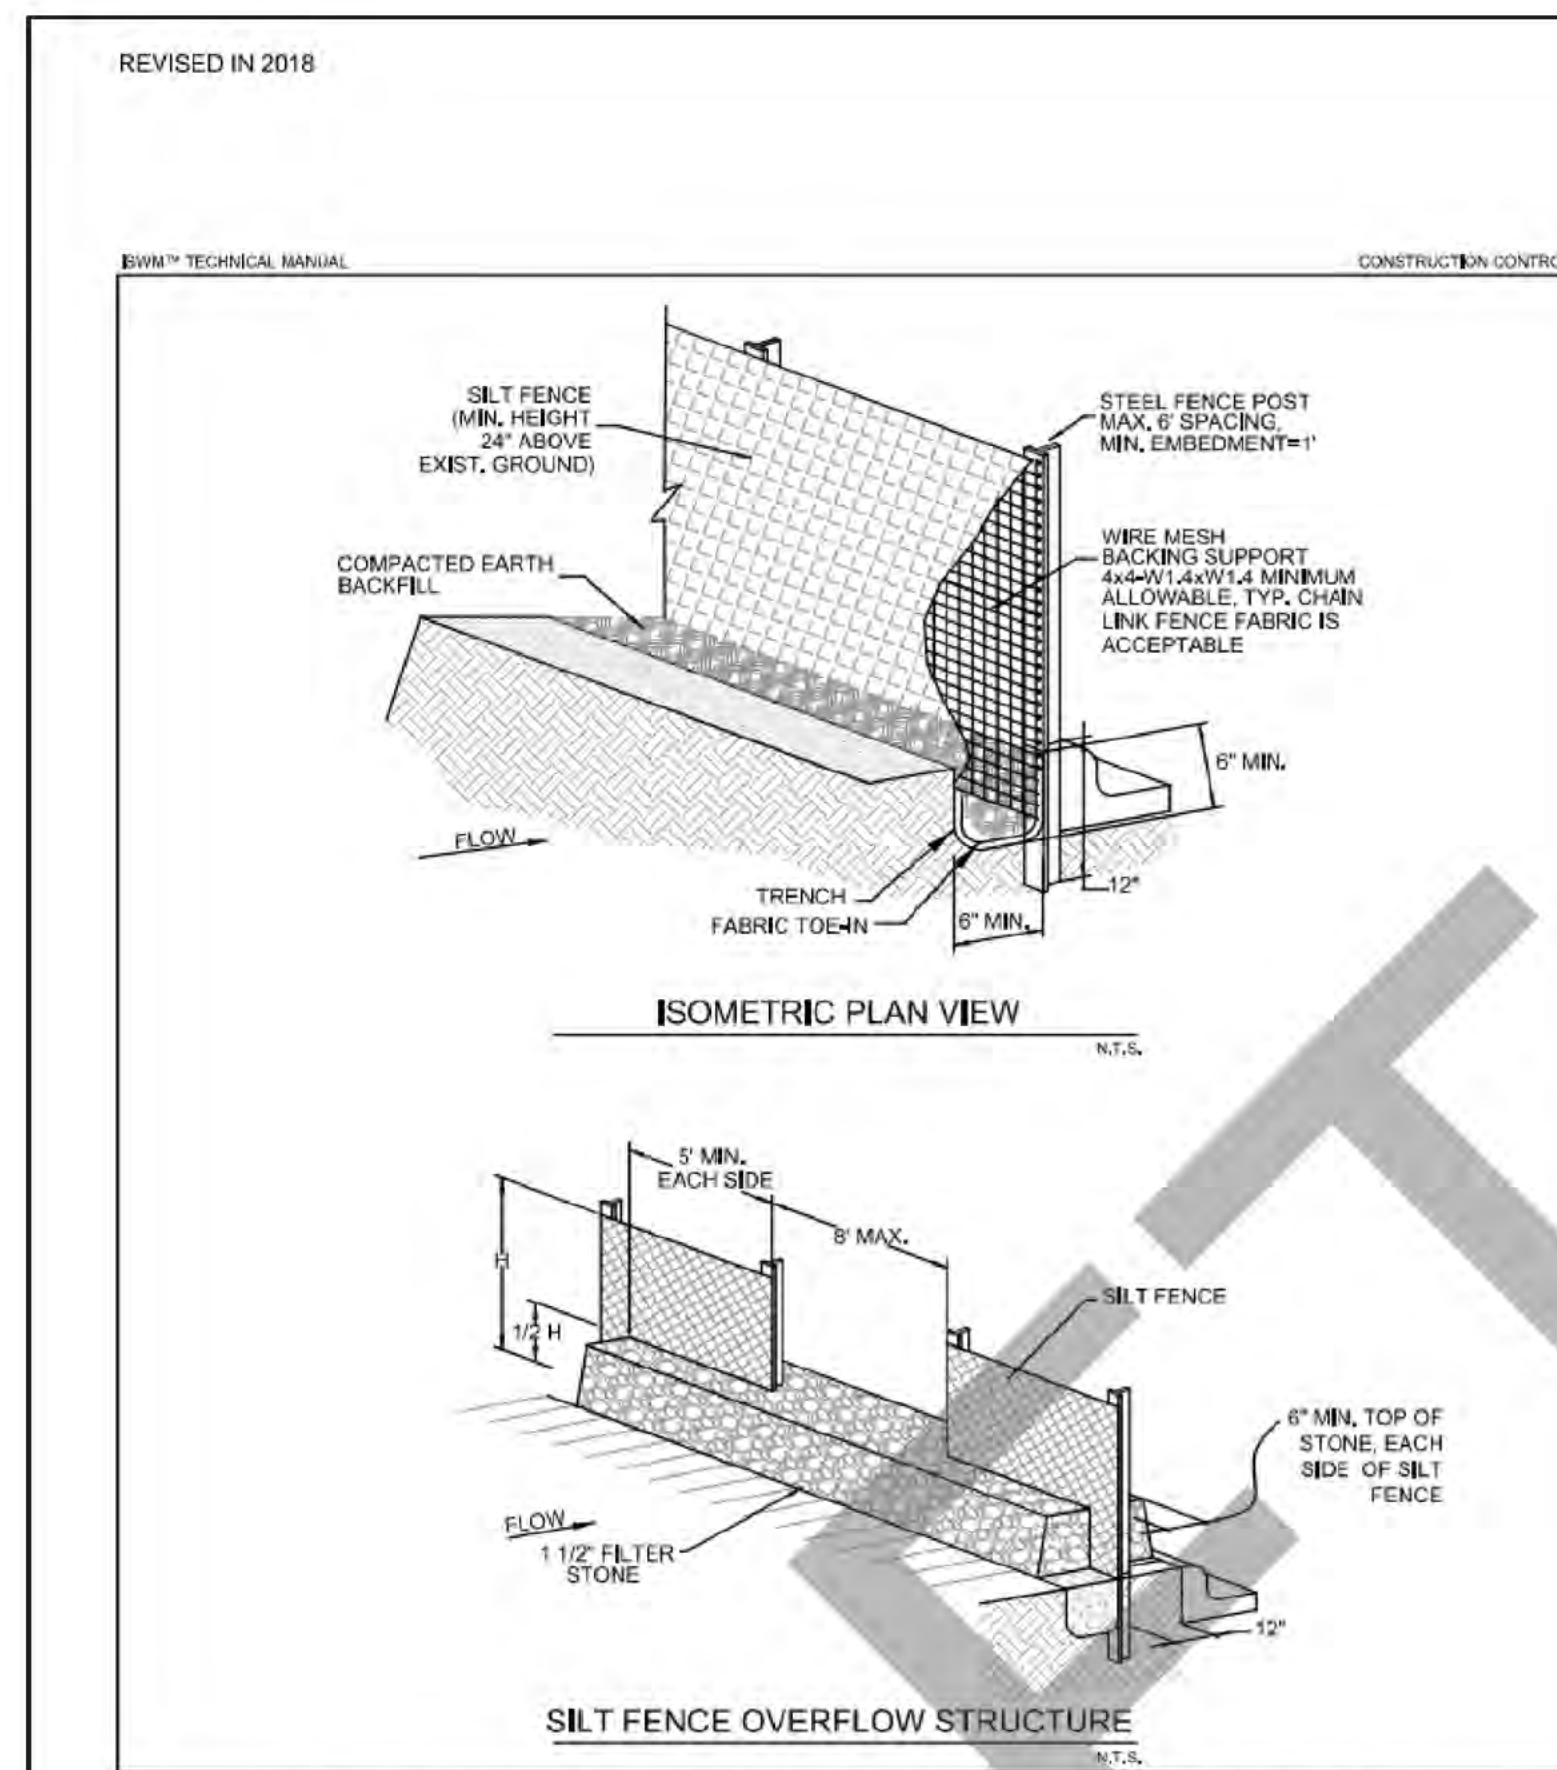


FIGURE 3.28 STANDARD CONSTRUCTION DETAIL - FOR SILT FENCE (1 OF 2)


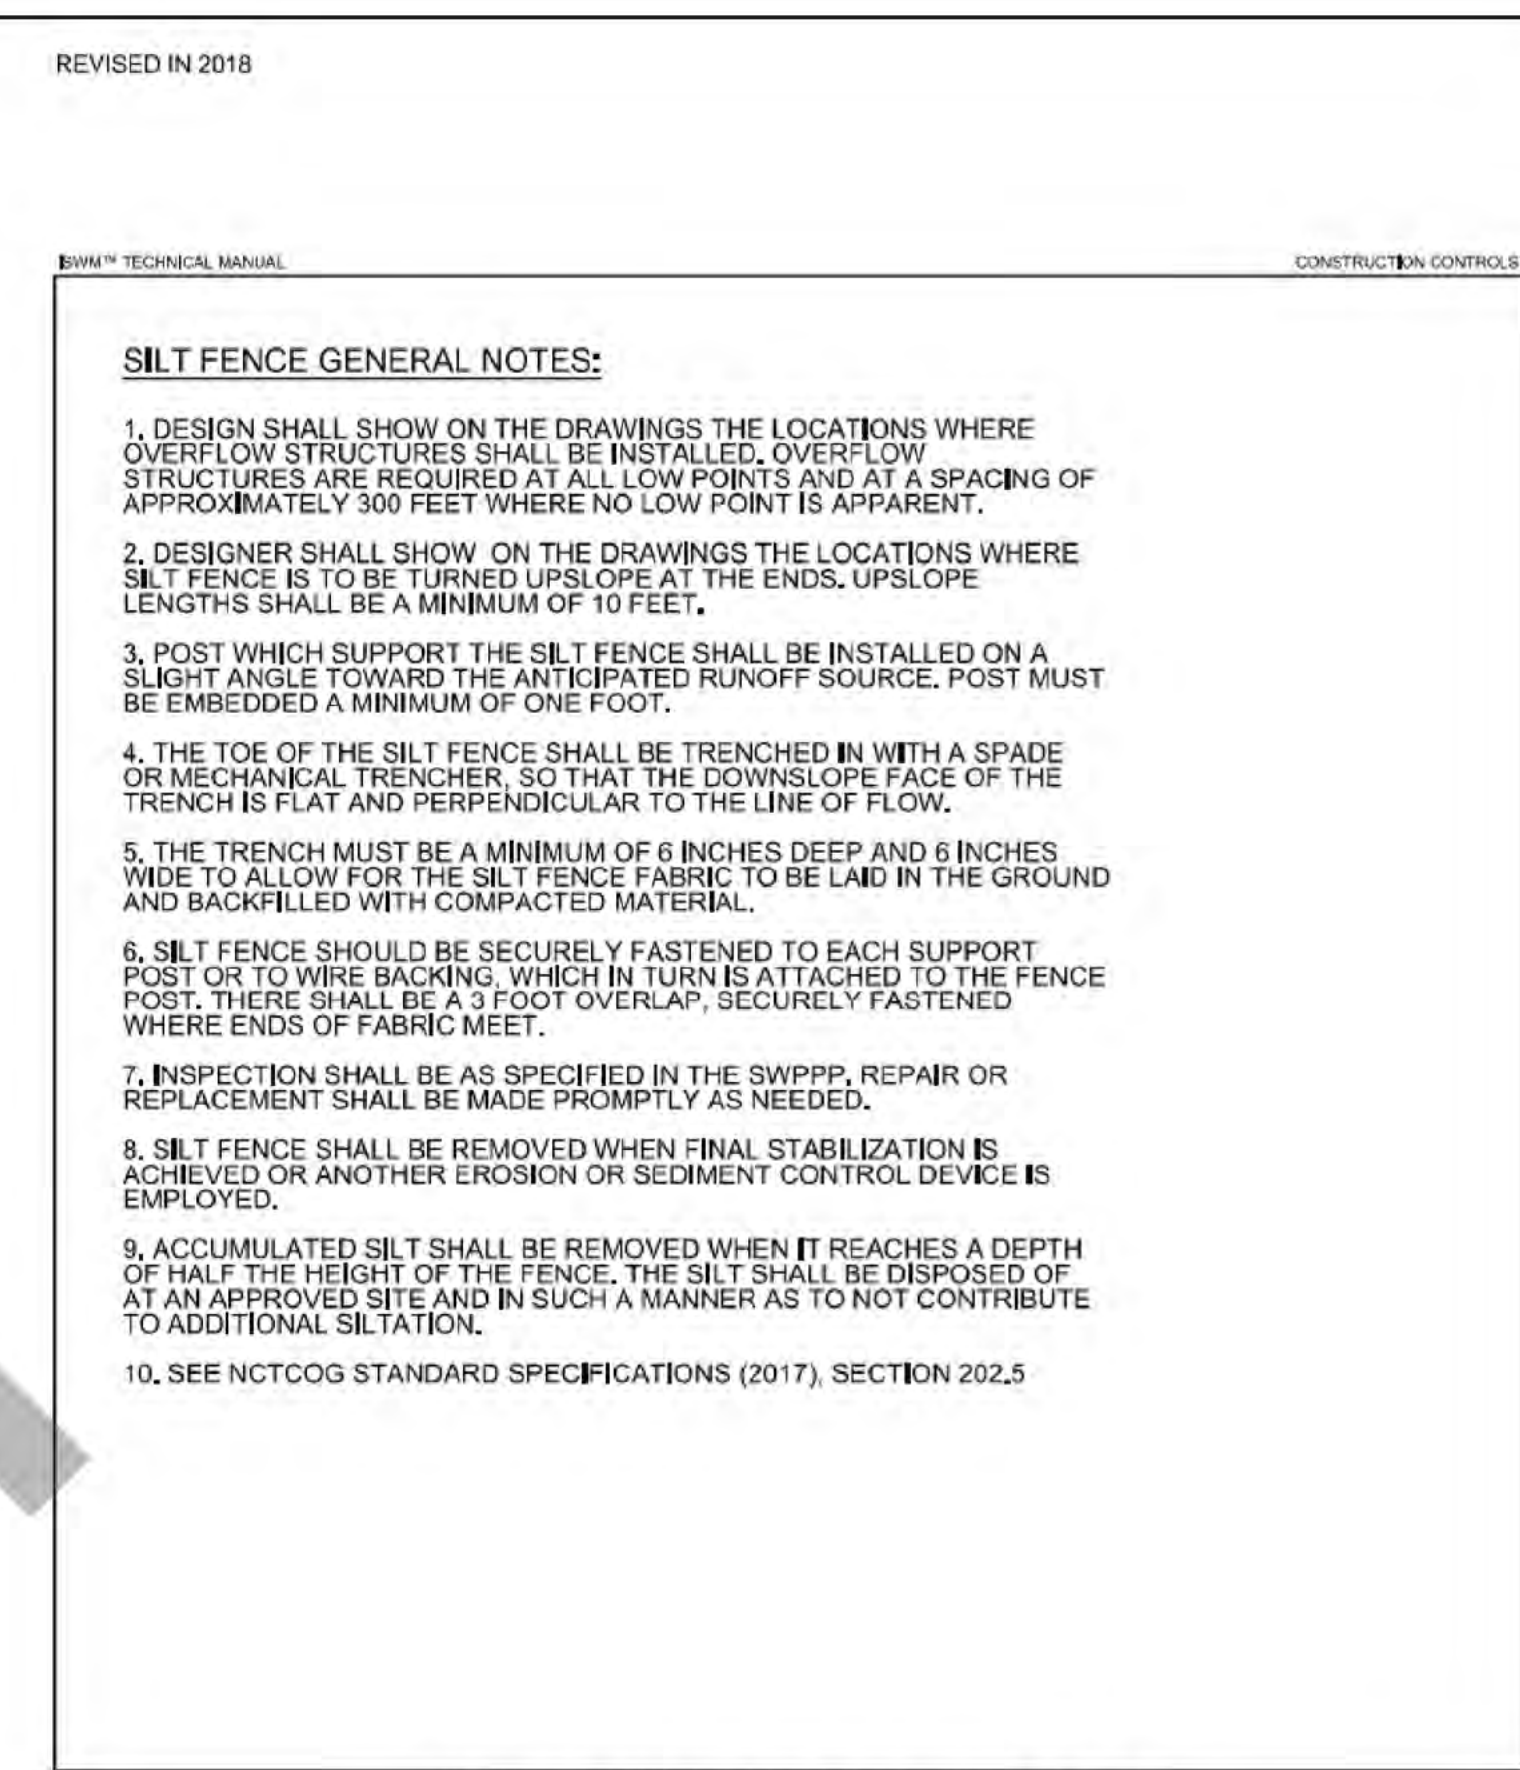



FIGURE 3.28 NOTES FOR SILT FENCE (2 OF 2)

SILT FENCE & OVERFLOW STRUCTURE

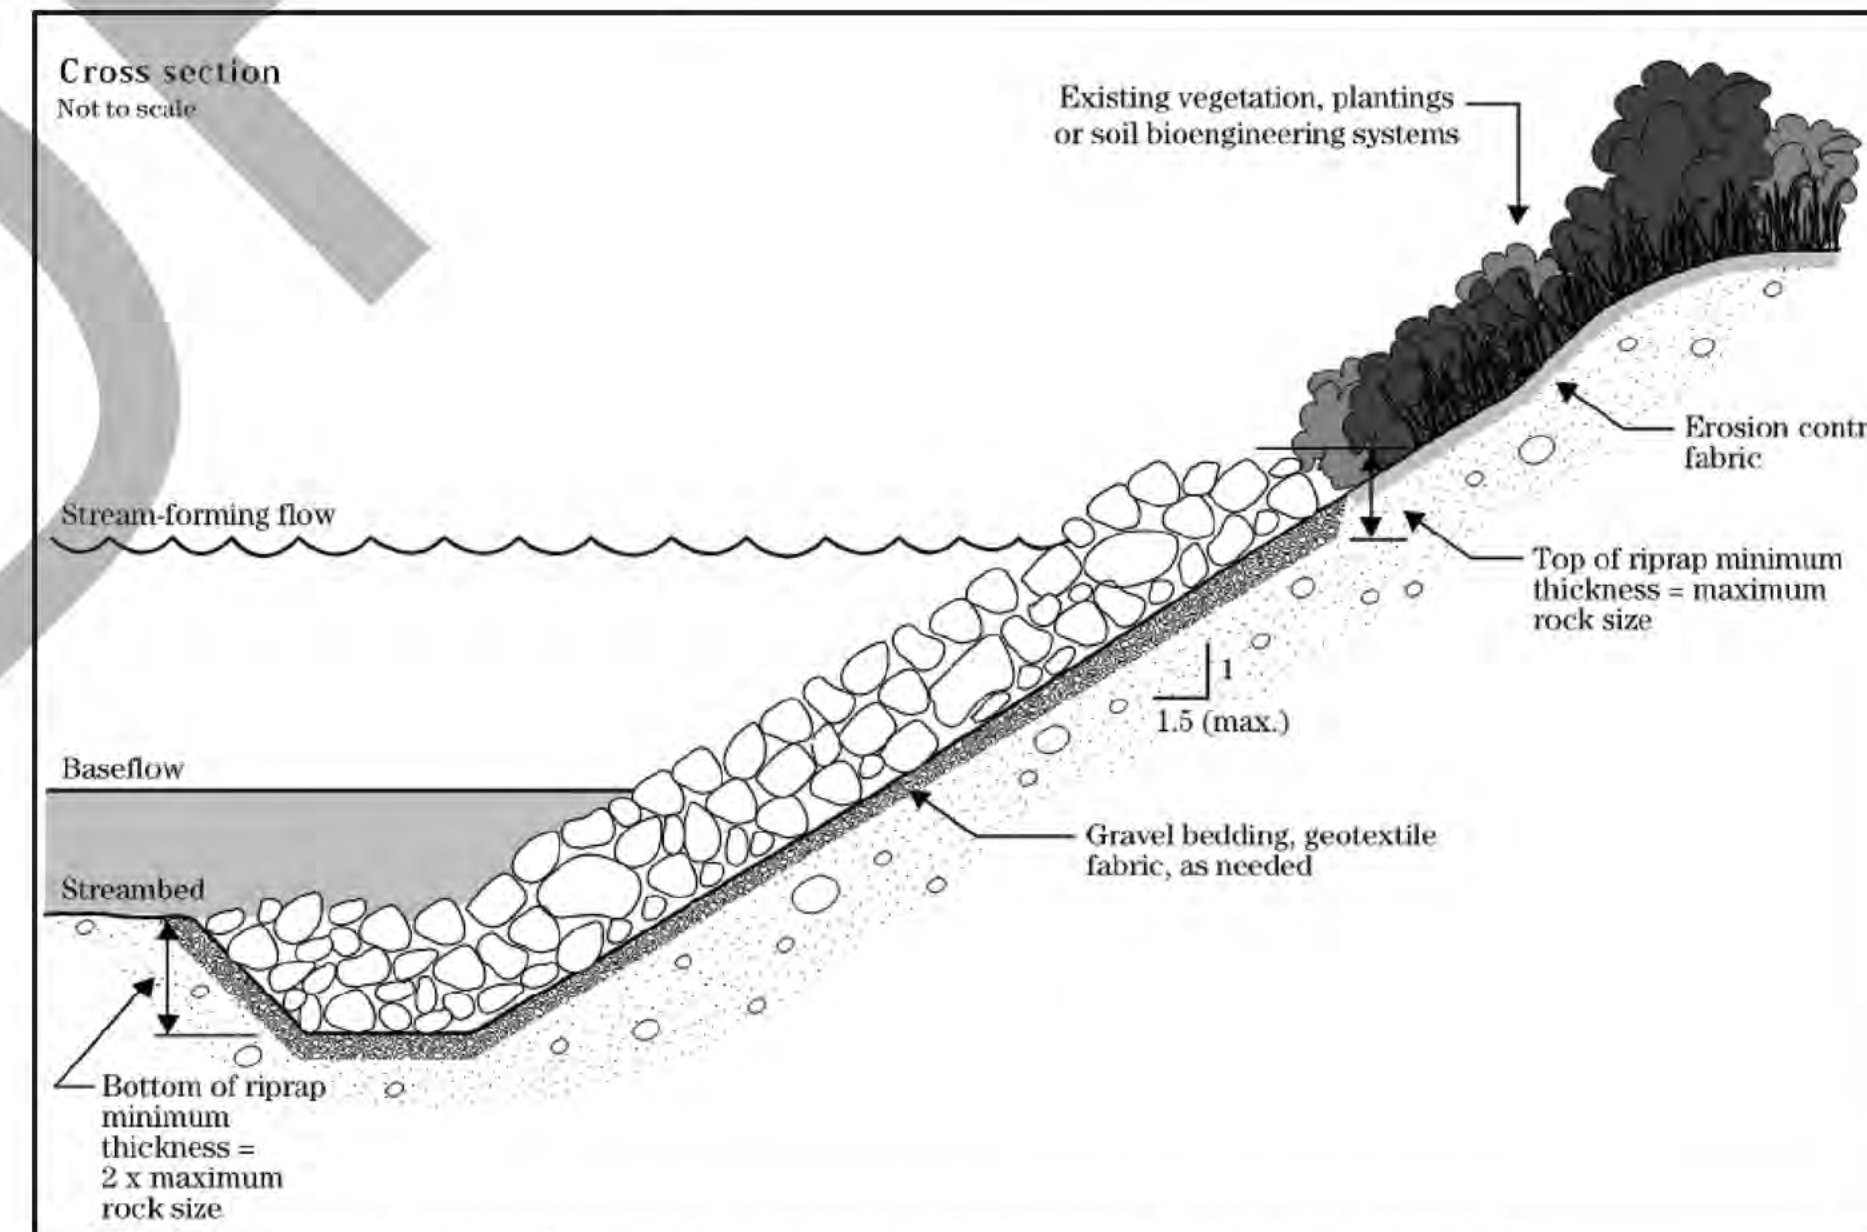

ROCK RIPRAP CROSS SECTION

(USDA CH. 16: STREAMBANK AND SHORELINE PROTECTION)

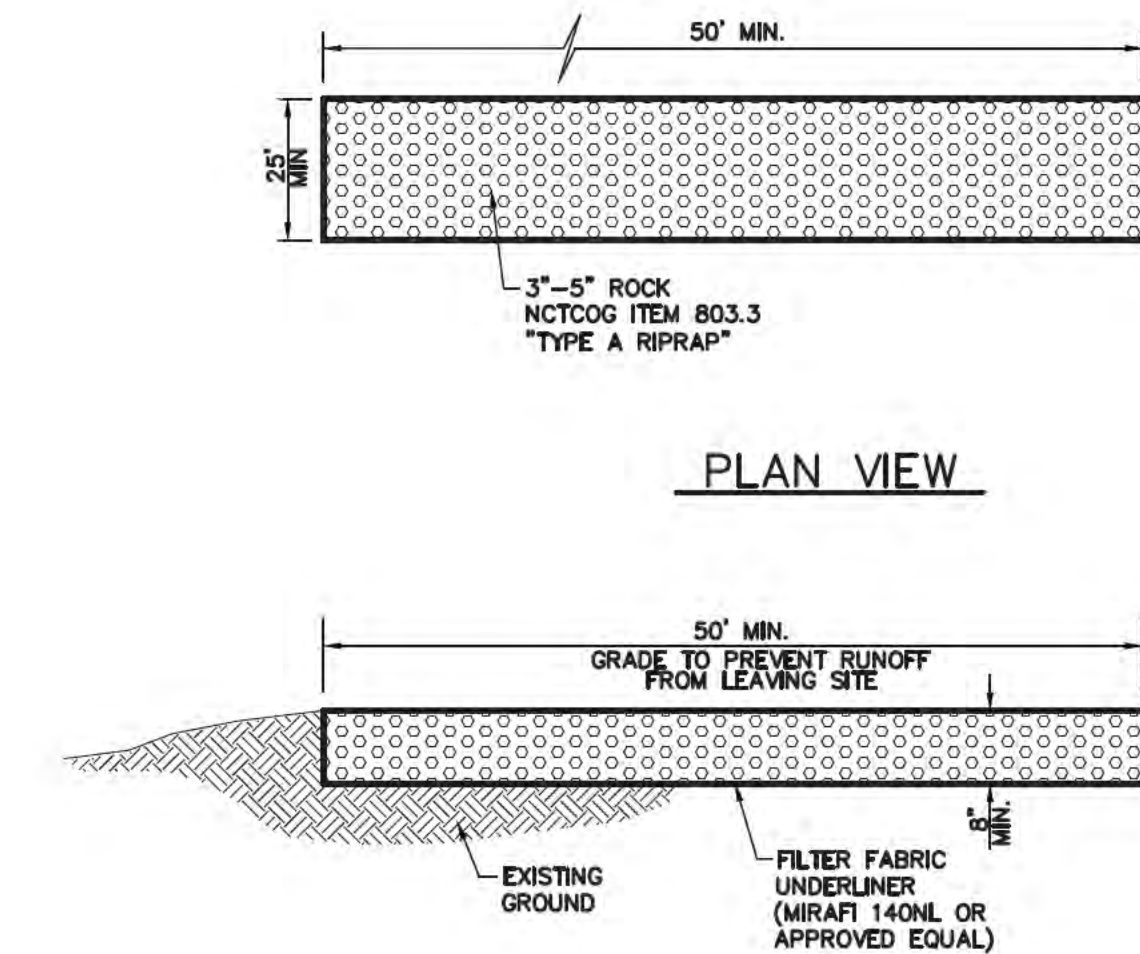

NOTE: GRADE TO DRAIN AWAY FROM STABILIZATION AND STREET PAVED SURFACE. DRAINAGE MUST FLOW AWAY FROM ENTRANCE.

STABILIZED CONSTRUCTION EXIT


NOT TO SCALE

CONSTRUCTION DETAILS

REVISIONS	COMMENTS



Drawing File: C2 DETAILS 23158-03.dwg
Date/Time: Sep 13, 2024 - 4:15pm

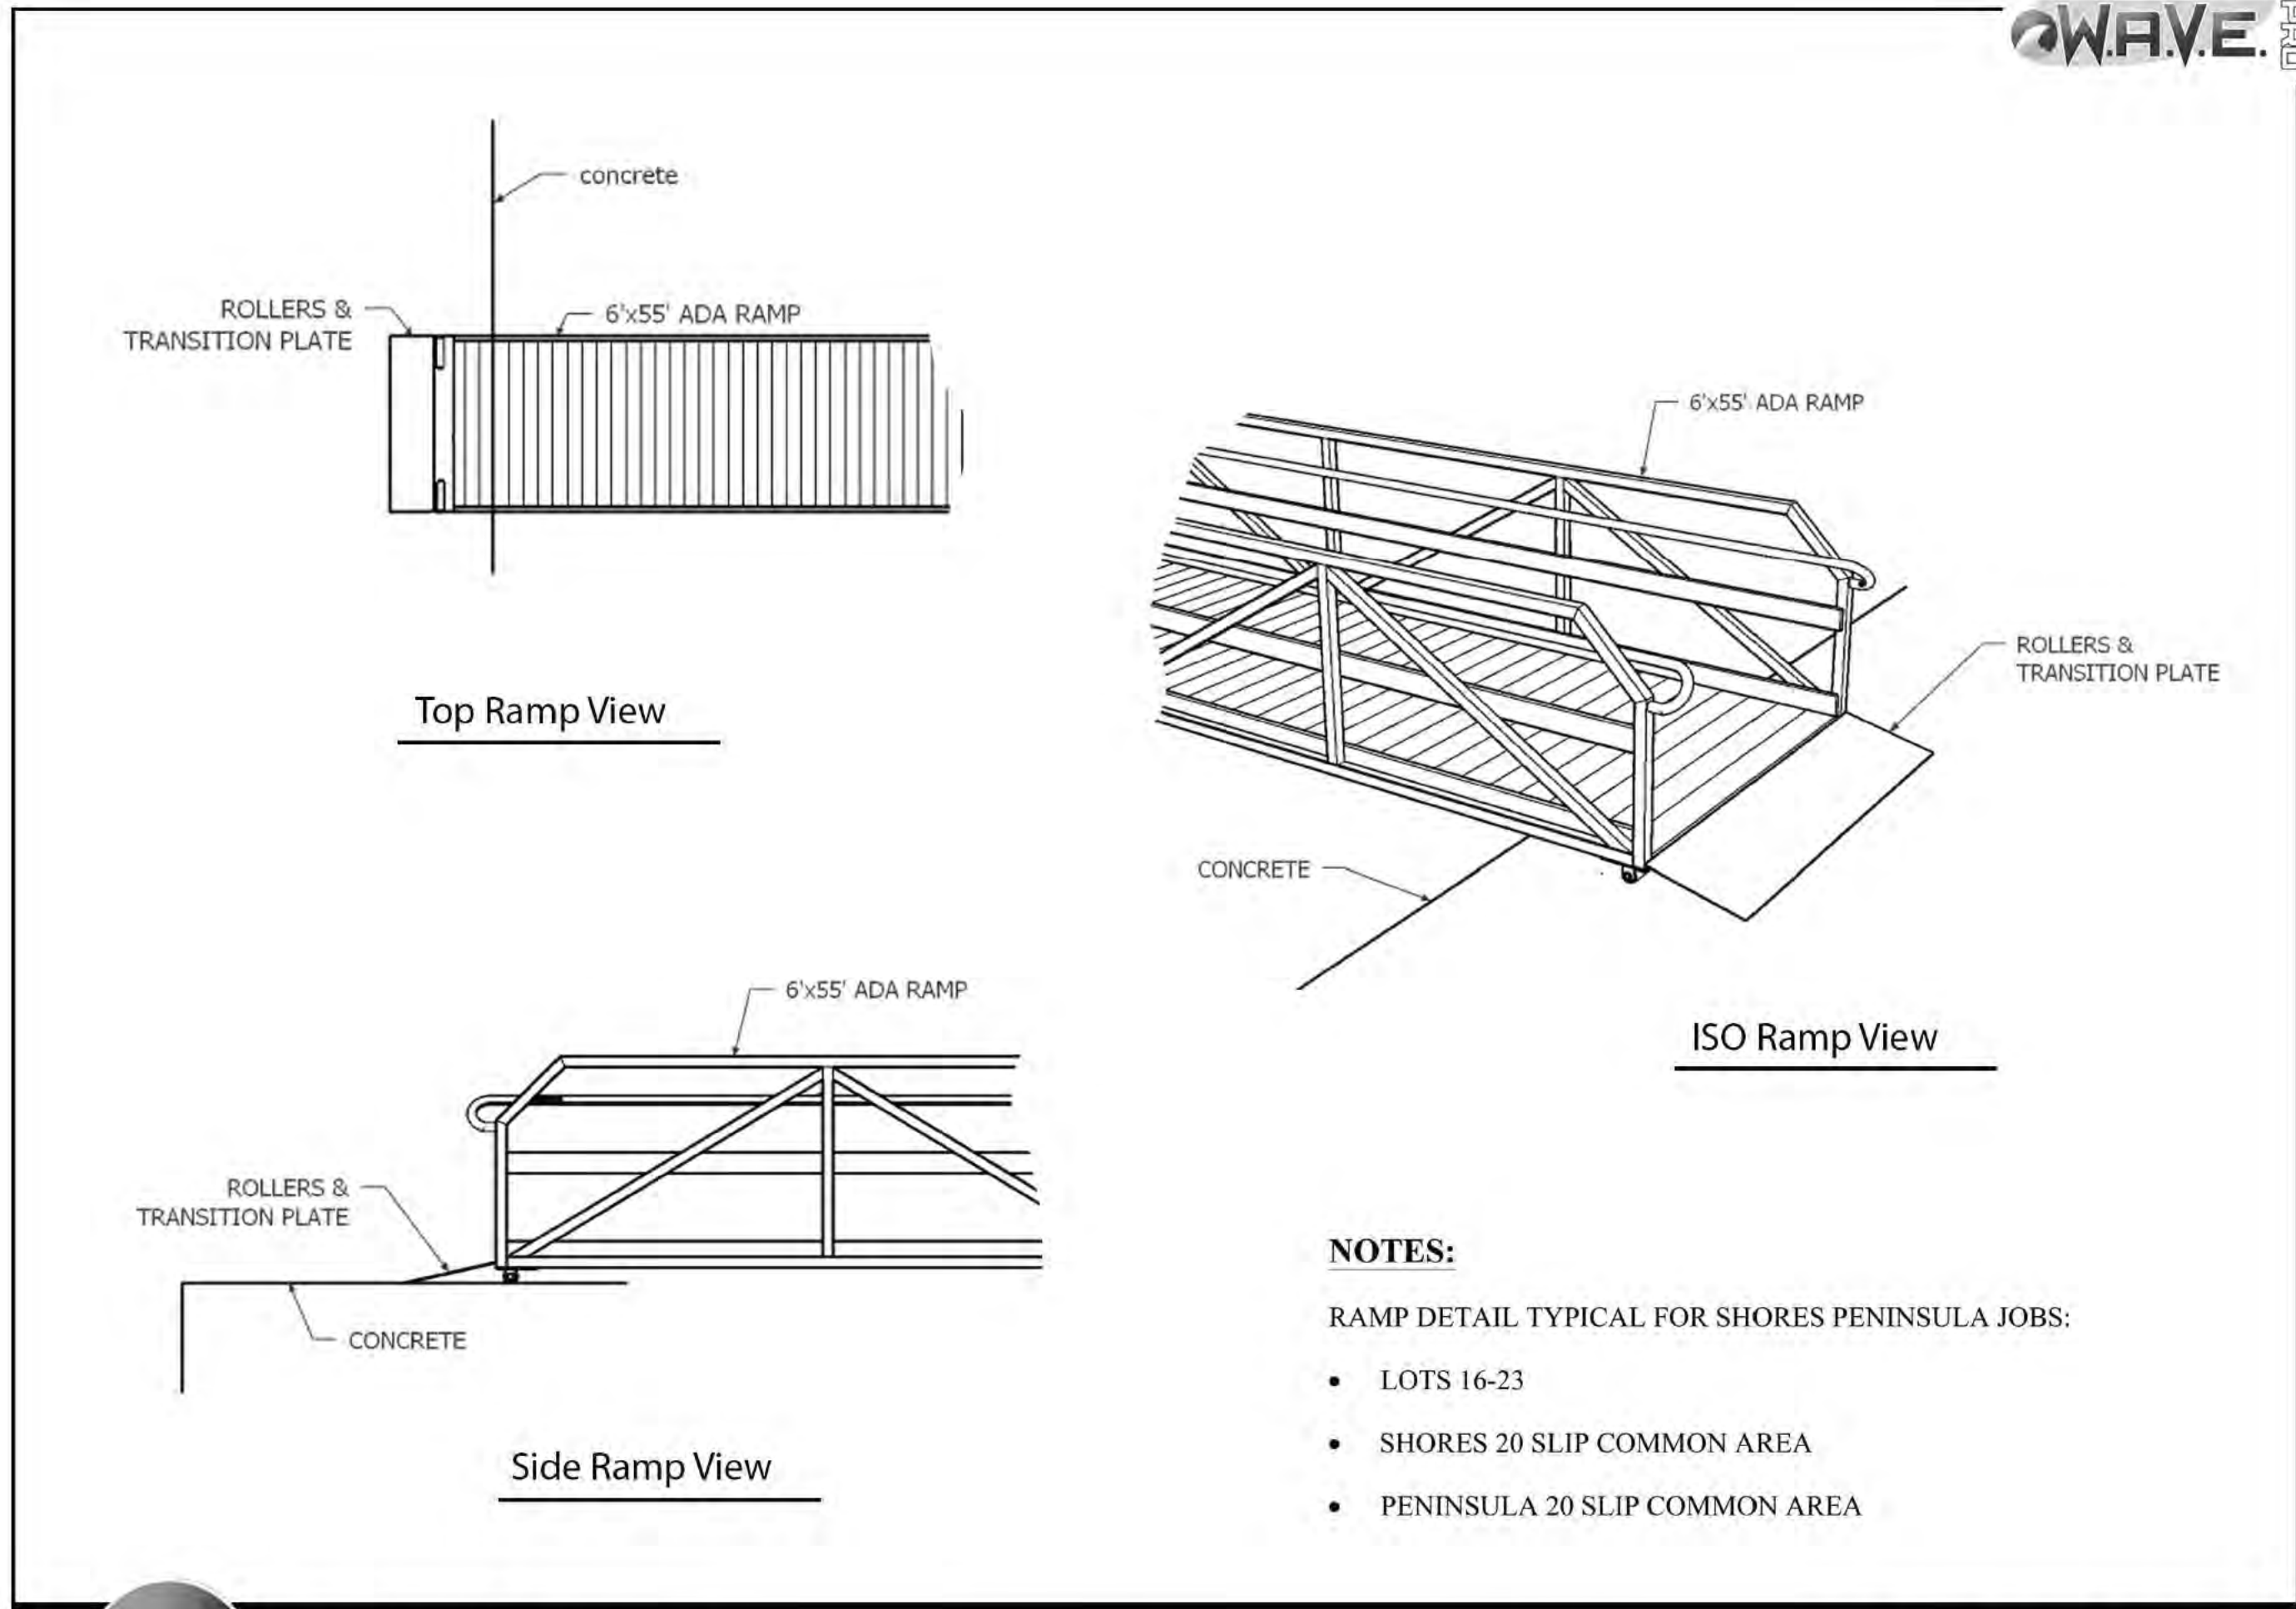

FLOTATION SYSTEMS, Inc.®
2700 ALABAMA HIGHWAY 69 SOUTH
CULLMAN, AL | 800-711-1785 | aluminumboatdocks.com

CUSTOMER:
Shores Peninsula

DEALER:
Jeff Stamey

Drawing Date: 5-15-24
Revision #:
Revision Date:
Scale: NTS

NOTES:


RAMP DETAIL TYPICAL FOR SHORES PENINSULA JOBS:

- LOTS 16-23
- SHORES 20 SLIP COMMON AREA
- PENINSULA 20 SLIP COMMON AREA

DOCK RAMP

CONSTRUCTION DETAILS

REVISIONS		COMMENTS	
#	DATE		

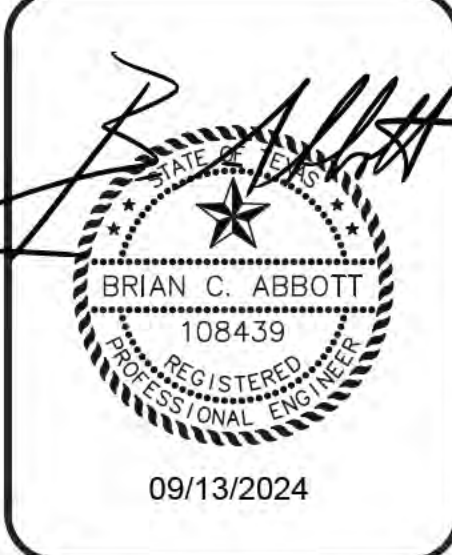

SHEET NO.
C403

**THE PENINSULA &
THE SHORES AT
BOIS D'ARC LAKE**
FANNIN COUNTY, TEXAS



**ABBOTT
CONSULTING &
ENGINEERING, LLC**
P.O. Box 997
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Brian@abbott-ce.com
Phone: (214) 616-0787
Texas Firm # F-21189

THE PENINSULA & THE SHORES - Fannin County, Texas - ACE Project No. 23158-03



Architectural Planning Criteria Dock Specifications

Complete, correct and in compliance with the SMP.

Structural Components:

Commercial and residential -

All structural aluminum components shall be of 6000 series high strength marine grade aluminum.

Minimum thickness on all outer main frame E-channel shall be 3/16" and secondary components a minimum of 1/8".

Main frame E-channel minimum depth 10" with outer wall ribbed to provide aesthetics and increase web stiffness.

All tubing shall have radius corner and a minimum wall thickness of 1/8"; maximum 1/4"

Decking Surface:

Extruded Lockdome™ aluminum decking panels to be 1" x 6" with raised ridges for added slip resistance.

Joist spacing to be set on a maximum of 36" centers maintaining minimal surface deflection.

Decking finish-Textured powder coat finish meets or exceeds AAMA 2604 for Salt Spray Resistance and Outdoor Exposure testing in South Florida.

Available colors: Buckskin, Hearthstone, and Granite Gray.

Hardware:

All self drilling screws, bolts, nuts, and washers are stainless steel.

300 series - bolts

400 series - self drilling screws (zinc plating on self drilling flooring screws)

Main frame bolts shall be a minimum 3/8" diameter with self locking nuts.

Flotation:

Corp Approved EPS Billets – Totally enclosed with high-density polyethylene. Polyethylene shall contain UV Ray inhibitors and Carbon Black pigment to protect against ultraviolet deterioration. Nominal wall thickness .150. Impervious to petroleum products. Heavy duty mounting flanges and slots. 12-year warranty.

Foam: Virgin polystyrene beads closed cell with water absorption less than 3lbs./c.f. at seven days, when tested in accordance with ASTM C272.

Dock access:

Ramp/gangways to be all aluminum construction using an arched bridge truss design. High strength to weight ratio. Reinforcement gussets at all corners and connection points. Main structural component to be 2" tubing with radius corners.

Handrails/Guard Rail

37" to 42" above walking surface. No sharp corners, burrs, etc.

Ramp/gangways will meet ADA requirements where required with a minimum clear width of 5' and will include guardrail, handrail and pick plate.

Infill pickets are available to improve safety if desired. Spacing is 4" OC.

Rail shall be designed to accommodate 50# concentrated load in any direction. Alternately guards shall be designed to resist a load of 50# per linear foot applied in any direction.

Dock railing:

Staircase and upper deck rail meet standard code with 4" centers for safety. Powder coat finish. Available in 36" to 42" height.

Roof Panels - Commercial and Residential

26 Gauge R-Loc panels with a Valspar Weather X coating. 30-year limited panel warranty. Optional 35-year warranty upon request.

Trimmed out & finished upper and lower perimeter edges.
Color chart available.

Bumpers:

Vinyl Horizontal – All swim platforms or edges without vertical posts shall receive a P-shape, black rub rail fastened with stainless steel hardware.

Vinyl horizontal corner bumpers provided at finished ends of P-shape rub rail.

Frame Bumper – 1' x 1' polyethylene bumper, typically used around main frame perimeter concealing entire 10" band.

Cleats:

All cleats shall be 8" nylon. 10" cleats available if required.

Cleats will be provided on each side of every boat slip.

All parts of cleats should be smooth and incorporate large radii to ensure rope longevity.

System Design:

Main frame substructure consists of 2 1/4" x 10" heavy gauge E-channel integrated throughout.

Floor joist spacing for aluminum decking 24" OC. For decking supplied by others 12" up to 24" OC.

Floor joist material heavy weight 2 1/4" x 10" E-channel, 2 1/4" x 8" C-channel, and 2" x 2" square tube. Full 10" depth at post areas and braces.

Reinforcement bracing at high stress areas, corners, and connection points.

Roof support post constructed of 4" x 4" 1/8" wall thickness radius corners integrated into main frame with 4" x 10" aluminum sleeve "receivers". 4" x 4" typically used for diagonal bracing where required for added strength and stability.

Residential - Structural roof support posts shall be a maximum of 8' spacing for upper deck roofs and 10' spacing for gable and hip roofs.

All purling material shall be of 6000 series heavy strength aluminum 2" x 2" tubing with all ends capped and shall be secured to C-channel truss system using stainless steel bolts, nuts and washers.

Roof support posts shall be incorporated into 8" C-channel roof truss and 10" E-channel main frame using corner sleeve extrusions with a 1/8" wall thickness.

Roof posts are secured in sleeves using double 3/8" stainless steel bolts and nylon lock nuts to give maximum anchorage and a secure connection.


Commercial – Structural roof support posts shall be a maximum of 6' spacing to meet R-Lox panel requirements.

All purling material shall be of 6000 series heavy strength aluminum 3" x 7" Z-beam and shall be secured to 4" support posts using stainless steel bolts, nuts and washers.

Double diagonal gussets included at all post sleeve locations in main frame as well as additional gussets added at all high stress and tension locations such as ramp/gangway and anchoring attachment points.

Size Requirements: Dock footprint shall meet square footage criteria regulated by permitting department.

DRAFT

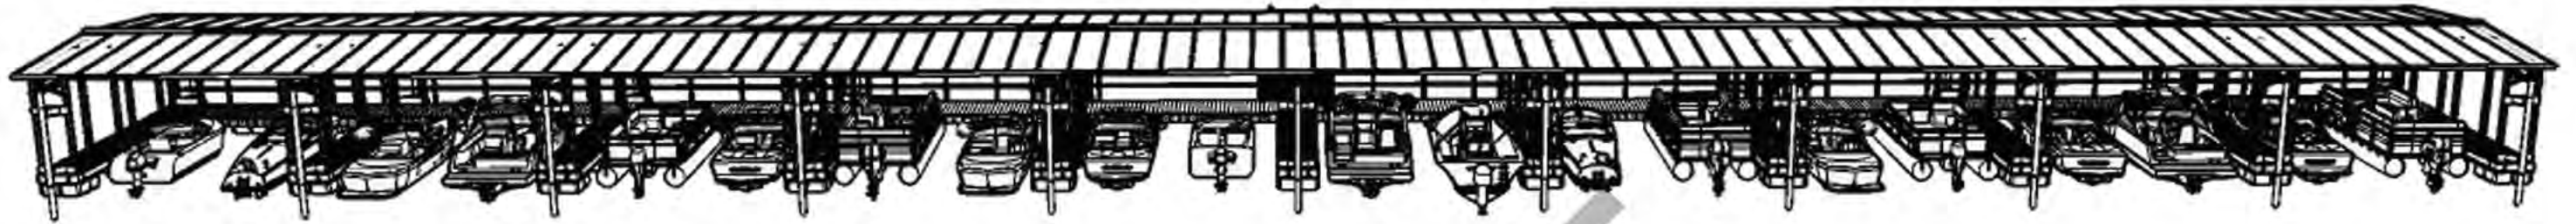

THE SHORES AT THE COMMON AREA

2769 County Road 2730
Honey Grove, TX 75446

DRAWING LIST			
SHEET NUMBER	DESCRIPTION	SHEET NUMBER	DESCRIPTION
1	BANK VIEW A	22	8' COLLAR FRONT
2	BANK VIEW B	23	8' COLLAR TOP
3	ANK VIEW	24	8' COLLAR
4	LEFT VIEW	25	4IN STUB UP
5	ANGLE CUTLIST	26	3' COLLAR VIEWS
6	WATER VIEW A	27	3' COLLAR
7	WATER VIEW B	28	21' POLE
	WATER VIEW C	29	SR1
	AN VIEW	30	SR2
10	ANCHORING VIEW	31	RAMP SIDE VIEW
11	FLOAT DIAGRAM	32	RAMP SIDE DIAGRAM
12	ROOF ASSEMBLY	33	RAMP DECKING DIAGRAM
13	FRAME DIAGRAM	34	RAMP DECKING CUTLIST
14	DECKING DIAGRAM	35	END RAMP DETAIL
15	POST DIAGRAM	36	MIDDLE RAMP DETAIL
16	BW627L	37	EQ END RAMP DETAIL
17	BW625	38	EQ END RAMP ATTACHMENT
18	BW625A	39	EQUALIZER
19	ATTACHMENT SHEET	40	UNDERCARRIAGE
20	F424	41	ACCESSORIES
21	8' COLLAR SIDE	42	LOAD SHEET



BANK VIEW SECTION "A"

BANK VIEW
SECTION "B"

BANK VIEW SECTION "C"

K-SP1
24

SP-1
29

-SHEET DETAIL-

FILE NAME/CUSTOMER

SHORES AT THE COMMON AREA.dwg

DRAWN: 6/1/2023

CHECKED:

MANAG.APPR:

ISSUED TO: MANUFACTURE

DESIGN DRAFTER: R.BAKER

FABRICATOR:

BANK VIEW
SECTION "A"

SIZE
B 1:88

DWG TYPE/NO.

REV
0

SHEET 1 OF 42



BANK VIEW SECTION "A"

BANK VIEW
SECTION "B"

BANK VIEW SECTION "C"

D

D

C

C

B

B

A

A

SP-2
30

RA-1
19

-SHEET DETAIL-

FILE NAME/CUSTOMER

SHORES AT THE COMMON AREA.dwg

DRAWN: 6/1/2023

CHECKED:

MANAG.APPR:

ISSUED TO: MANUFACTURE

DESIGN DRAFTER: R.BAKER

FABRICATOR:

BANK VIEW
SECTION "B"

SIZE
B

SCALE
1:32

DWG TYPE/NO.

REV
0

SHEET 2 OF 42

BANK VIEW SECTION "A"

BANK VIEW
SECTION "B"

BANK VIEW SECTION "C"

K-SP1
24

-SHEET DETAIL-

FILE NAME/CUSTOMER ➔

SHORES AT THE COMMON AREA.dwg

DRAWN: 6/1/2023

CHECKED:

MANAG.APPR:

ISSUED TO: MANUFACTURE

DESIGN DRAFTER: R.BAKER

FABRICATOR:

BANK VIEW
SECTION "C"

SIZE
B

SCALE
1:80

DWG TYPE/NO.

REV
0

SHEET 3 OF 42



ROOF MATERIAL CUT LIST

	QTY.	2" X 2" ANGLE BRACING
F	10	6'-5 1/12" LG.
G	10	6'-5 1/8" LG.
H	10	6'-5 1/16" LG.
I	10	6'-3 5/16"
J	20	4'-5 1/4"
K	40	5'-2 7/16
L	10	29'-7 1/8
	QTY.	Z-BEAM
N	16	30'
O	64	29'

D:\Virtual\LOGO\UTATION LOGO\VS LOGO.BMP	-SHEET DETAIL-			SHORES AT THE COMMON AREA.dwg			
	FILE NAME/CUSTOMER ➔						
	DRAWN: 6/1/2023			RIGHT SIDE VIEW			
	CHECKED:						
	MANAG.APPR:						
	ISSUED TO: MANUFACTURE						
	DESIGN DRAFTER: R.BAKER						SIZE B
	FABRICATOR:						SHEET 5 OF 42

BANK VIEW SECTION "A"

BANK VIEW
SECTION "B"

BANK VIEW SECTION "C"

K-SP1
24

-SHEET DETAIL-

FILE NAME/CUSTOMER →

SHORES AT THE COMMON AREA.dwg

DRAWN: 6/1/2023

CHECKED:

MANAG.APPR:

ISSUED TO: MANUFACTURE

DESIGN DRAFTER: R.BAKER

FABRICATOR:

WATER VIEW
SECTION "A"

SIZE

B

SCALE

1:50

DWG TYPE/NO.

REV



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SHEET 6 OF 42

BANK VIEW SECTION "A"

BANK VIEW
SECTION "B"

BANK VIEW SECTION "C"

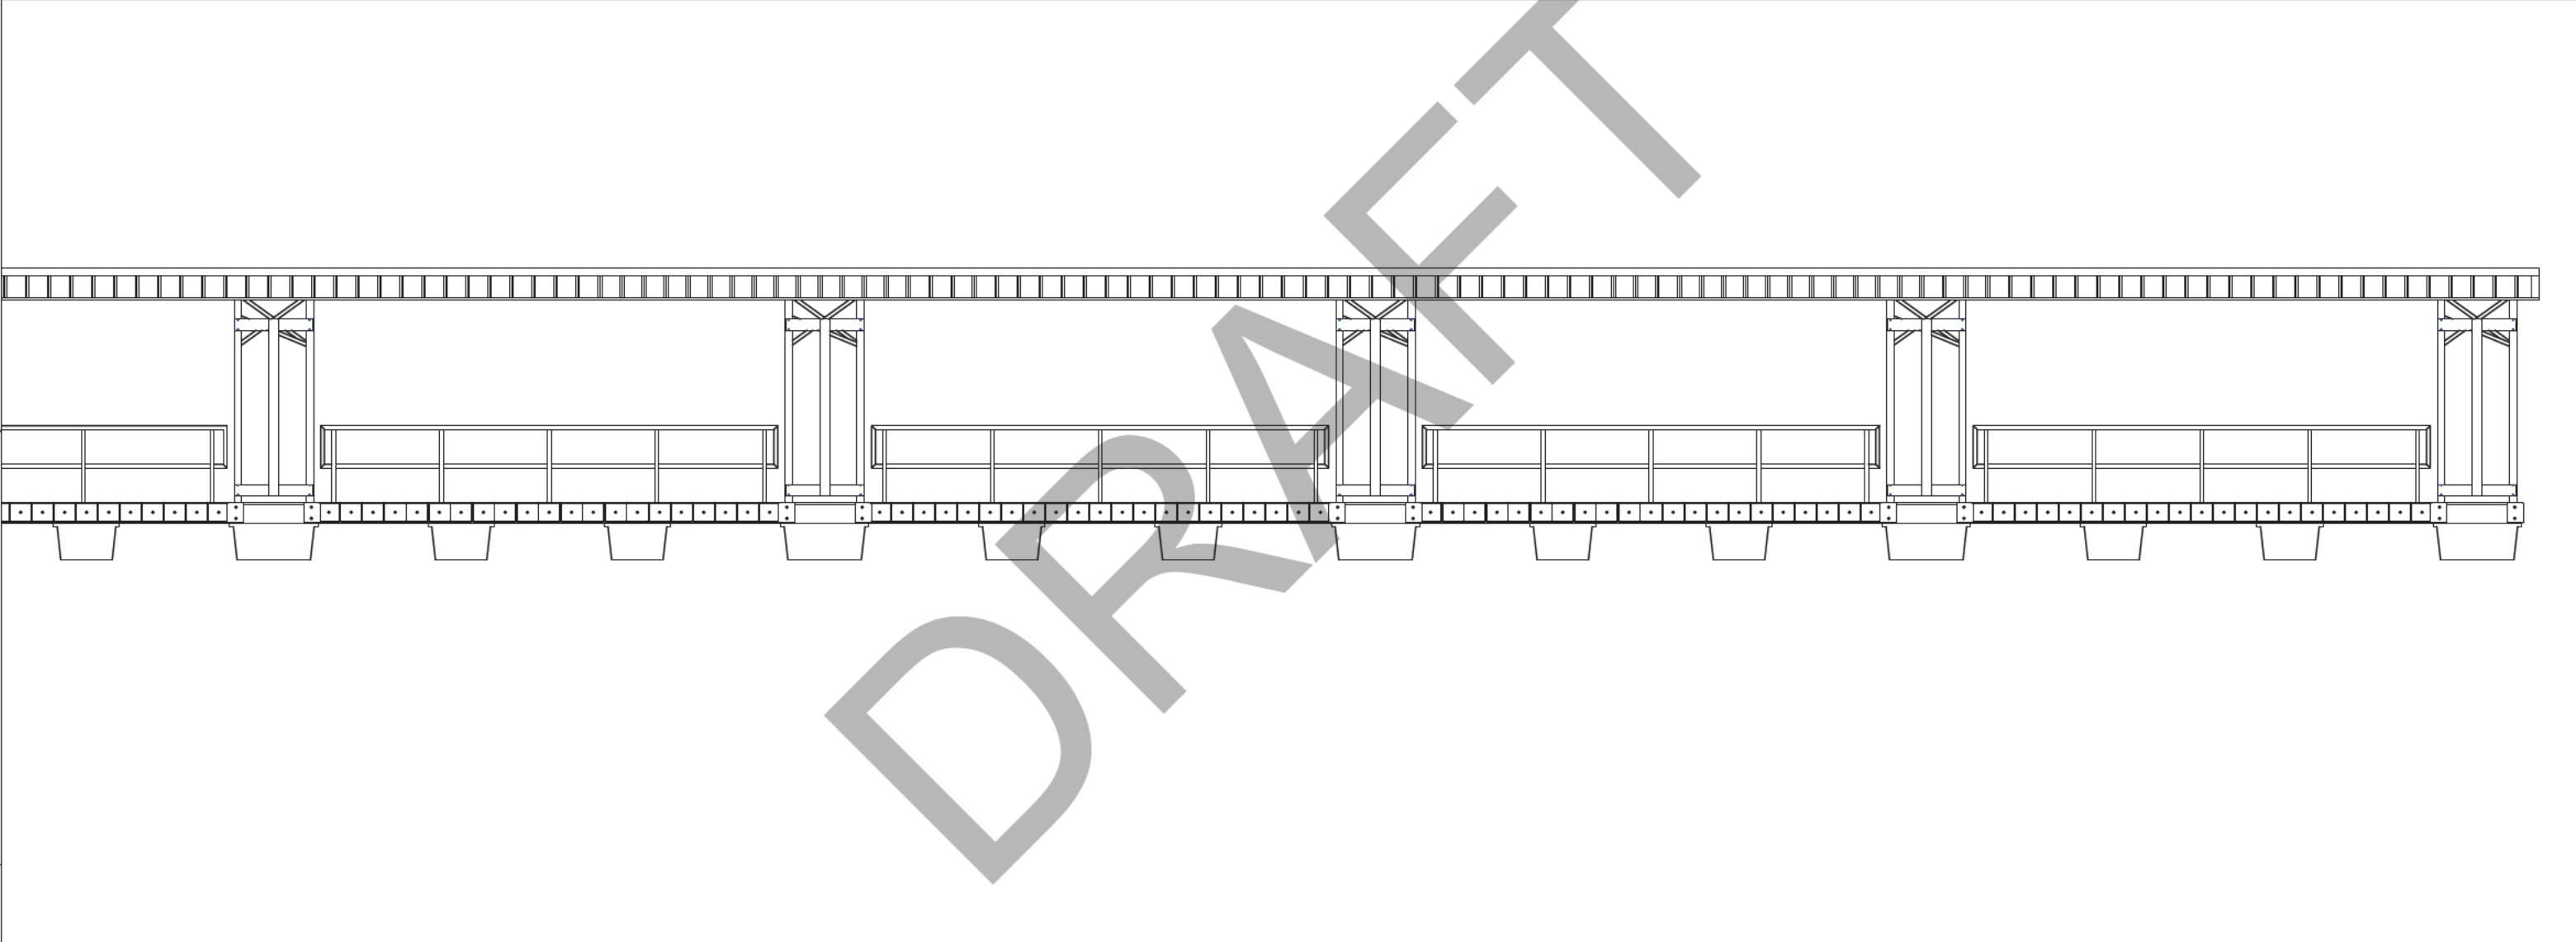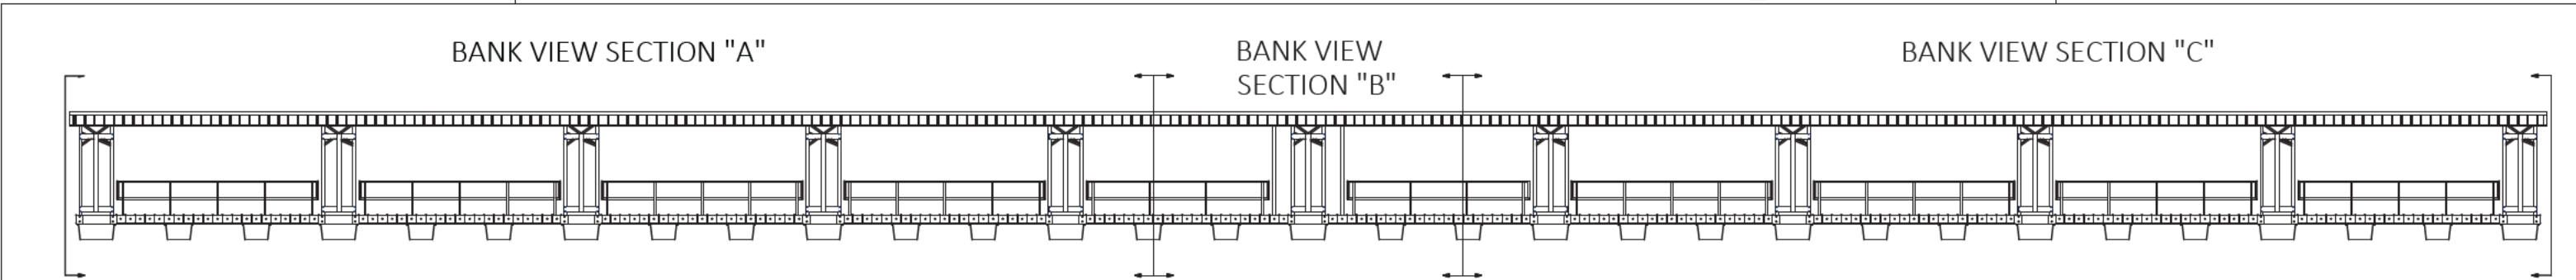

-SHEET DETAIL-		SHORES AT THE COMMON AREA.dwg	
FILE NAME/CUSTOMER	→	WATER VIEW SECTION "A"	
DRAWN:	6/1/2023	SIZE SCALE DWG TYPE/NO. REV	
CHECKED:			
MANAG.APPR:		B 1:80	
ISSUED TO:	MANUFACTURE		
DESIGN DRAFTER:	R.BAKER	SHEET 8 OF 42	
FABRICATOR:			

D

D

C


C

B

B

A

A

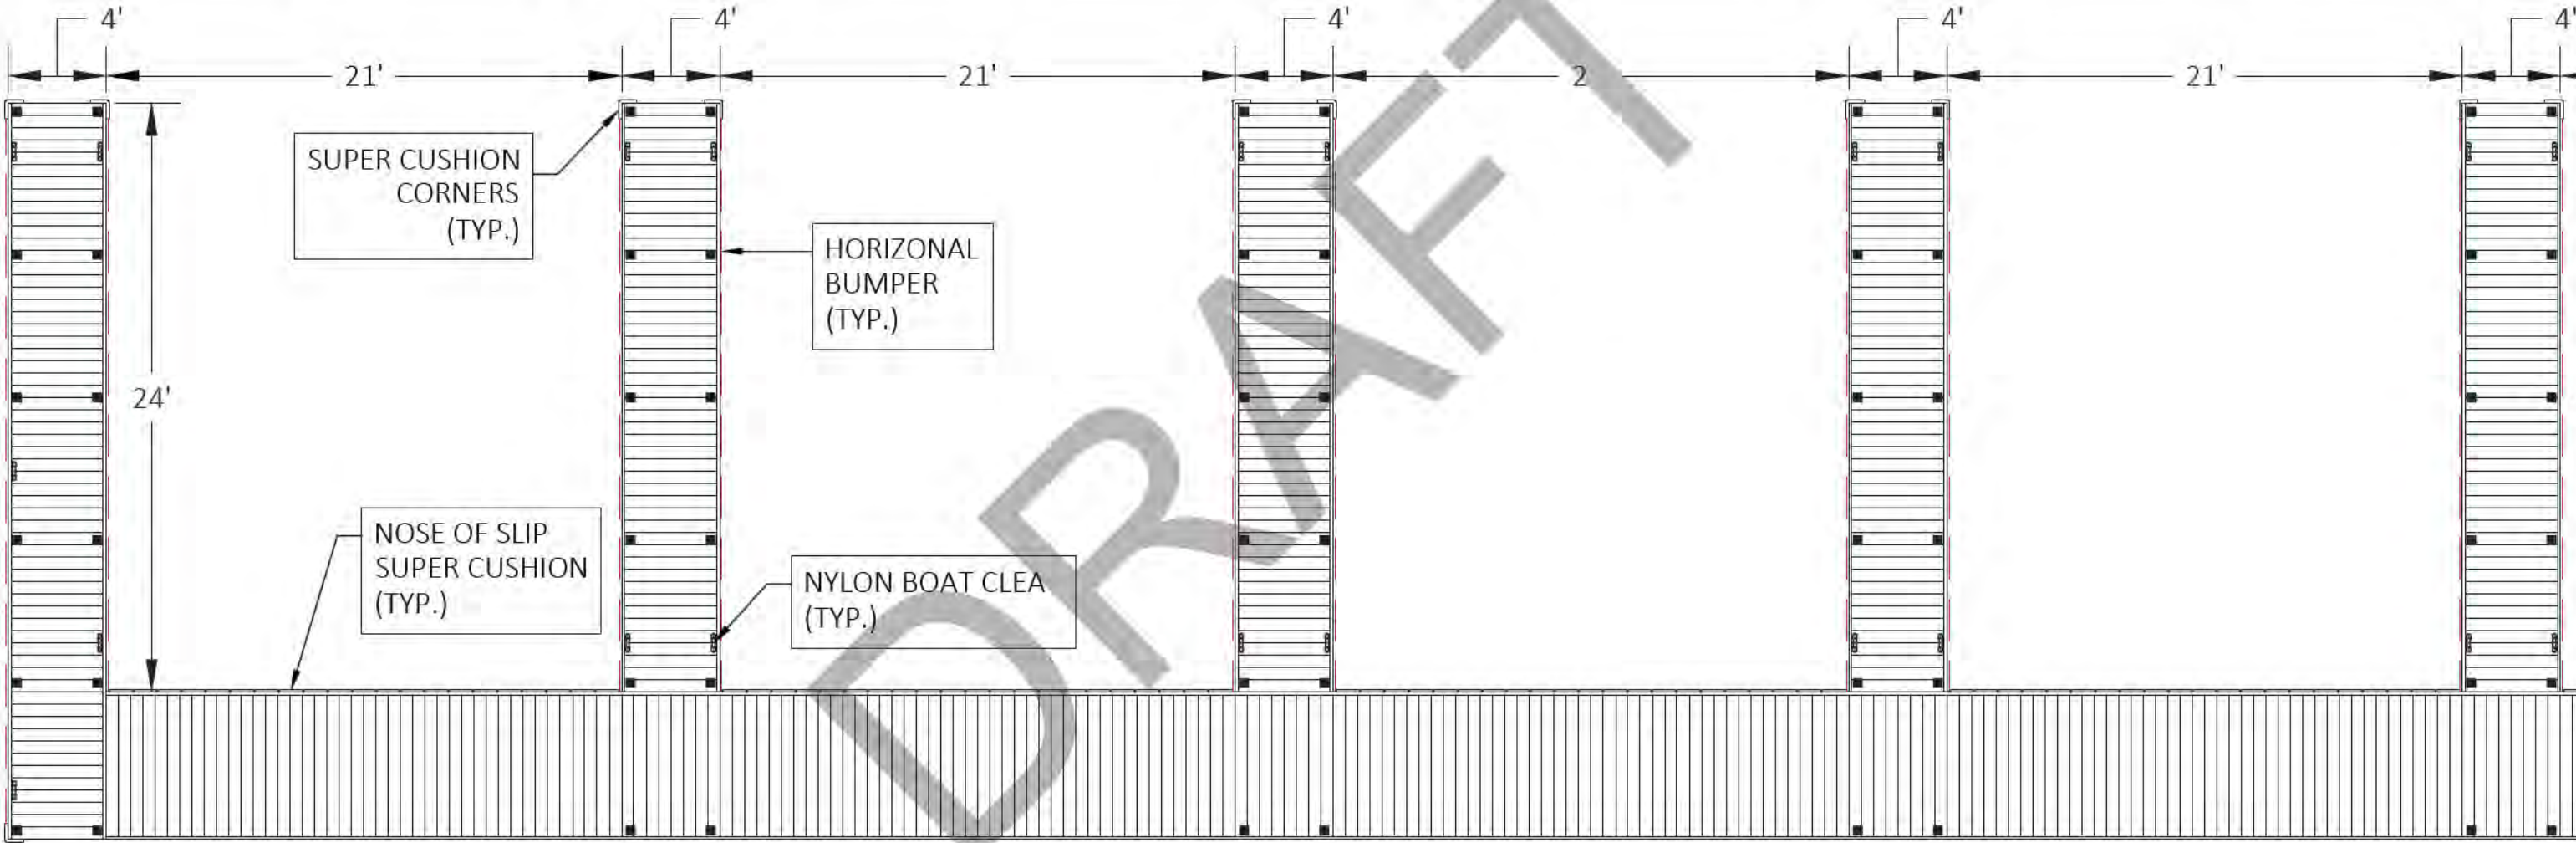

ACC. INCLUDE:

- (105) NOSE OF SLIP SUPER CUSHION
- (42) NYLON BOAT CLEATS
- (540') HORIZONTAL BUMPER
- (24) SUPER CUSHION CORNER BUMPERS

-SHEET DETAIL-

FILE NAME/CUSTOMER

SHORES AT THE COMMON AREA.dwg

DRAWN: 6/1/2023

CHECKED:

MANAG. APPR:

ISSUED TO: MANUFACTURE

DESIGN DRAFTER: R. BAKER

FABRICATOR:

PLAN VIEW

SIZE B SCALE 1:50

DWG TYPE/NO.

REV

0

SHEET 9 OF 42



D

D

C


C

B

B

A

A

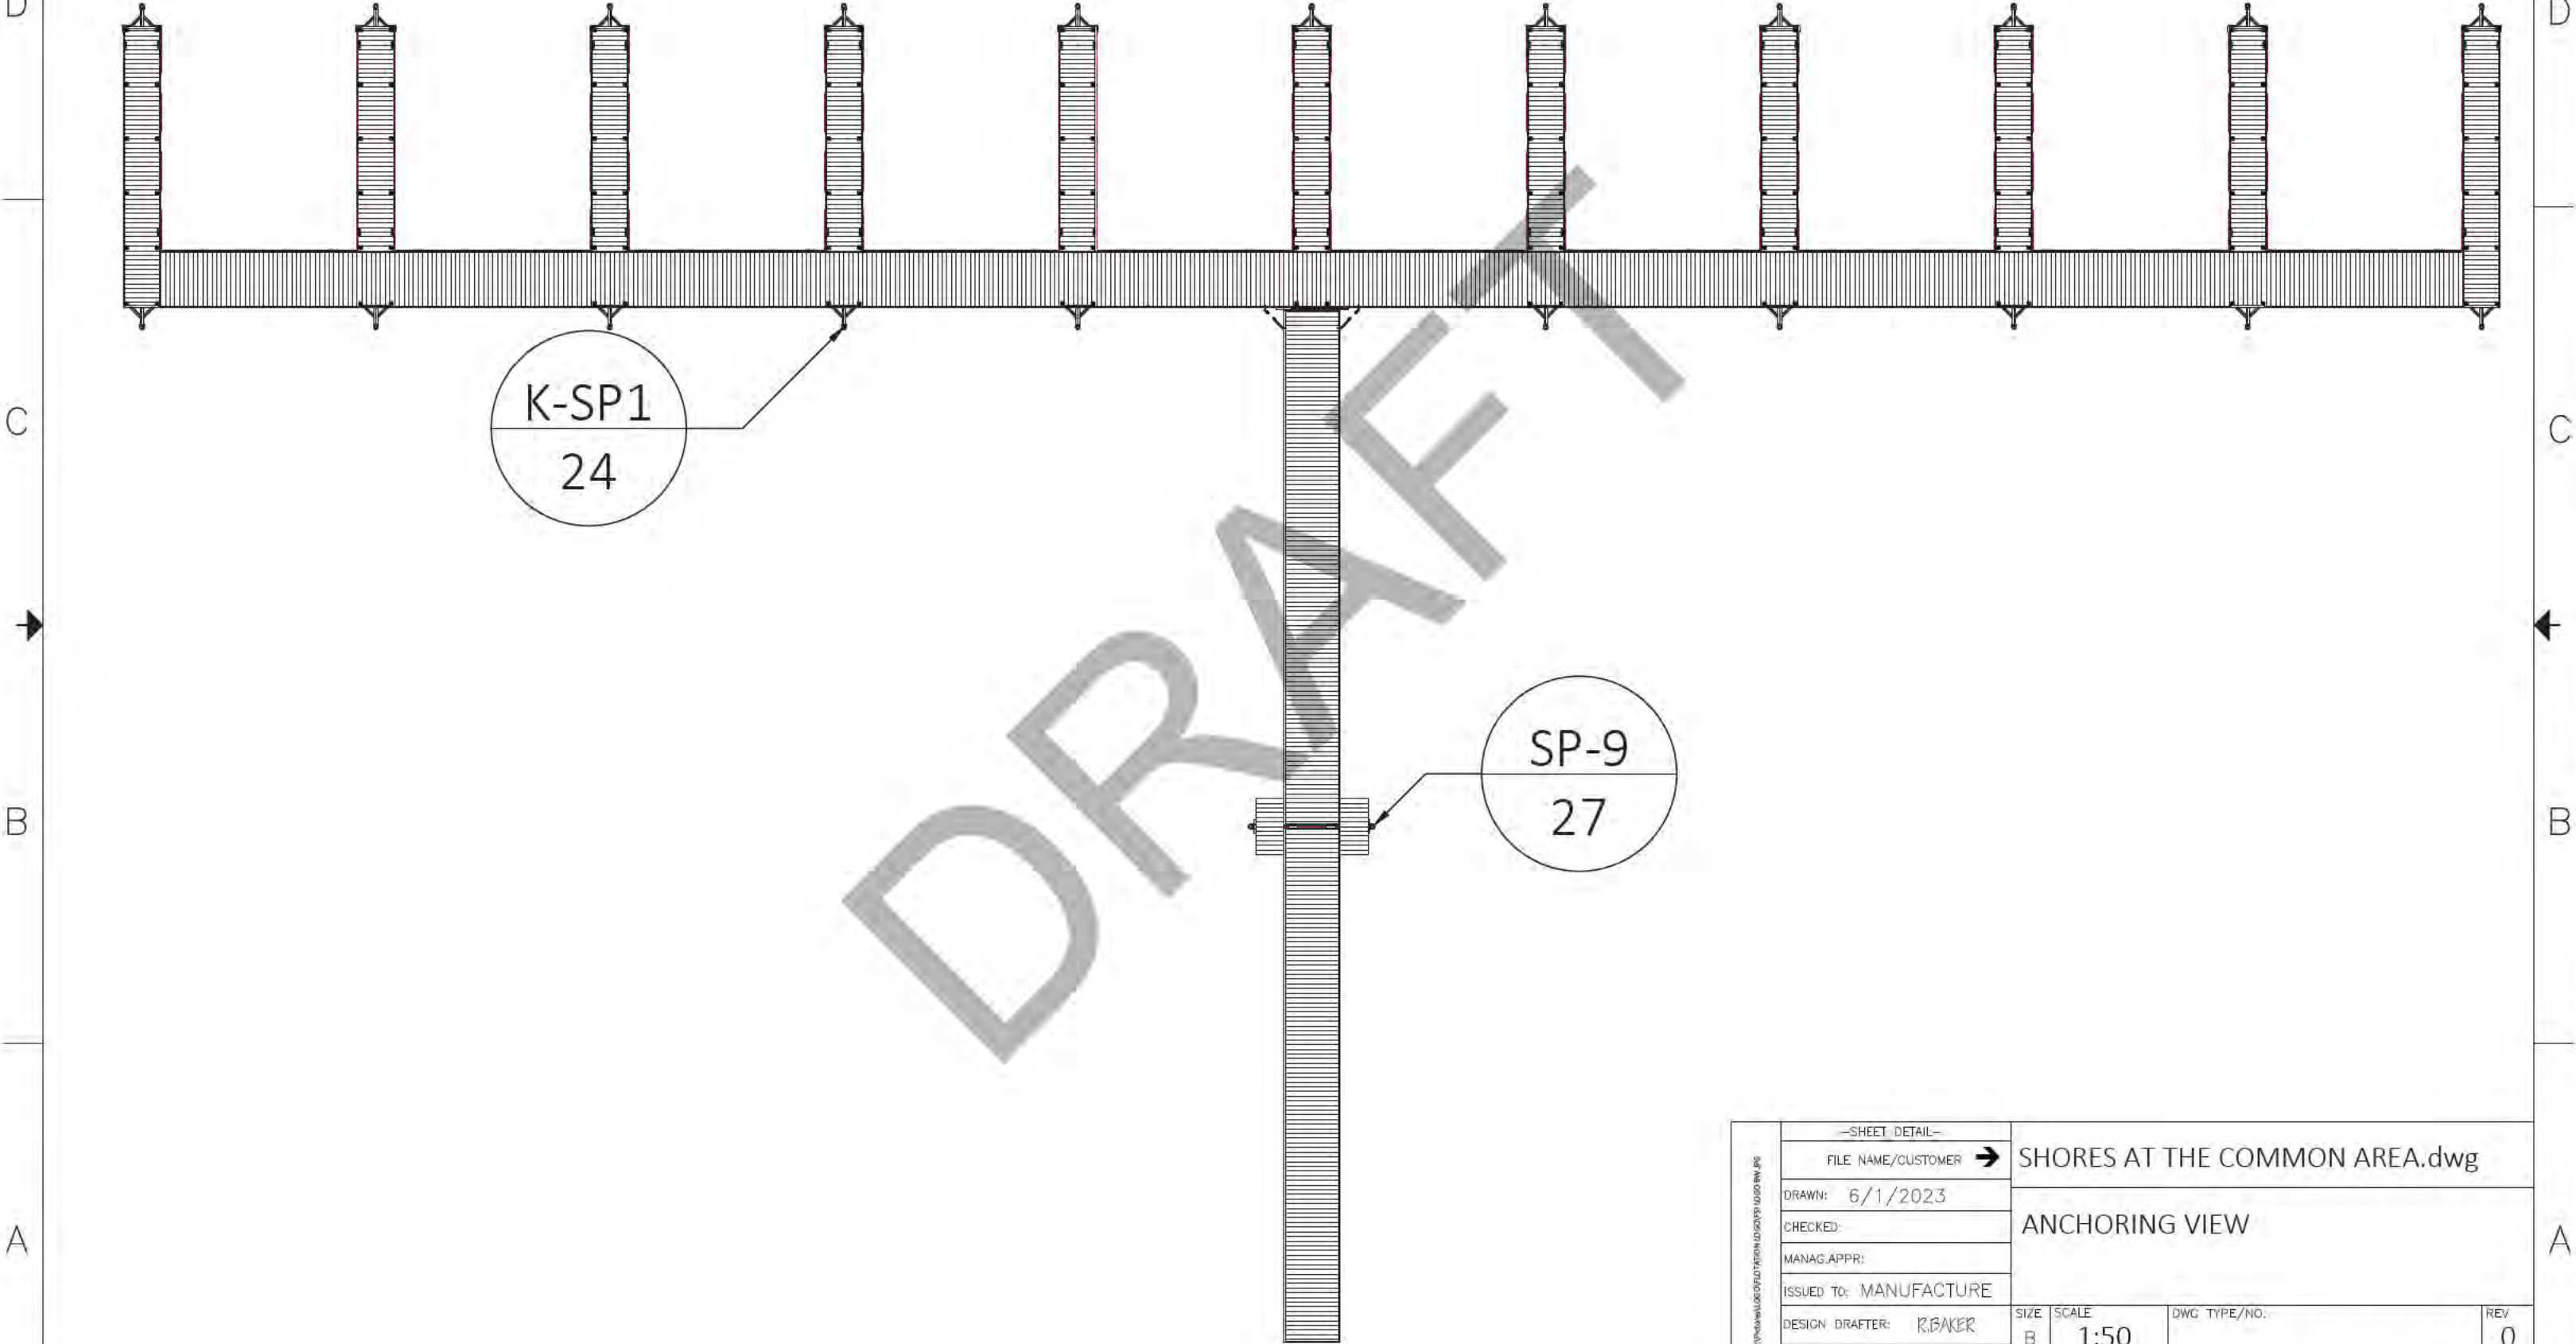

SHEET 10 OF 42	—SHEET DETAIL—			SHORES AT THE COMMON AREA.dwg			
	FILE NAME/CUSTOMER ➔						
	DRAWN: 6/1/2023			ANCHORING VIEW			
	CHECKED:						
	MANAG.APPR:						
	ISSUED TO: MANUFACTURE						
	DESIGN DRAFTER: R.BAKER			SIZE B	SCALE 1:50	DWG TYPE/NO.:	REV 0
	FABRICATOR:					SHEET 10 OF 42	

D

D

C


C

B


B

A

A

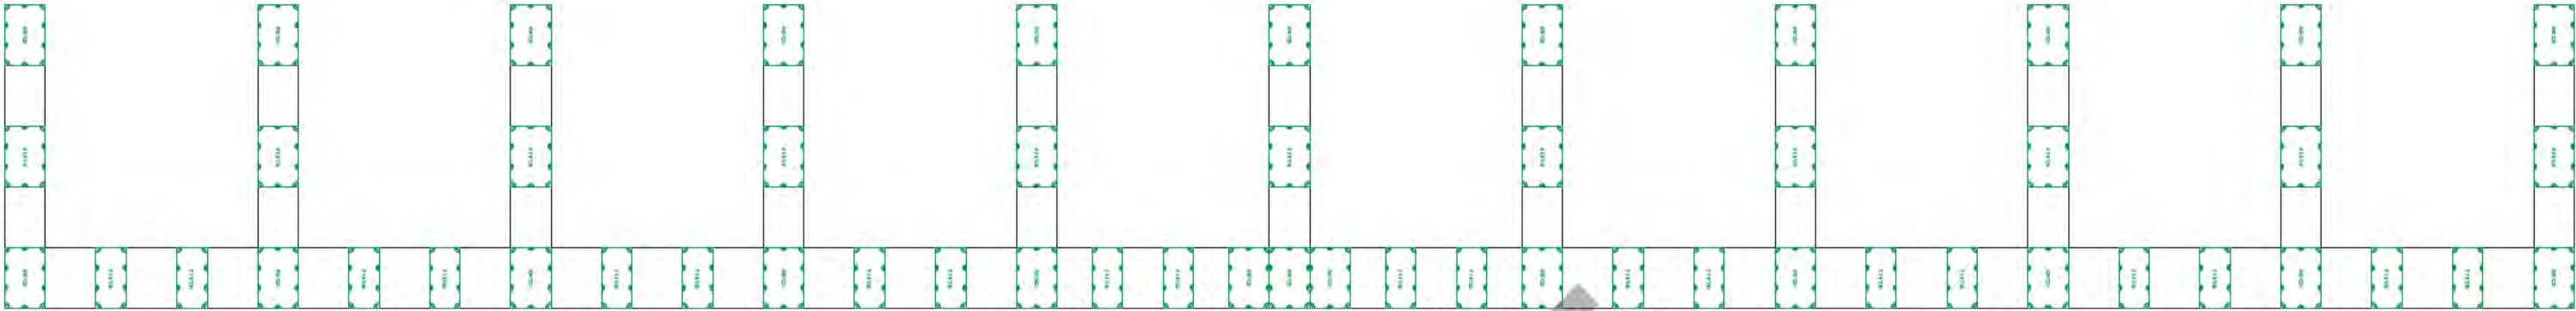


RAMP ATTACHMENT F OATATION

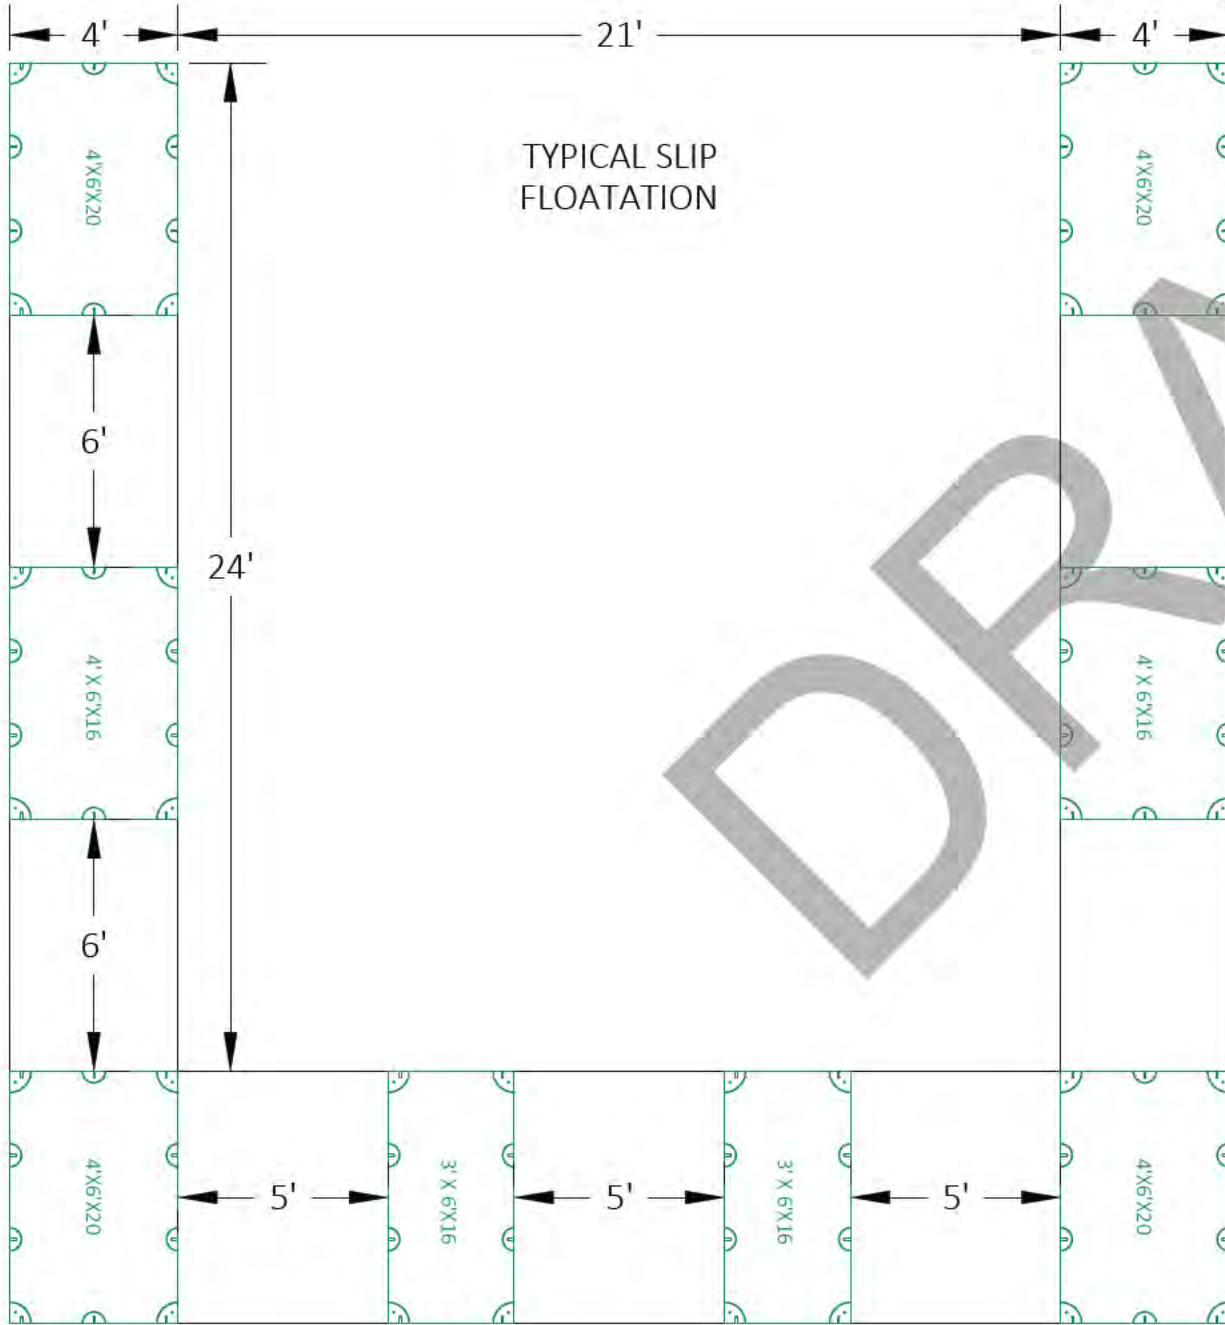

TYPICAL SLIP
FLOATATION


RAMP ATTACHMENT FLOATATION

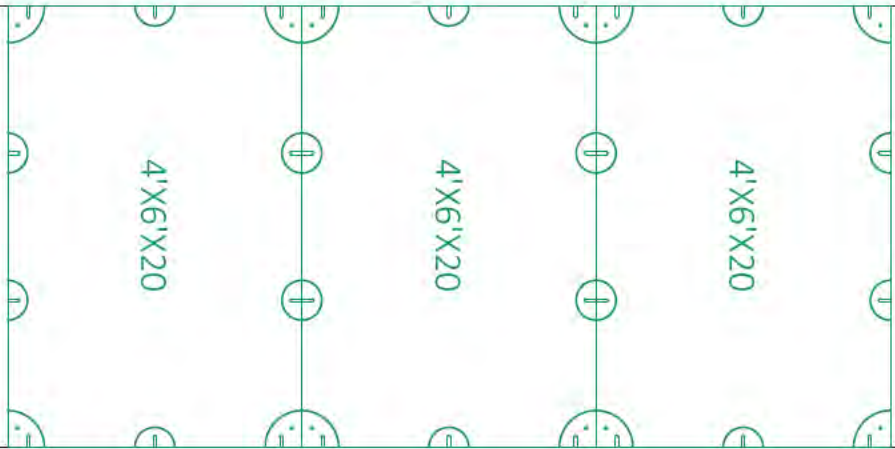

4 X 6 X16-11
4 X 6 X 20-24
3 X 6 X 16-20


SHEET 11 OF 42	--SHEET DETAIL--		SHORES AT THE COMMON AREA.dwg			
	FILE NAME/CUSTOMER →					
	DRAWN: 6/1/2023		FLOAT DIAGRAM			
	CHECKED:					
	MANAG.APPR:					
	ISSUED TO: MANUFACTURE					
	DESIGN DRAFTER: R.BAKER					SIZE B
	FABRICATOR:		SHEET 11 OF 42			

(2) 3/8"X5 1/2" H.B.
(4) 3/8"X7/8" WASHERS
(2) 3/8" NYLOCK NUTS
PER POST

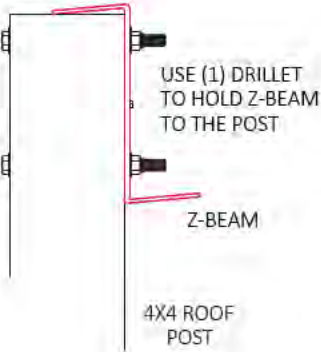

OVERHANG THE
ROOF POST 1'

Z-BEAM LAPS OVER
THE NEXT Z-BEAM 4'

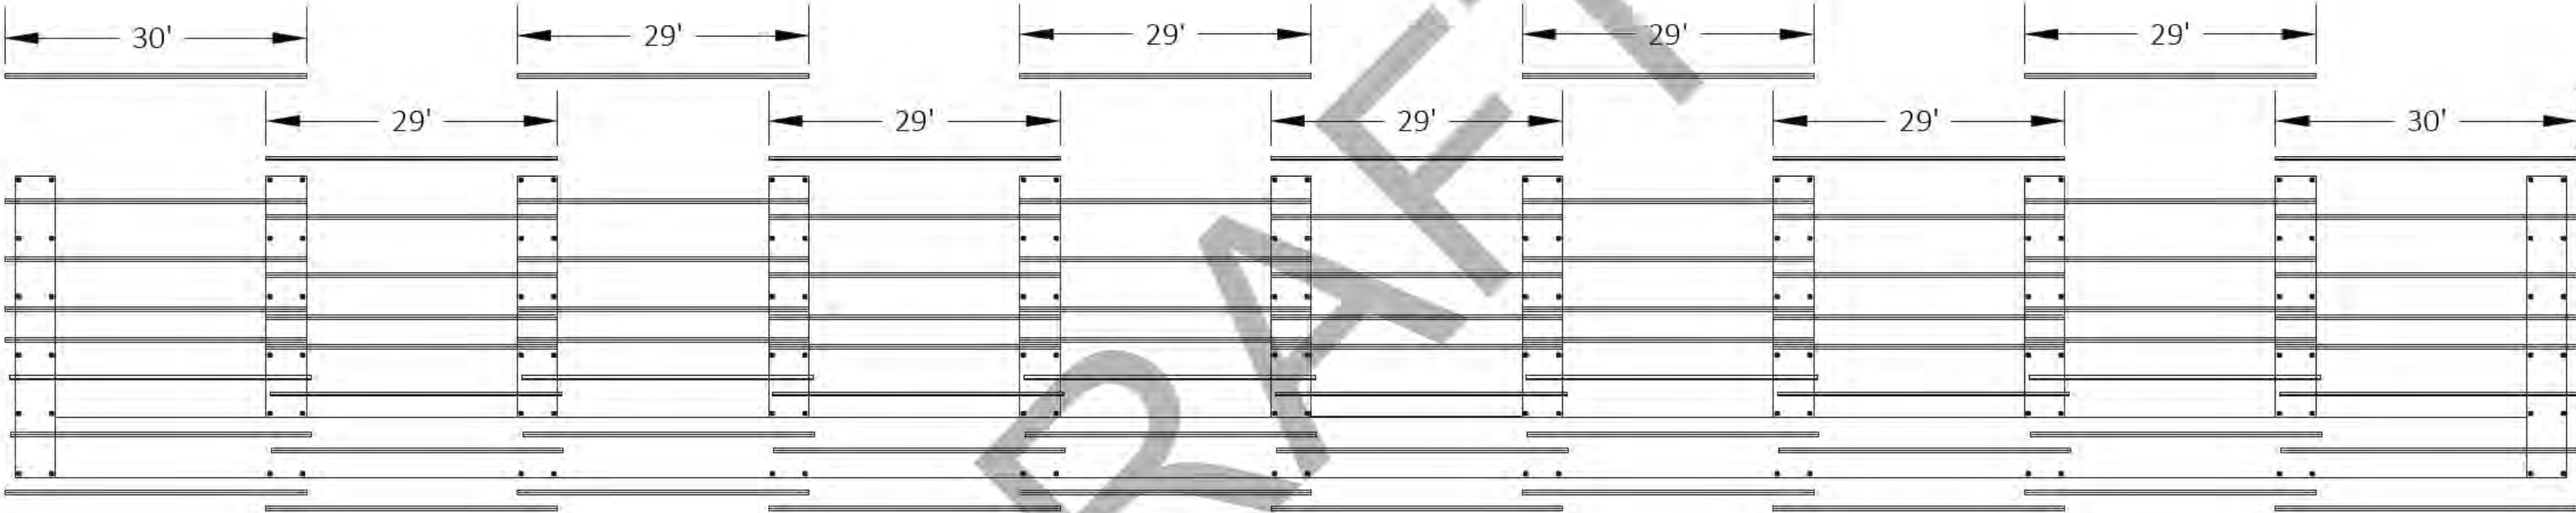

SHEET 12 OF 42	--SHEET DETAIL--		SHORES AT THE COMMON AREA.dwg			
	FILE NAME/CUSTOMER →		ROOF ASSEMBLY			
	DRAWN: 6/1/2023					
	CHECKED:		SIZE SCALE DWG TYPE/NO. REV			
	MANAG.APPR:					
	ISSUED TO: MANUFACTURE					
	DESIGN DRAFTER: K.BAKER					
FABRICATOR:		B 1:180		SHEET 12 OF 42		



D

D

C


C

B

B

A


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SHEET INFORMATION SHEET NO. 13 OF 42 DATE: 6/1/2023 DRAWN BY: R. BAKER	--SHEET DETAIL--			SHORES AT THE COMMON AREA.dwg
	FILE NAME/CUSTOMER ➔			
	DRAWN: 6/1/2023			FRAME DIAGRAM
	CHECKED:			
	MANAG.APPR:			
	ISSUED TO: MANUFACTURE			
	DESIGN DRAFTER: R.BAKER			
	FABRICATOR:			
SIZE	SCALE	DWG TYPE/NO.		REV
B	1:180			0
				SHEET 13 OF 42

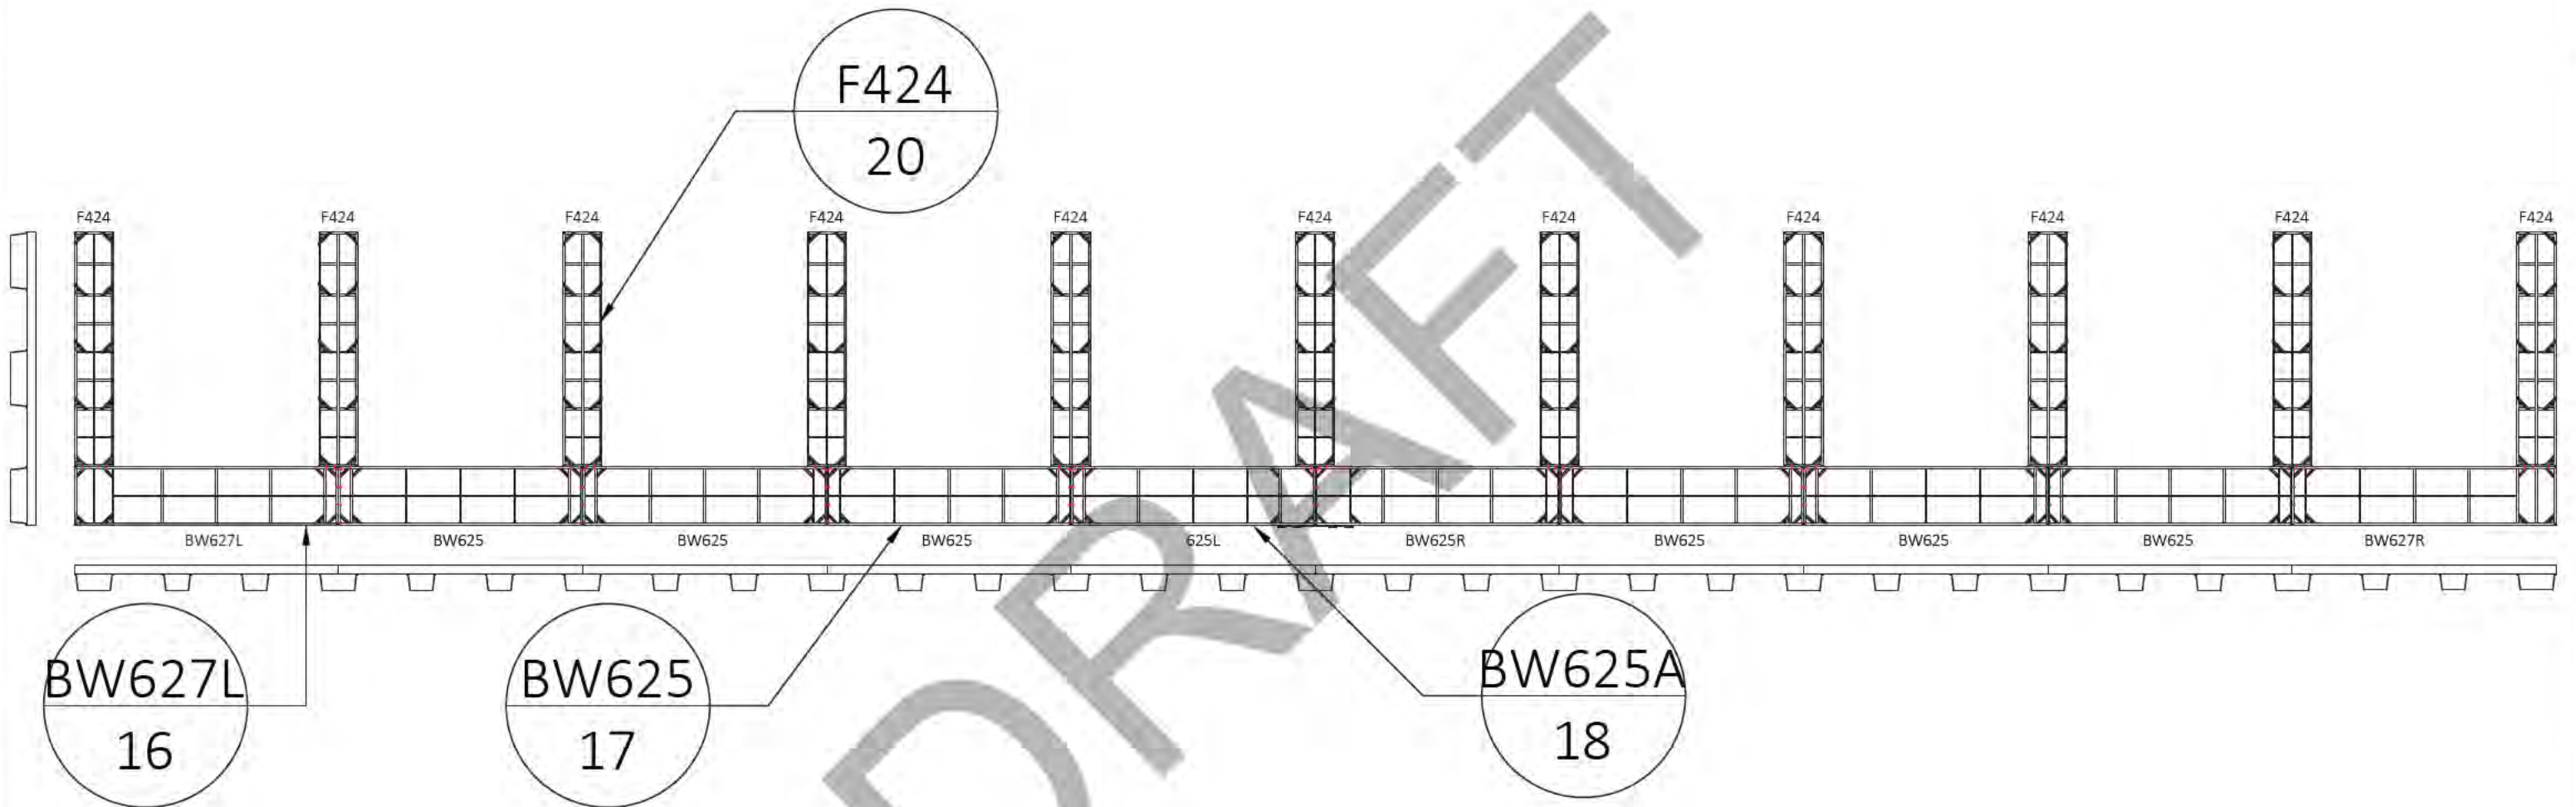D

D



C

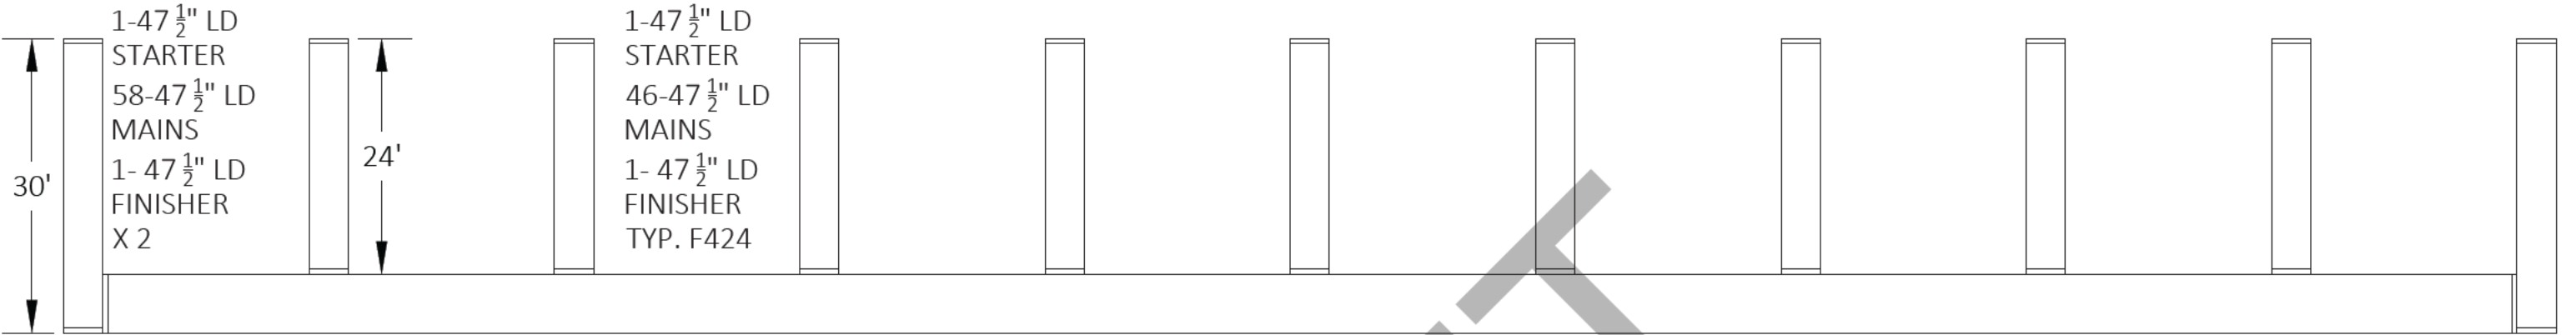C

1-5' 11 1/2" LD STARTER
490-5' 11 1/2" LD MAINS
1- 5' 11 1/2" LD FIN SHER

B

B


DECKING CUT LIST		
QTY.	DESCRIPTION	COLOR
530	47-1/2" LOCKDRY MAINS	
490	5' 11-1/2" LOCKDRY MAINS	
11	47-1/2" LOCKDRY STARTER	
1	5' 11-1/2" LOCKDRY STARTER	
11	47-1/2" LOCKDRY FINISHER	
1	5' 11-1/2" LOCKDRY FINISHER	

A

A

D:\Programs\LockDry\COMMON LOCKDRY.dwg	-SHEET DETAIL-		SHORES AT THE COMMON AREA.dwg				
	FILE NAME/CUSTOMER ➔						
	DRAWN: 6/1/2023		DECKING DIAGRAM				
	CHECKED:						
	MANAG.APPR:						
	ISSUED TO: MANUFACTURE						
	DESIGN DRAFTER: R.BAKER						SIZE B
	FABRICATOR:						SHEET 14 OF 42

CUT/STOCK LIST						
DIE NUMBER	ITEM	QTY.	DESCRIPTION	FT.	IN.	TOTAL FT.
FH-07803	A	44	4"X4" POST	10	2	447.3333
FH-07803	B	22	4"X4" POST	10	8-1/16	234.7813
FH-07803	C	22	4"X4" POST	11	2-3/16	246.0104
FH-07803	D	22	4"X4" POST	11	2 3/8	246.3542
FH-07803	E	22	4"X4" POST	10	8 1/4	235.1250

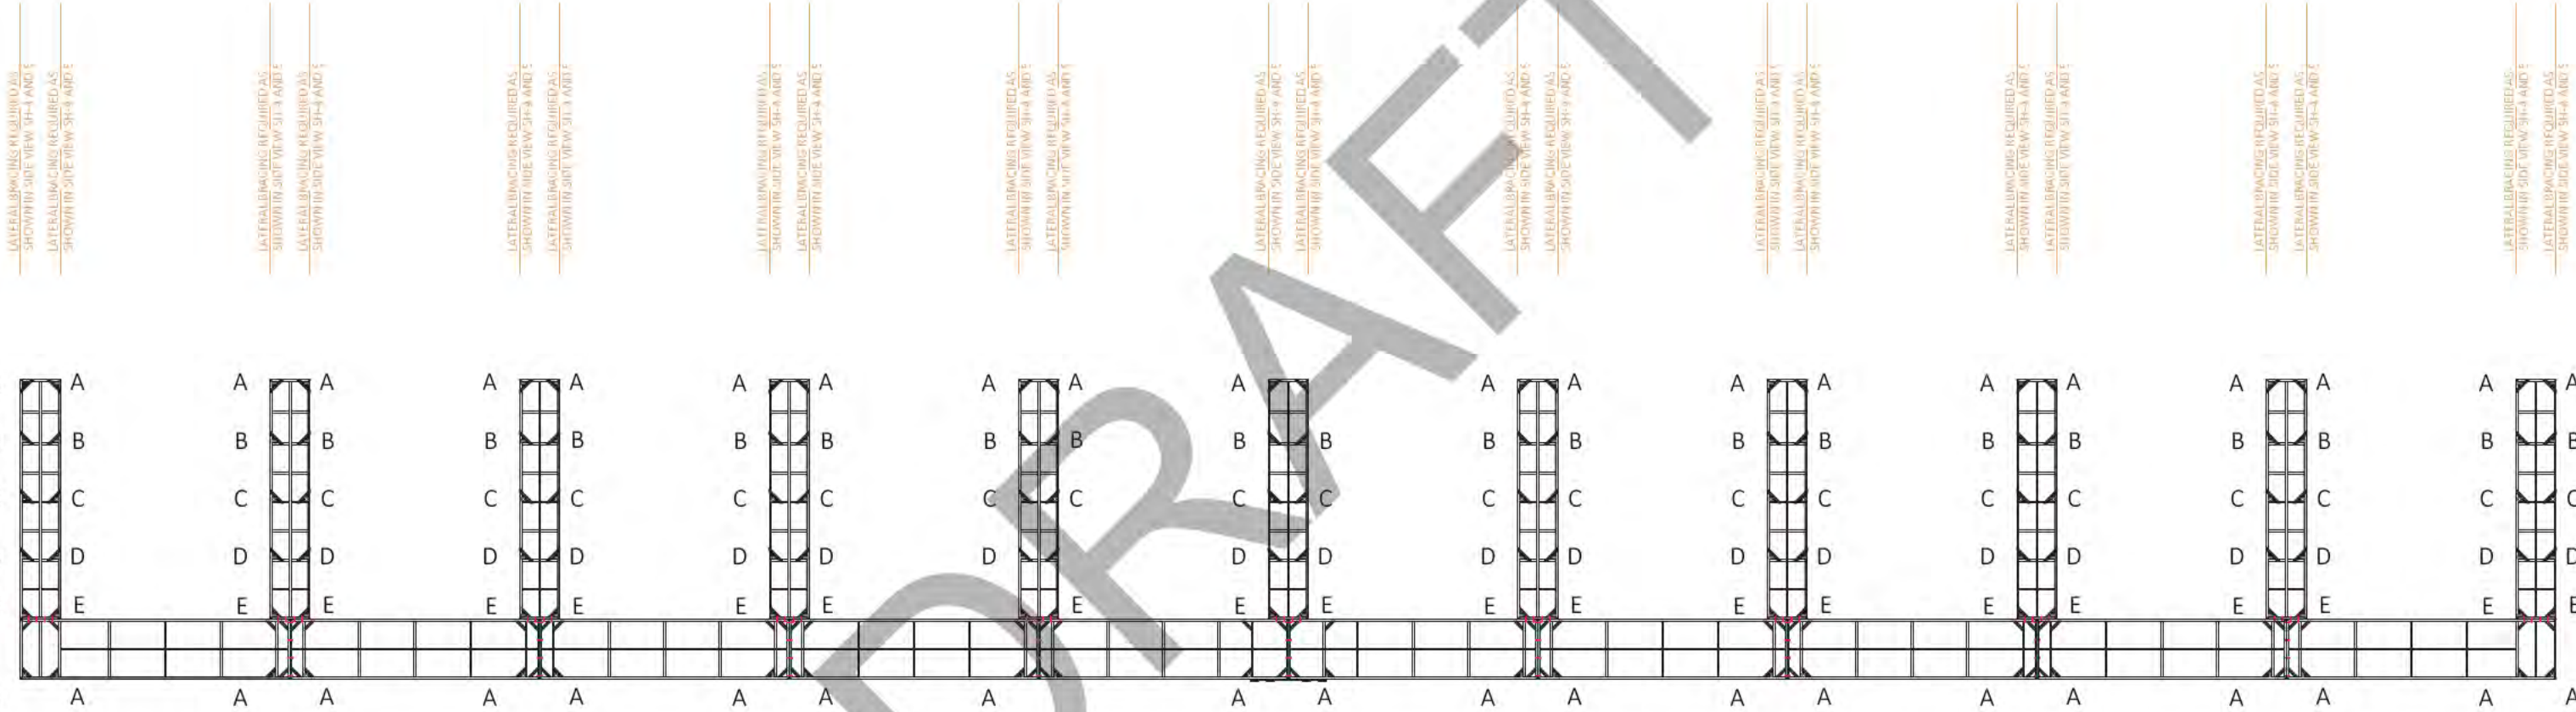

SHORES AT THE COMMON AREA.dwg

FILE NAME/CUSTOMER

DRAWN: 6/1/2023

CHECKED:

MANAG.APPR:

ISSUED TO: MANUFACTURE

DESIGN DRAFTER: R.BAKER

FABRICATOR:

POST DIAGRAM




SIZE B SCALE 1:180 DWG TYPE/NO. REV 0

SHEET 15 OF 42

CUT LIST							
DIE NUMBER	ITEM	QTY.	DESCRIPTION	DEGREE	FT	IN	TOTAL FT
FS-084499	A	2	10" H.W.	45°-45°	27	0"	54.000000
FS-084499	B	2	10" H.W.	45°-45°	6	0"	12.000000
FS-084499	C	1	10" H.W.	0°-0°	5	7 1/2"	#####
FS-04306	D	4	8" L.W.	0°-0°	5	7 1/2"	#####
FH-07805	E	3	CORNER SLEEVE	0°-0°		10"	2.500000
FH-00487	F	16	1"X2" GUSSET	45°-45°	1	9 13/16"	#####
FH-01356	G	1	1/8" X 2" X 2" TUBE	0°-0°	22	9 3/4"	#####
FH-01356	H	1	1/8" X 2" X 2" TUBE	0°-0°	5	7 1/2"	#####
FS-04774	I	6	2" X 2" ANGLE	0°-0°		2"	1.000000

NOTE:
.375" X 5 1/2" BOLTS WILL BE USED TO ATTACH
LEFT AND RIGHT BACKWALKS TOGETHER AND
FINGERS TO THE BACKWALK


NOTE:
USE .375 WELD OF APPROPRIATE TYPE PER
SHOP STANDARD (TYP.) OR AS NOTED

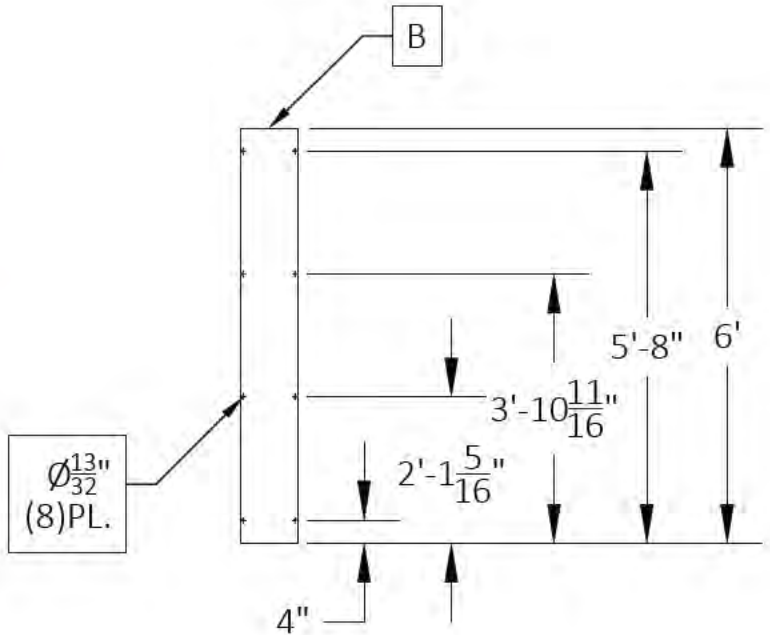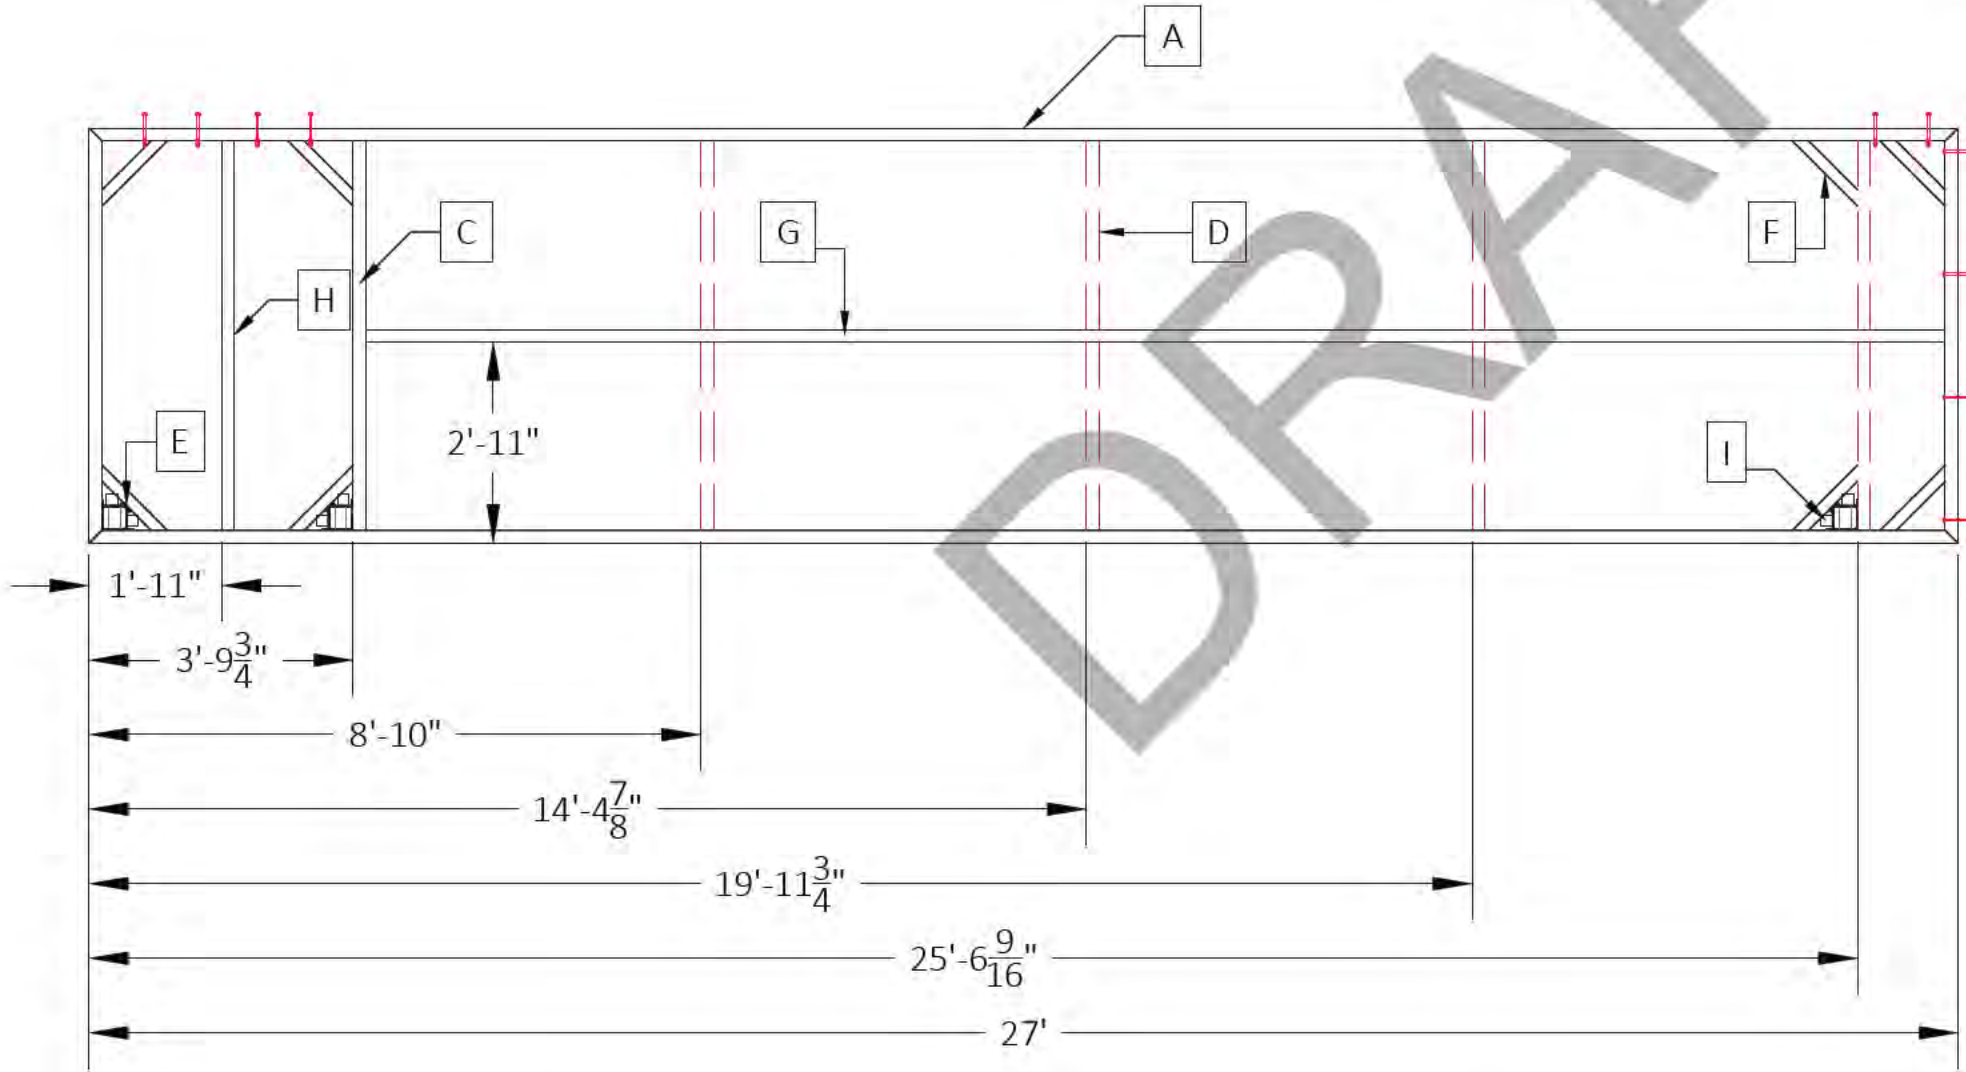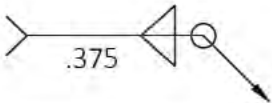

BW627L

(1)REQUIRED




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FILE NAME/CUSTOMER		BW627L			
DRAWN: 6/1/2023					
CHECKED:					
MANAG.APPR:					
ISSUED TO: MANUFACTURE					
DESIGN DRAFTER: R.BAKER		SIZE B	SCALE 1:34	DWG TYPE/NO.	REV 0
FABRICATOR:		SHEET 16 OF 42			

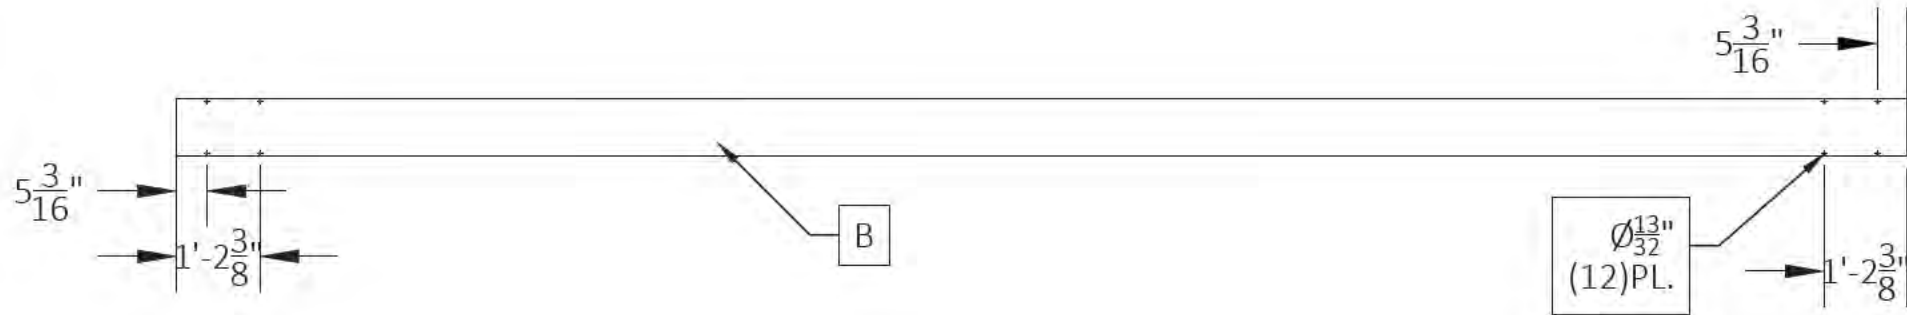

CUT LIST							
DIE NUMBER	ITEM	QTY.	DESCRIPTION	DEGREE	FT	IN	TOTAL FT
FS-084499	A	2	10" H.W.	45°-45°	25	0"	50.000000
FS-084499	B	2	10" H.W.	45°-45°	6	0"	12.000000
FS-04306	C	5	8" L.W.	0°-0°	5	7 1/2"	#####
FH-07805	D	2	CORNER SLEEVE	0°-0°		10"	1.666667
FH-00487	E	16	1"X2" GUSSET	45°-45°	1	9 13/16"	#####
FH-01356	F	1	1/8" X 2" X 2" TUBE	0°-0°	24	7 1/2"	#####
FS-04774	G	4	2" X 2" ANGLE	0°-0°		2"	0.666667

NOTE:
.375" X 5 1/2" BOLTS WILL BE USED TO ATTACH
LEFT AND RIGHT BACKWALKS TOGETHER AND
FINGERS TO THE BACKWALK

NOTE:
USE .375 WELD OF APPROPRIATE TYPE PER
SHOP STANDARD (TYP.) OR AS NOTED

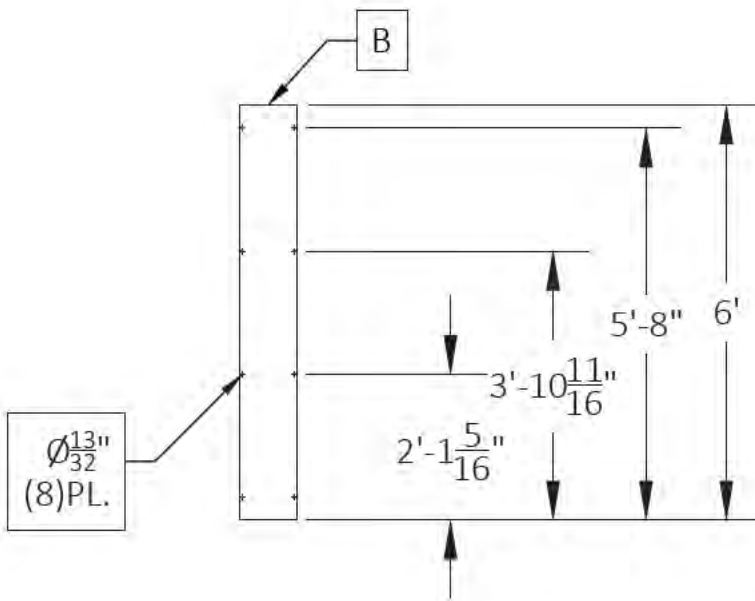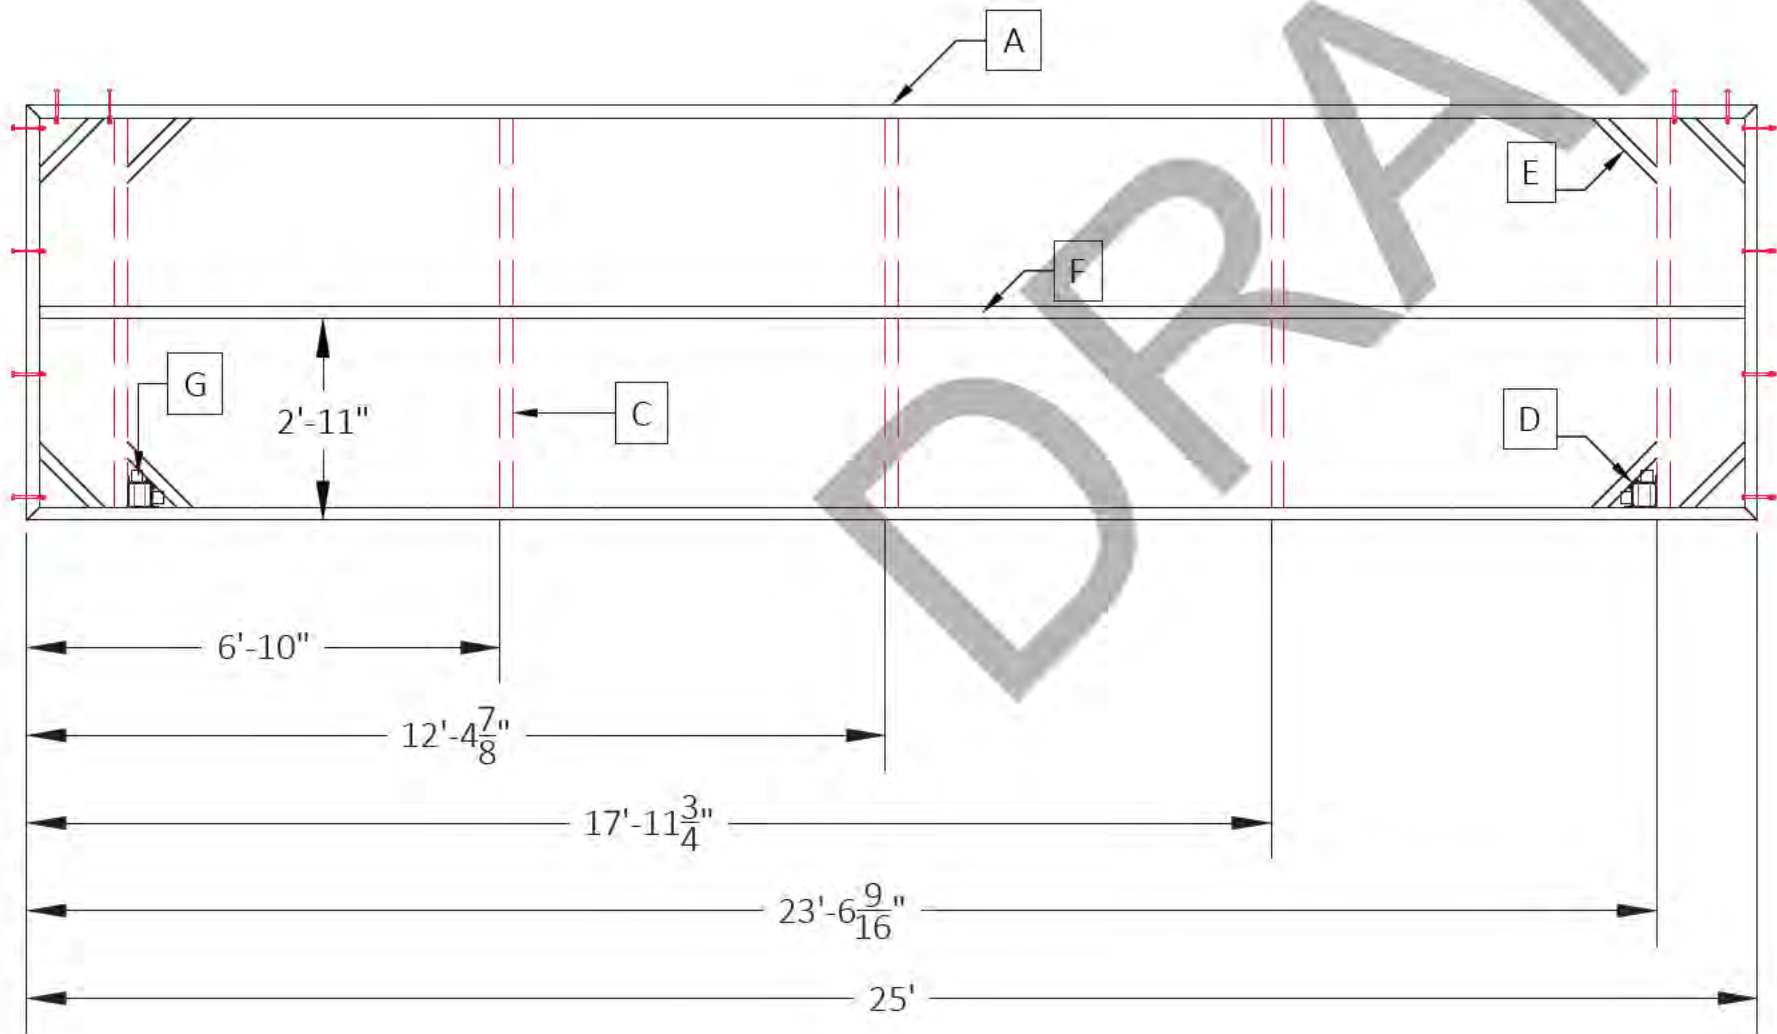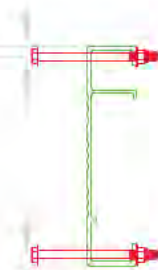

BW625




(6)REQUIRED

-SHEET DETAIL-		SHORES AT THE COMMON AREA.dwg			
FILE NAME/CUSTOMER		BW625			
DRAWN: 6/1/2023					
CHECKED:					
MANAG.APPR:					
ISSUED TO: MANUFACTURE					
DESIGN DRAFTER: R.BAKER		SIZE B	SCALE 1:34	DWG TYPE/NO.	REV 0
FABRICATOR:		SHEET 17 OF 42			

CUT LIST							
DIE NUMBER	ITEM	QTY	DESCRIPTION	DEGREE	FT	IN	TOTAL FT
FS-084499	A	2	10" H.W.	45°-45°	25	0"	50.000000
FS-084499	B	2	10" H.W.	45°-45°	6	0"	12.000000
FS-04306	C	5	8" L.W.	0°-0°	5	7 1/2"	#####
FH-07805	D	2	CORNER SLEEVE	0°-0°		10"	1.666667
FH-00487	E	16	1"X2" GUSSET	45°-45°	1	9 13/16"	#####
FH-01356	F	1	1/8" X 2" X 2" TUBE	0°-0°	24	7 1/2"	#####
FS-04774	G	6	2" X 2" ANGLE	0°-0°		2"	1.000000

NOTE:
.375" X 5 1/2" BOLTS WILL BE USED TO ATTACH
LEFT AND RIGHT BACKWALKS TOGETHER AND
FINGERS TO THE BACKWALK

NOTE:
USE .375 WELD OF APPROPRIATE TYPE PER
SHOP STANDARD (TYP.) OR AS NOTED

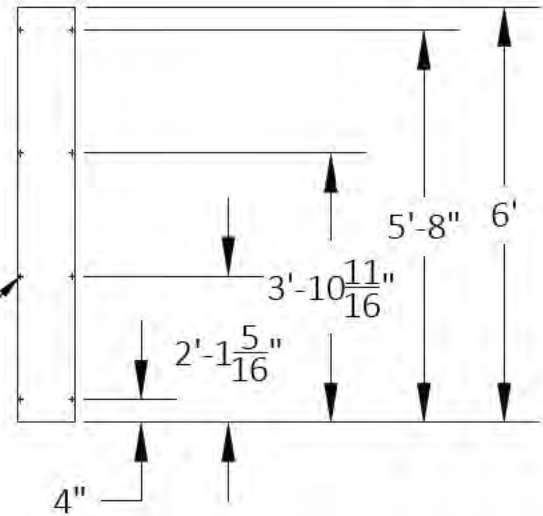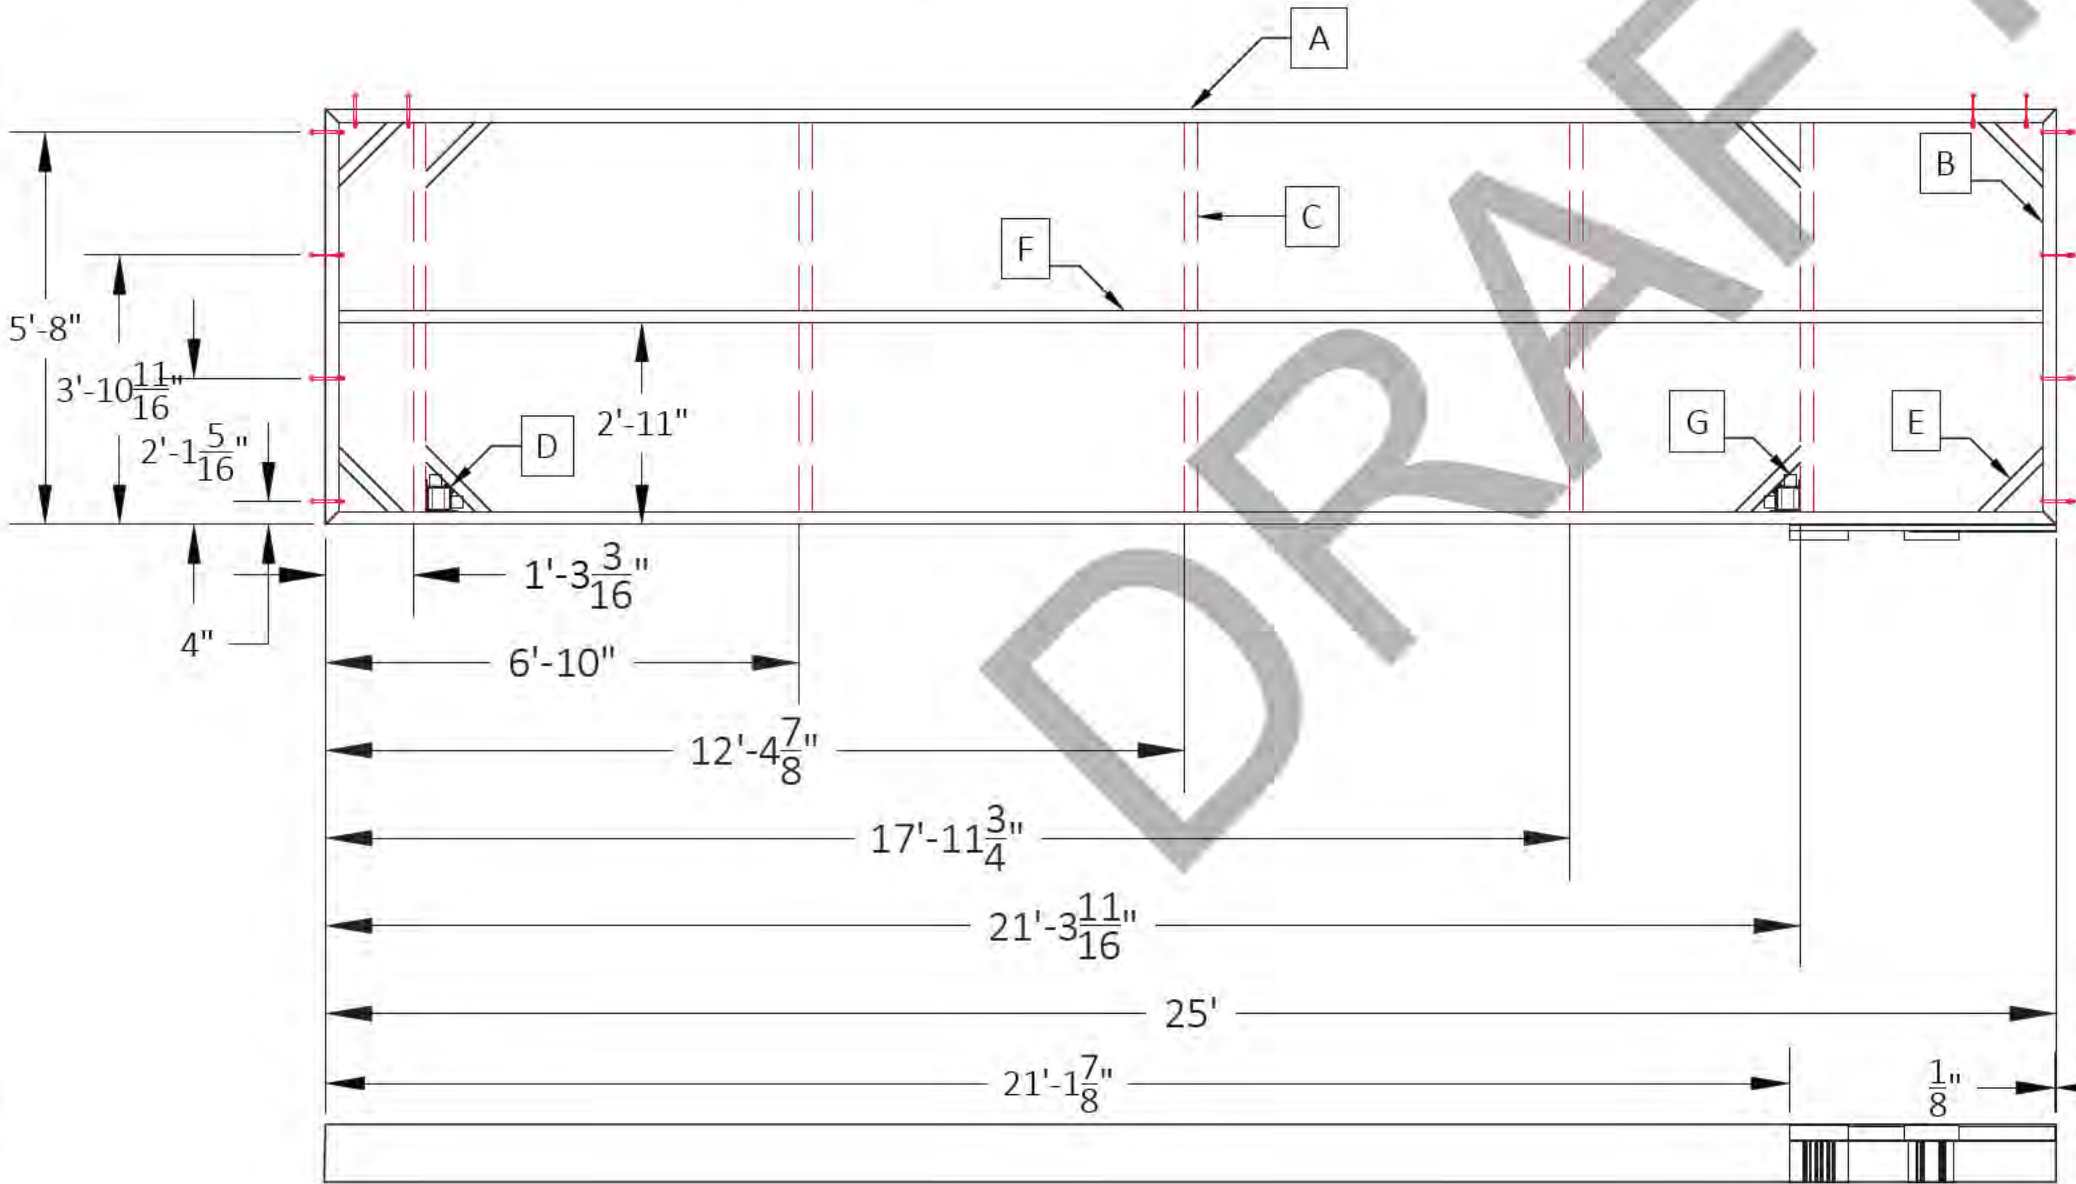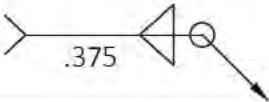

BW625L

(1)REQUIRED


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FILE NAME/CUSTOMER		SHORES AT THE COMMON AREA.dwg			
DRAWN: 6/1/2023		BW625L			
CHECKED:					
MANAG.APPR:					
ISSUED TO: MANUFACTURE					
DESIGN DRAFTER: R.BAKER		SIZE B	SCALE 1:34	DWG TYPE/NO.	REV 0
FABRICATOR:					
		SHEET 18 OF 42			

CUT LIST							
DIE NUMBER	ITEM	QTY.	DESCRIPTION	DEGREE	FT	IN	TOTAL FT
FH-07812	A	2	RAMP PIPE	0°-0°		10"	1.67
FH-07812	B	2	RAMP PIPE	0°-0°		9 9/16"	####
FS-07813	C	1	PAMP TRACK	0°-0°	3	10"	3.83
FS-08499	D	2	10" H.W.	0°-0°		7"	1.17
FS-00431	E	2	8" H.W.	0°-0°		7"	1.17

*MEASUREMENTS MUST BE EXACT!

WELD THE RAMP
TRACK TO THE FRAME!!

NOTE:
USE .375 WELD OF APPROPRIATE TYPE PER
SHOP STANDARD (TYP.) OR AS NOTED

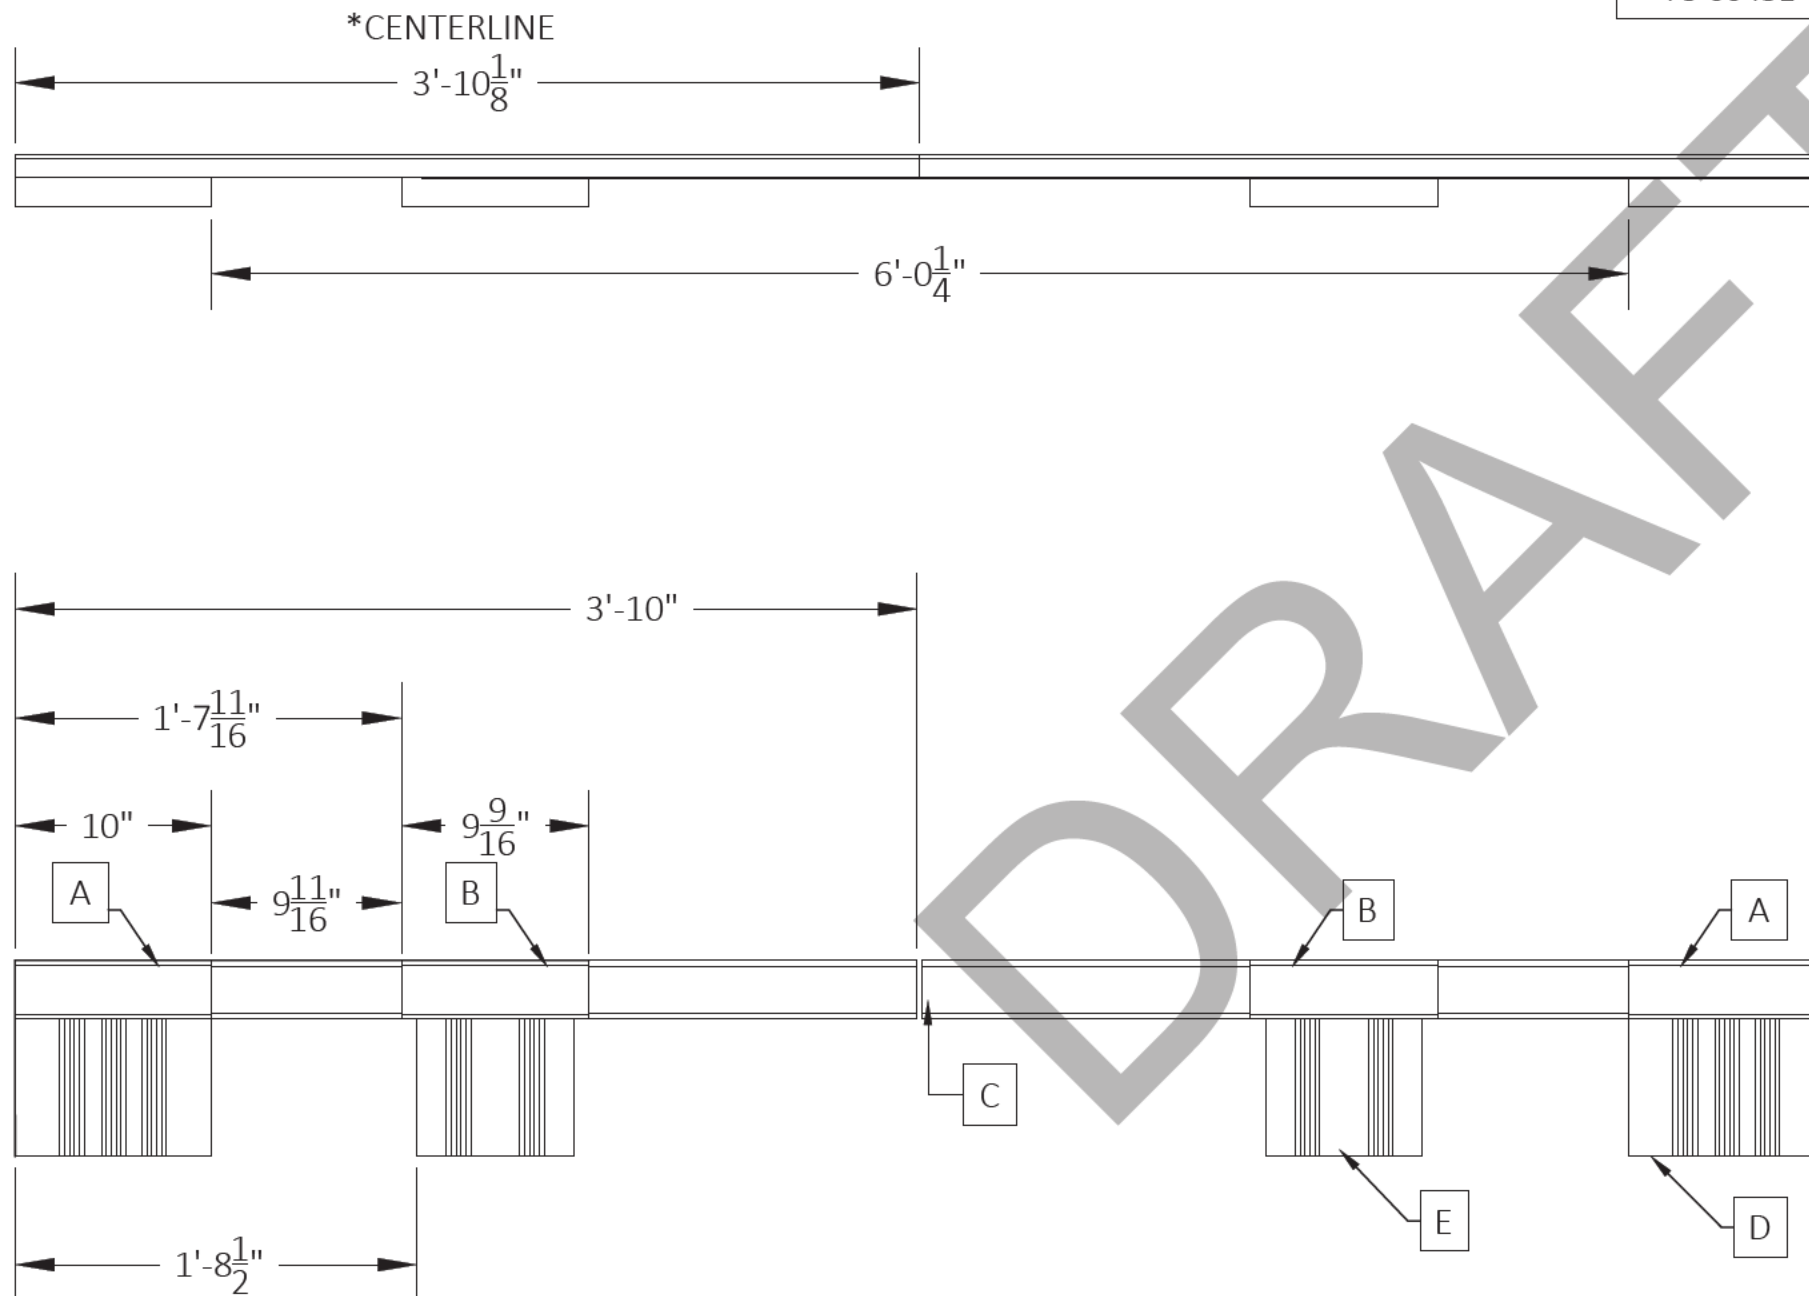


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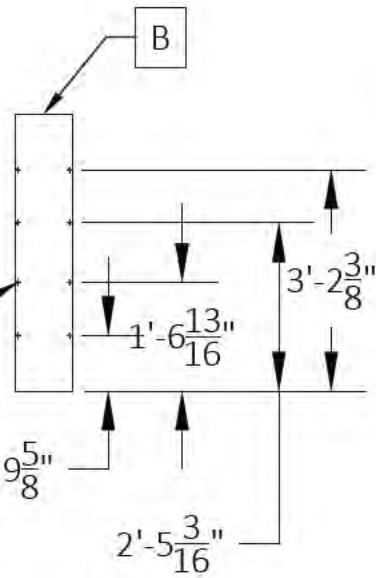
-SHEET DETAIL-		SHORES AT THE COMMON AREA.dwg				
FILE NAME/CUSTOMER ➡						
DRAWN: 6/1/2023		RA-1				
CHECKED:						
MANAG.APPR:						
ISSUED TO: MANUFACTURE						
DESIGN DRAFTER: R.BAKER		SIZE B	SCALE 1:10	DWG TYPE/NO.		REV 0
FABRICATOR:					SHEET 19 OF 42	

CUT/STOCK LIST							
DIE NUMBER	ITEM	QTY.	DESCRIPTION	DEGREE	FT.	IN.	TOTAL FT.
FS-084499	A	2	10" H.W.	45°-45°	24	0"	48.00
FS-084499	B	2	10" H.W.	45°-45°	4	0"	8.00
FS-04306	C	7	8" L.W.	0°-0°	3	7 1/2"	#####
FH-07805	D	10	CORNER SLEEVE	0°-0°		10"	8.33
FH-00487	E	20	1"X2" GUSSET	45°-45°	1	9 13/16"	#####
FH-01356	F	1	1/8" X 2" X 2" TUBE	0°-0°	23	7 1/2"	#####
FS-04774	G	20	2" X 2" ANGLE	0°-0°		2"	3.33

HOLE PLACEMENT 1/2" INCH
FROM CHANNEL EDGE ON TAB

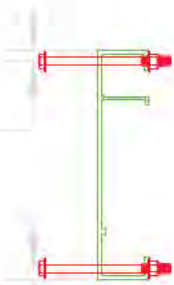

Ø¹³/₃₂"
(8) PL.



F424

(11)REQUIRED

Sheet Detail

FILE NAME/CUSTOMER → SHORES AT THE COMMON AREA.dwg

DRAWN: 6/1/2023

CHECKED:

MANAG.APPR:

ISSUED TO: MANUFACTURE

DESIGN DRAFTER: R.BAKER

FABRICATOR:

F424

SIZE B

SCALE 1:34

DWG TYPE/NO.

REV 0

SHEET 20 OF 42

D

D

C




C

B


B

A

A

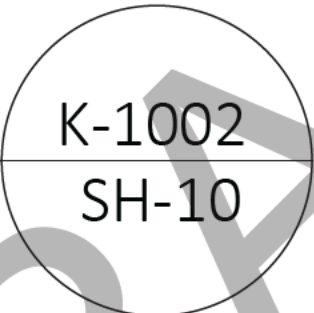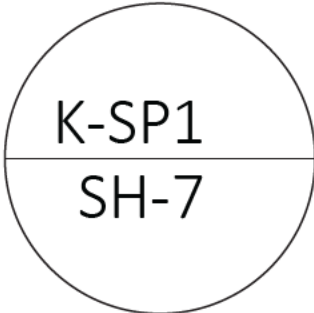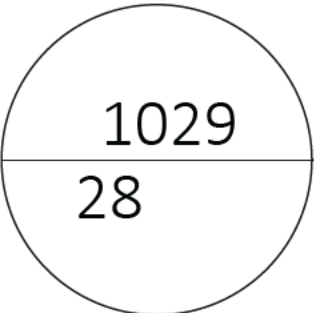

INSERT STUB-UP MATERIAL AS SHOWN
IN POST TO WHICH SPUD POLE
SLEEVES ATTACH. FASTEN USING
A DRILLET TO HOLD IN PLACE
DURING INSTALLATION.
SEE SH-3C FOR SLEEVE LOCATION

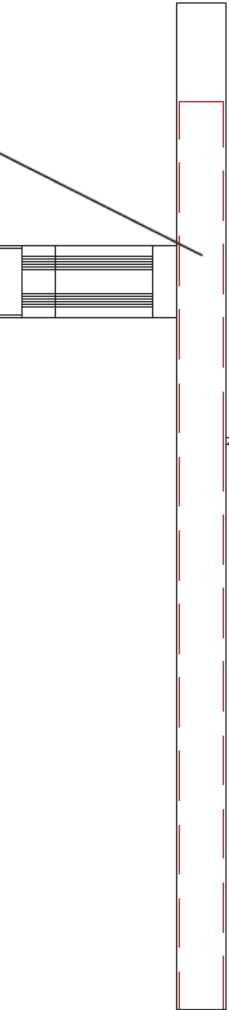

DRILLET LOCATION

FLUSH WITH THE
BOTTOM OF THE POST

K-SP1 ASSEMBLIES ARE TO BE BOLTED
TO THE FRAMES AND POST AT THE
SPECIFICALLY MARKED PLACES.

D:\P\trial\LOGO\OPERATION LOGO\BLM.PLS	--SHEET DETAIL			SHORES AT THE COMMON AREA.dwg 8' COLLAR SIDE VIEW
	FILE NAME/CUSTOMER ➔			
	DRAWN: 6/1/2023			
	CHECKED:			
	MANAG.APPR:			
	ISSUED TO: MANUFACTURE			
	DESIGN DRAFTER: R.BAKER			
	FABRICATOR:			
SIZE	SCALE	DWG TYPE/NO.		REV
B	1:36			0
			SHEET 21 OF 42	

D

D

C

C

B

B

A

A

1029
SH-9

K-SP1
24

K-1002
25

INSERT STUB-UP MATERIAL AS SHOWN
IN POST TO WHICH SPUD POLE
SLEEVES ATTACH. FASTEN USING
A DRILLET TO HOLD IN PLACE
DURING INSTALLATION.
SEE SH-3C FOR SLEEVE LOCATION

FLUSH WITH THE
BOTTOM OF THE POST

K-SP1 ASSEMBLIES ARE TO BE BOLTED
TO THE FRAMES AND POST AT THE
SPECIFICALLY MARKED PLACES.

D:\Virtual\AutoCAD\AutoCAD 2010\AutoCAD 2010.dwg	--SHEET DETAIL--			SHORES AT THE COMMON AREA.dwg			
	FILE NAME/CUSTOMER ➔						
	DRAWN: 6/1/2023			8' COLLAR FRONT VIEW			
	CHECKED:						
	MANAG.APPR:						
	ISSUED TO: MANUFACTURE						
	DESIGN DRAFTER: R.BAKER						SIZE B
	FABRICATOR:						SHEET 22 OF 42

D

D

C

C


B

B

A

A

K-SP1 ASSEMBLIES ARE TO BE BOLTED
TO THE FRAMES AND POST AT THE
SPECIFICALLY MARKED PLACES.

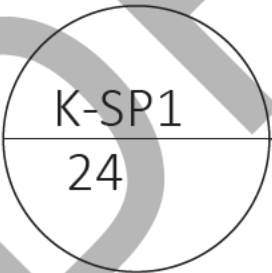

INSERT STUB-UP MATERIAL AS SHOWN
IN POST TO WHICH SPUD POLE
SLEEVES ATTACH. FASTEN USING
A DRILLET TO HOLD IN PLACE
DURING INSTALLATION.
SEE SH-3C FOR SLEEVE LOCATION

D:\Programs\Autodesk\AutoCAD 2013\AutoCAD 2013.dwg


-SHEET DETAIL-	
FILE NAME/CUSTOMER ➔	
DRAWN: 6/1/2023	
CHECKED:	
MANAG.APPR:	
ISSUED TO: MANUFACTURE	
DESIGN DRAFTER: R.BAKER	
FABRICATOR:	

SHORES AT THE COMMON AREA.dwg


8' COLLAR TOP VIEW

SIZE	SCALE	DWG TYPE/NO.	REV
B	1:42		0
			SHEET 23 OF 42


SIDE VIEW

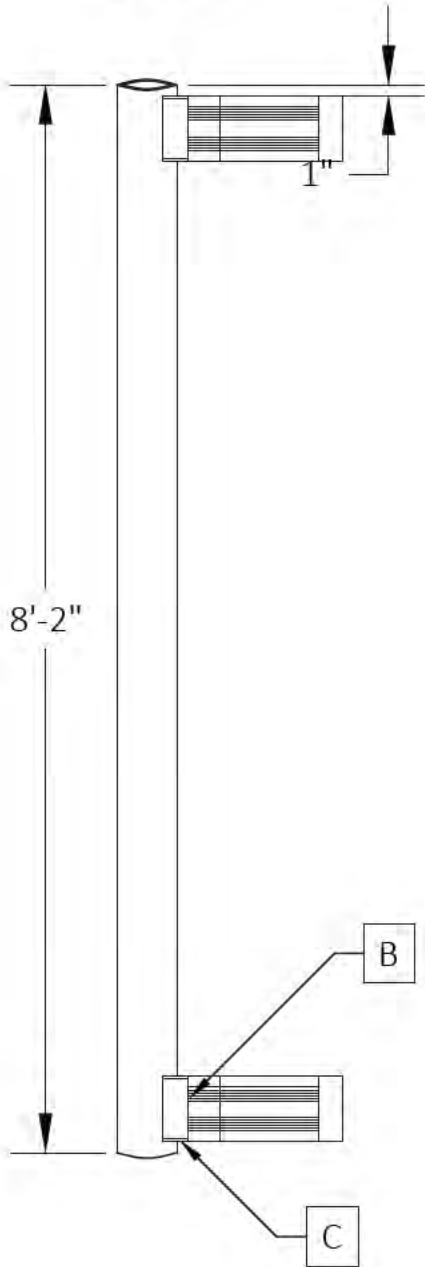

7/16" Ø HOLE
8 PL. MATCH
DRILL AT
LOCATION

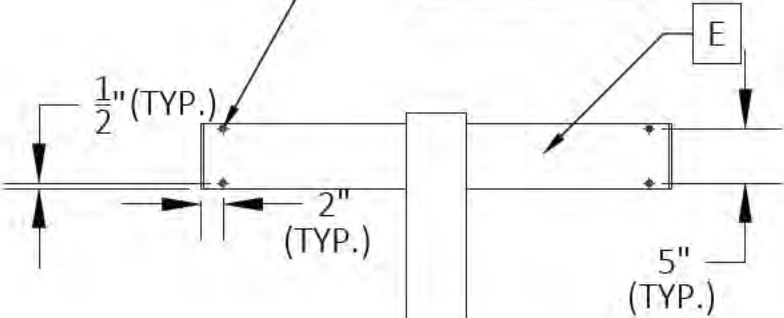

FRONT VIEW

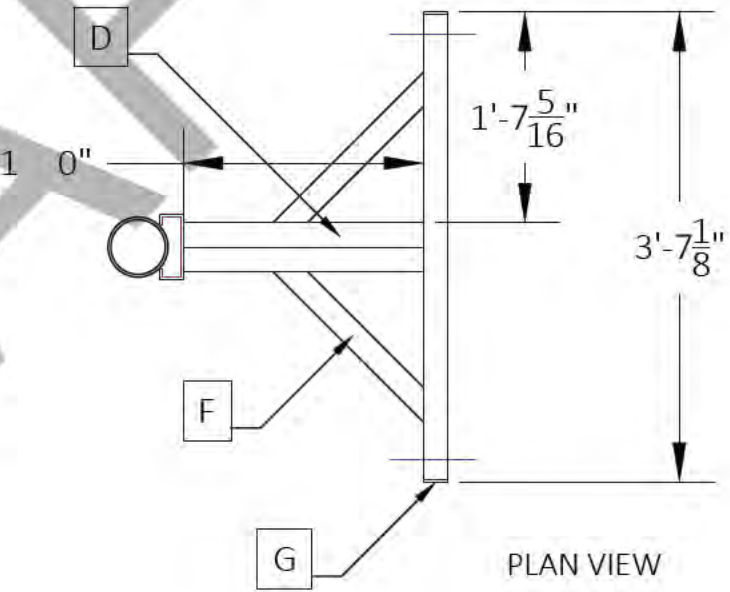

PLAN VIEW

CUT/STOCK LIST

DIE NUMBER	ITEM	QTY.	DESCRIPTION	DEGREE	FT.	IN.	TOTAL FT.
FH-04827	A	1	5" SCH. 40 ALUM PIPE	0°-0°	8	2"	8.17
FS-04739	B	2	6" H.W.	0°-0°		5 1/2"	####
FS-00490	C	4	1/4" X 2 1/4" PRE-CUT PLATE	0°-0°		6"	2.00
FS-04739	D	4	6" H.W.	0°-0°	1	10"	7.33
FS-04739	E	2	6" H.W.	0°-0°	3	6 5/8"	####
FS-04739	F	4	6" H.W.	45°-45°	1	7 1/2"	####
FS-00678	G	4	1/4" X 6" FLAT PLATE	0°-0°		2 1/4"	####



K-SP1 ASSEMBLIES ARE TO BE BOLTED TO THE FRAMES AND POST AT THE SPECIFICALLY MARKED PLACES.

K-SP1

(21)REQUIRED

--SHEET DETAIL--		SHORES AT THE COMMON AREA.dwg		
FILE NAME/CUSTOMER		K-SP1		
DRAWN: 6/1/2023				
CHECKED:				
MANAG.APPR:				
ISSUED TO: MANUFACTURE				
DESIGN DRAFTER: R.BAKER		SIZE B	SCALE 1:18	DWG TYPE/NO.
FABRICATOR:				REV 0
		SHEET 24 OF 42		

CUT/STOCK LIST							
DIE NUMBER	ITEM	QTY.	DESCRIPTION	DEGREE	FT.	IN.	TOTAL FT.
FH-07908	A	44	4" STUP UP	0°-0°	7	4	322.6667

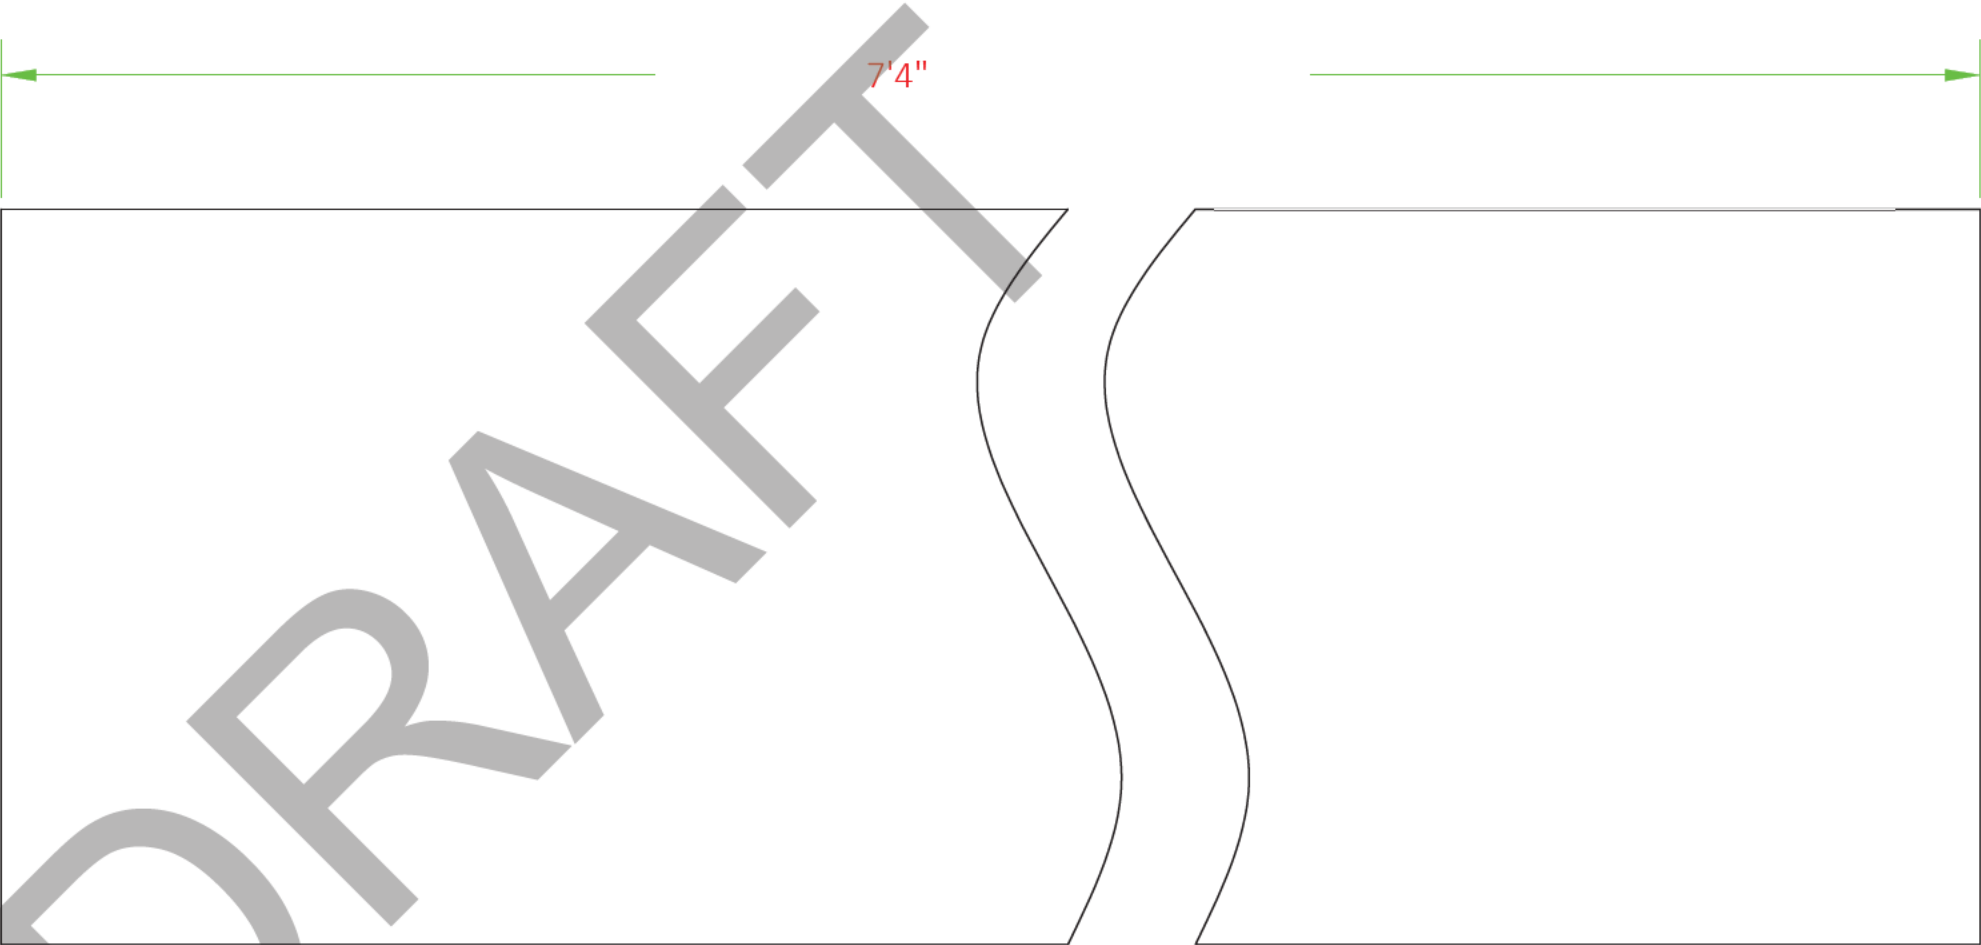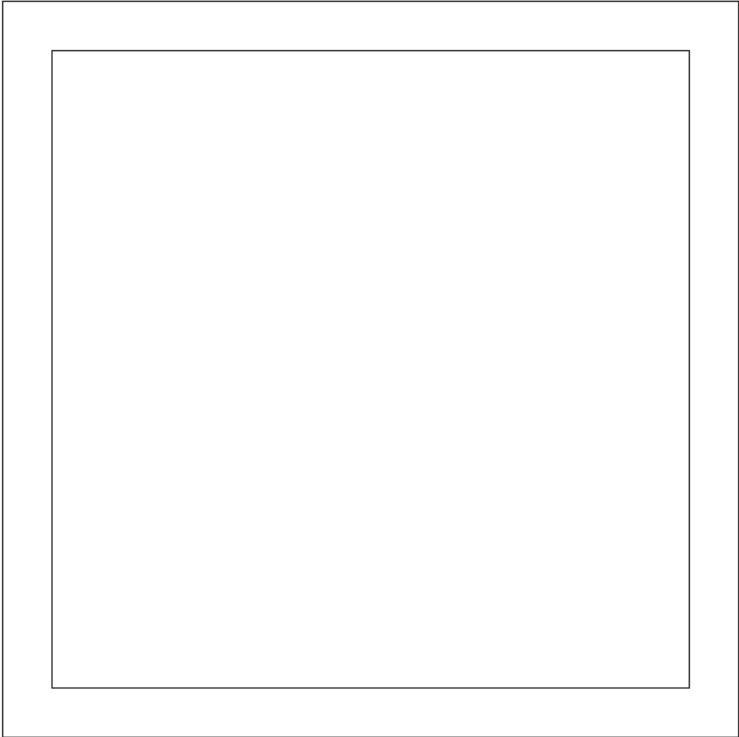

K-1002

D:\Programs\LOGO\EXPLORATION\LOGO\K1002\BIM.dwg

-SHEET DETAIL-		SHORES AT THE COMMON AREA.dwg				
FILE NAME/CUSTOMER ➔						
DRAWN: 6/1/2023		K-1002				
CHECKED:						
MANAG.APPR:						
ISSUED TO: MANUFACTURE						
DESIGN DRAFTER: R.BAKER		SIZE B	SCALE 1:1	DWG TYPE/NO.		REV 0
FABRICATOR:						SHEET 25 OF 42

D

D

C


C

B

B





A

A

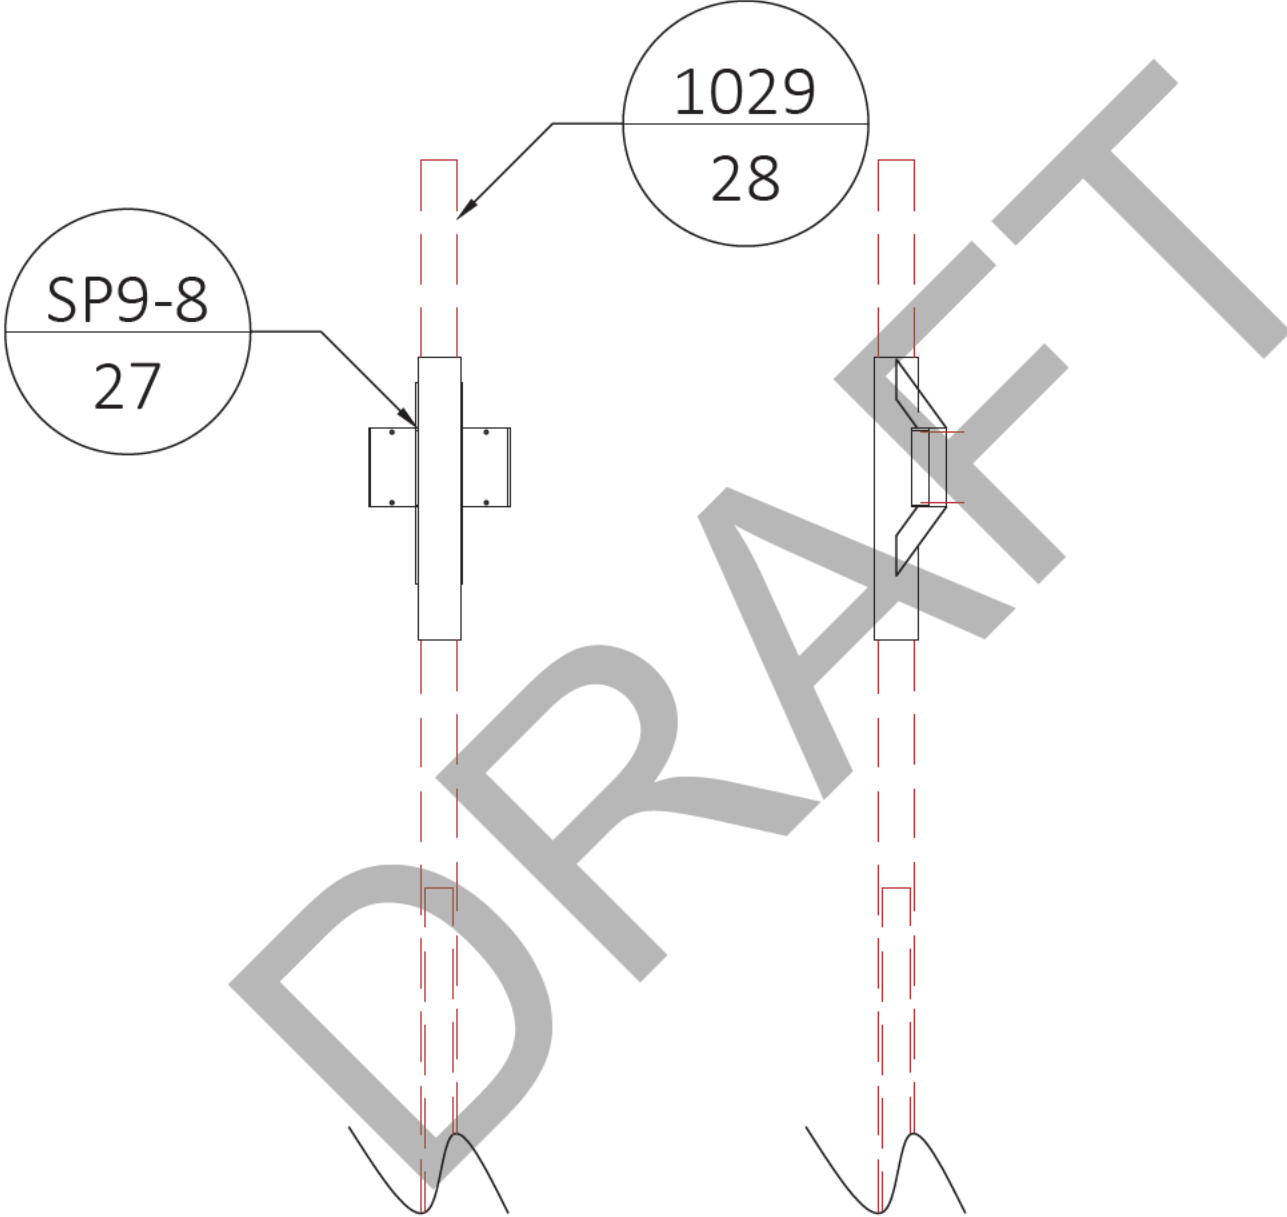

D:\Programs\LOGO\LOCATION\LOGO\BMP.JPG	-SHEET DETAIL-		SHORES AT THE COMMON AREA.dwg				
	FILE NAME/CUSTOMER ➔						
	DRAWN: 6/1/2023		3' SPUD POLE COLLAR TOP AND SIDE VIEW				
	CHECKED:						
	MANAG.APPR:						
	ISSUED TO: MANUFACTURE						
	DESIGN DRAFTER: R.BAKER		SIZE B	SCALE 1:25	DWG TYPE/NO.		REV 0
	FABRICATOR:					SHEET 26 OF 42	

CUT/STOCK LIST							
DIE NUMBER	ITEM	QTY.	DESCRIPTION	DEGREE	FT.	IN.	TOTAL FT.
FH-04827	A	2	5" SCH. 40 ALUM PIPE	0°-0°	3	0	6.00
FS08499	B	2	10" H.W.	0°-0°	1	5 1/2"	####
FS-04739	C	2	6" H.W.	0°-0°		9 1/2"	####
FS-01990	D	4	1/4" X 8" FLATPLATE	0°-0°		2 1/4"	####
FS-00678	E	4	1/4" X6" FLATPLATE	0°-0°		2 1/4"	####
FS-04457	F	8	3/8" X 2 1/4" FLATPLATE	L54°-L36°		10 7/8"	####

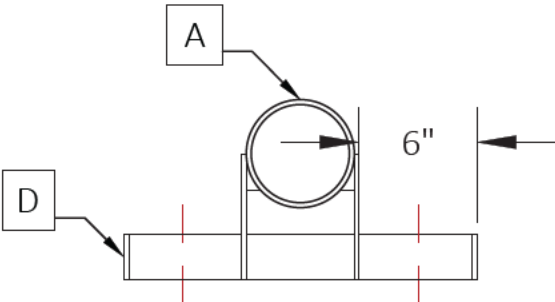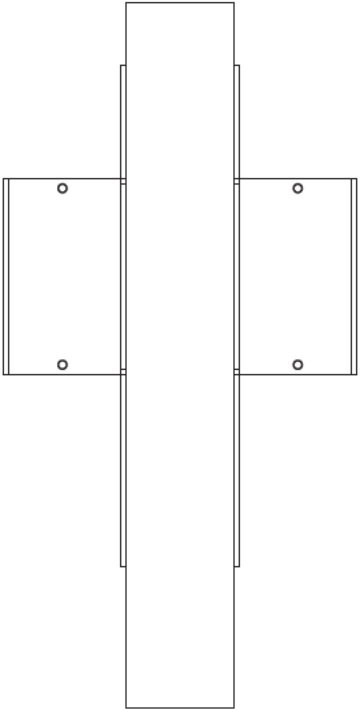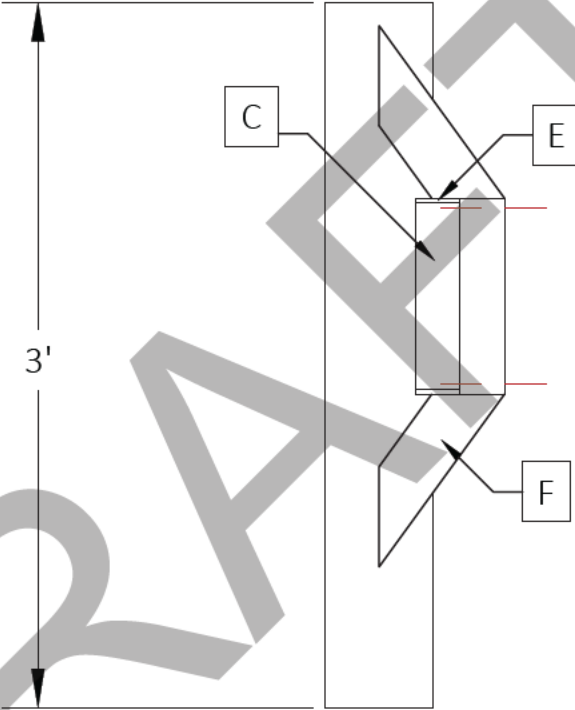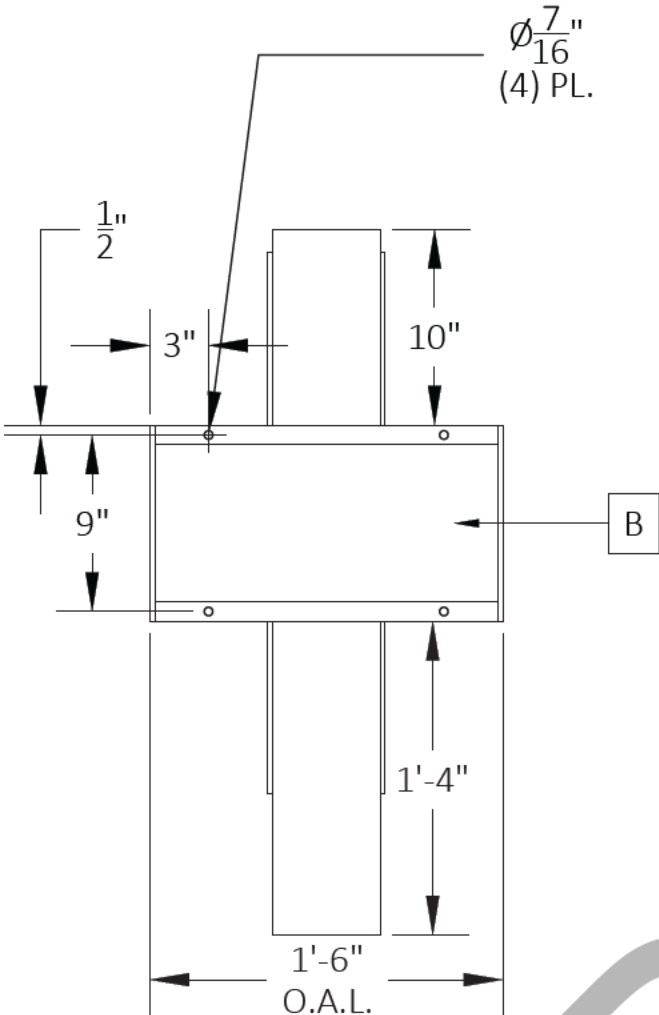

SP9-8

(2)REQUIRED

-SHEET DETAIL-					
SHEET INFORMATION	FILE NAME/CUSTOMER	SHORES AT THE COMMON AREA.dwg			
	DRAWN: 6/1/2023	SP9-8			
	CHECKED:				
	MANAG.APPR:				
	ISSUED TO: MANUFACTURE				
	DESIGN DRAFTER: R.BAKER	SIZE B	SCALE 1:10	DWG TYPE/NO.	REV 0
FABRICATOR:				SHEET 27 OF 42	


CUT/STOCK LIST							
DIE NUMBER	ITEM	QTY.	DESCRIPTION	DEGREE	FT.	IN.	TOTAL FT.
	A	23	4" SCH 40 X 21' SPUD POLE		21	0	483.0000



D:\Programs\LOGO\LOCATION\LOGO\LOGO.BMP

-SHEET DETAIL-			SHORES AT THE COMMON AREA.dwg				
FILE NAME/CUSTOMER ➔							
DRAWN: 6/1/2023			1029				
CHECKED:							
MANAG.APPR:							
ISSUED TO: MANUFACTURE							
DESIGN DRAFTER: R.BAKER			SIZE B	SCALE 1:18	DWG TYPE/NO.		REV 0
FABRICATOR:							SHEET 28 OF 42

CUT/STOCK LIST							
DIE NUMBER	ITEM	QTY.	DESCRIPTION	DEGREE	FT.	IN.	TOTAL FT.
FH-01356	A	1	1/8" X 2" X 2" TUBE	0°-0°	20	8 7/8	20.739583
FH-01356	B	4	1/8" X 2" X 2" TUBE	0°-0°	4	8 3/4	18.916667
FH-01356	C	5	1/8" X 2" X 2" TUBE	0°-0°	4	3	21.250000
FH-01 56	D	2	1/8" X 2" X 2" TUBE	45°-45°	1	11	3.833333
F 356	E	2	1/8" X 2" X 2" TUBE	0°-45°		6	1.000000

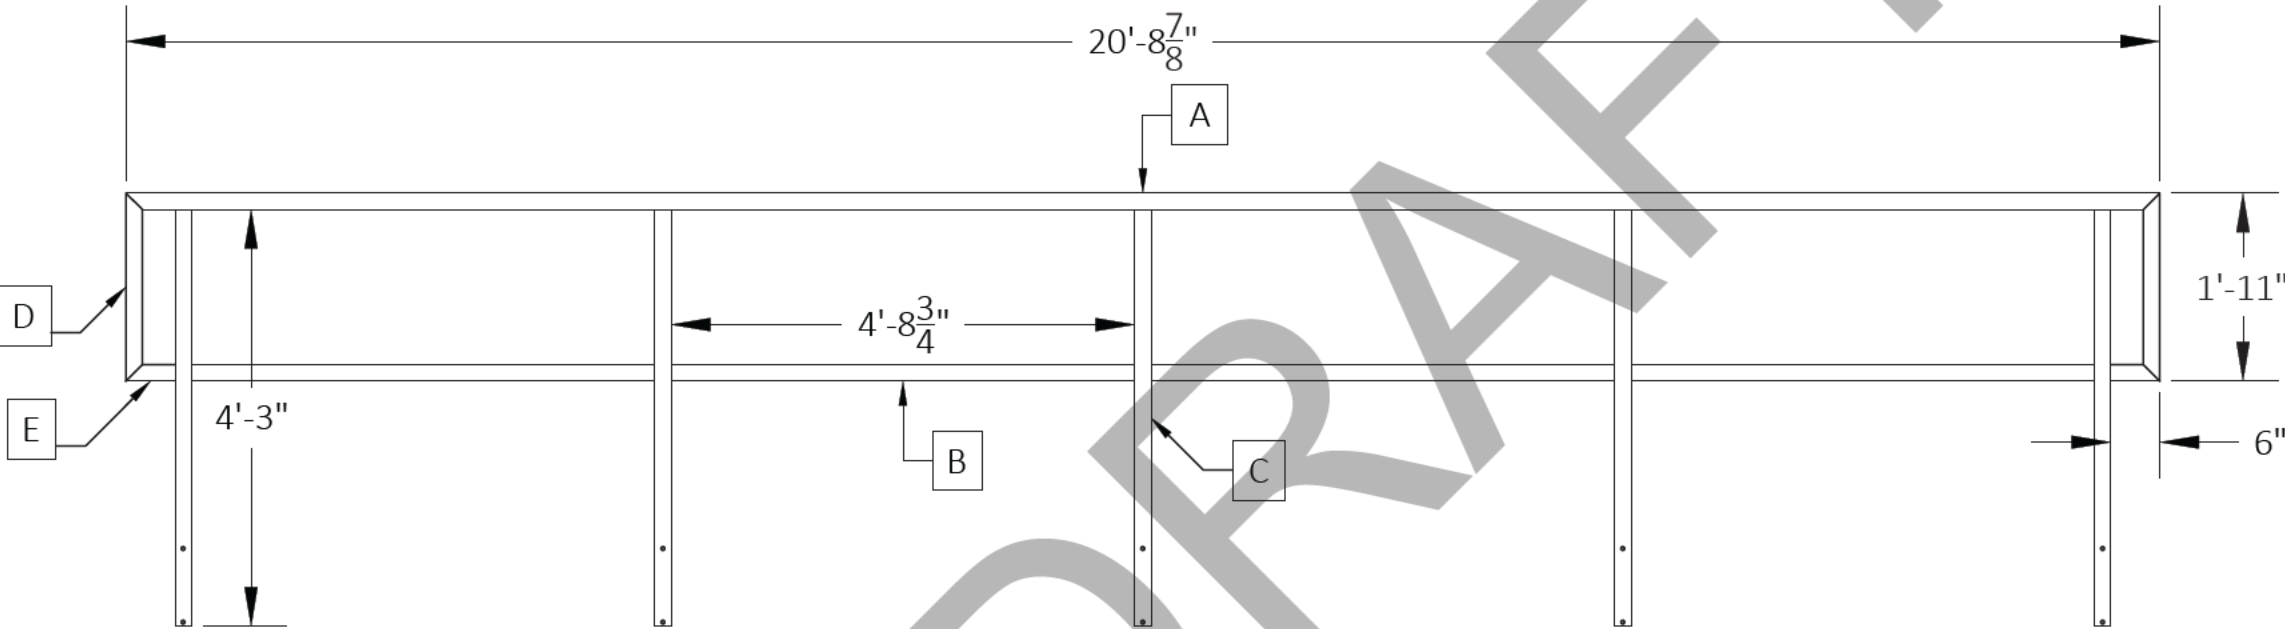

(8)REQUIRED

D:\Programs\LOGOFLATION\LOGOFLAT1\LOGO.BMP

-SHEET DETAIL-	
FILE NAME/CUSTOMER ➔	
DRAWN: 6/1/2023	
CHECKED:	
MANAG.APPR:	
ISSUED TO: MANUFACTURE	
DESIGN DRAFTER: R.BAKER	
FABRICATOR:	

SHORES AT THE COMMON AREA.dwg	
SP-1	
SIZE	SCALE
B	1:24
DWG TYPE/NO.	
REV	
0	
SHEET 29 OF 42	

D

D

C


C

B


B

A

A

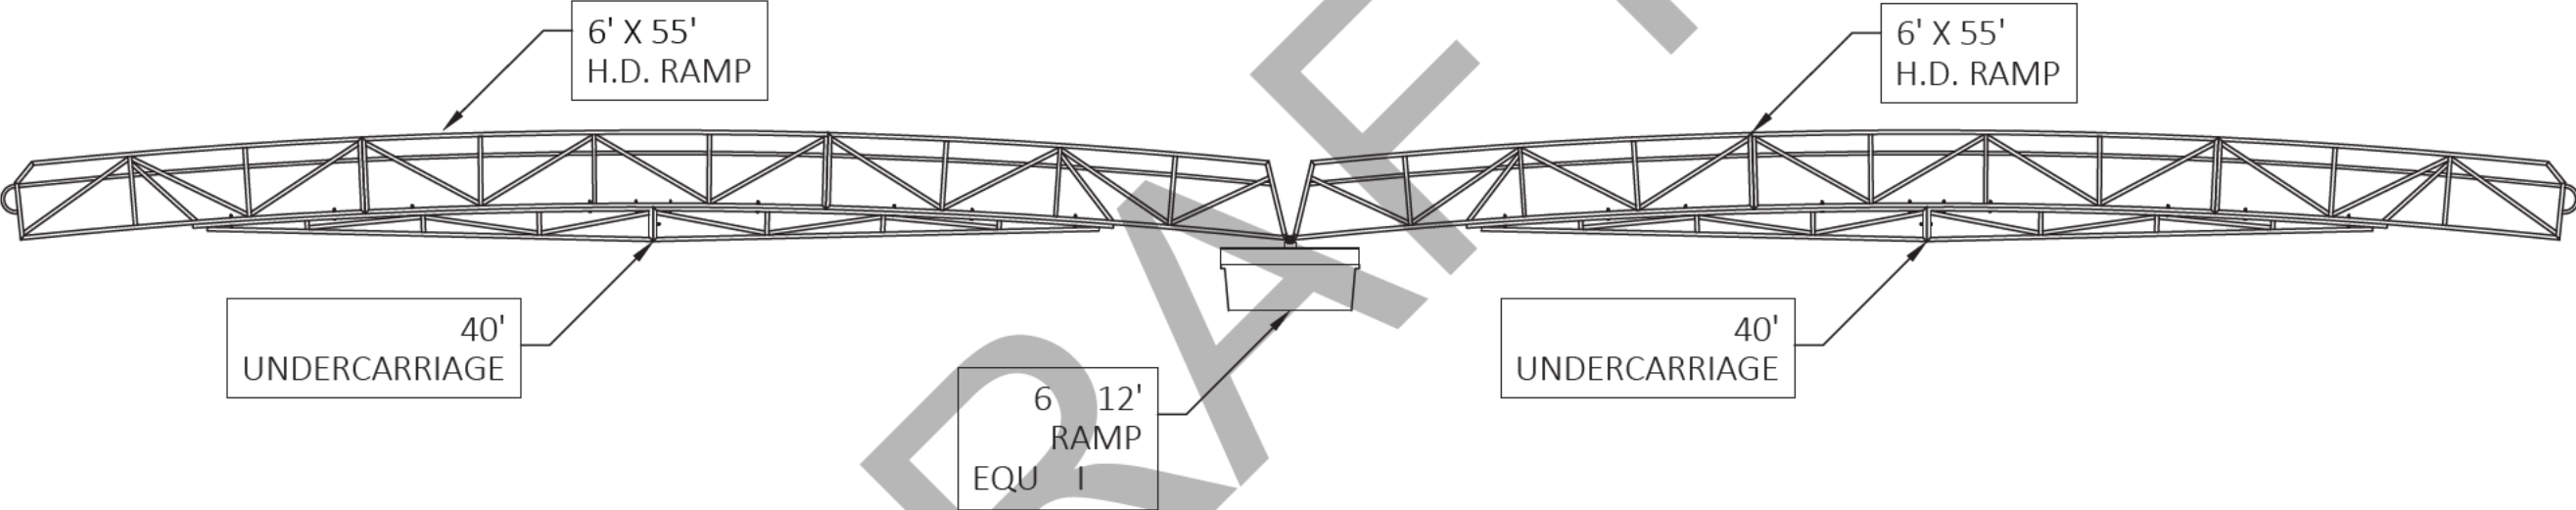


SHEET INFORMATION LOGO BLM.PLS	-SHEET DETAIL-		SHORES AT THE COMMON AREA.dwg			
	FILE NAME/CUSTOMER ➔					
	DRAWN: 6/1/2023		(2) 6' X 55' RAMPS W/ EQUALIZER SIDE VIEW			
	CHECKED:					
	MANAG.APPR:					
	ISSUED TO: MANUFACTURE					
	DESIGN DRAFTER: R.BAKER					
	FABRICATOR:		SIZE B	SCALE 1:100	DWG TYPE/NO.	
				SHEET 31 OF 42		

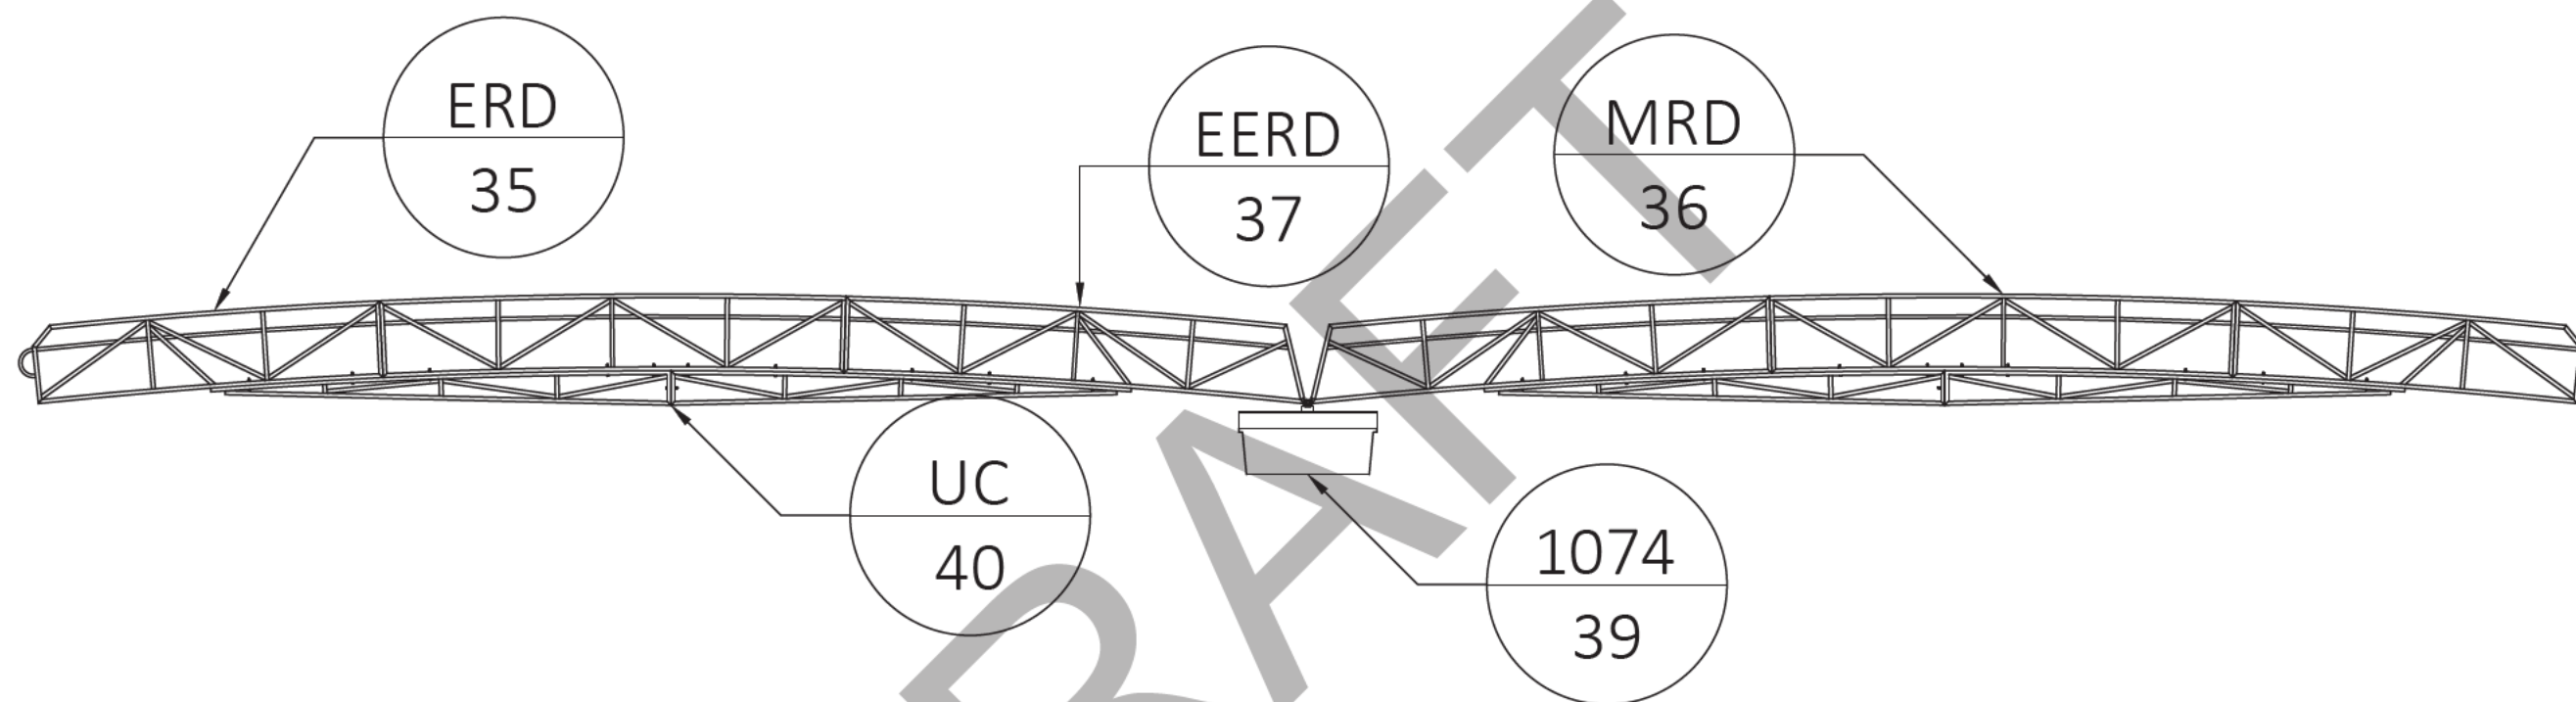

D:\Personal\LOG OF EDUCATION\LOGS\FSL LOGS\DWG

-SHEET DETAIL-		SHORES AT THE COMMON AREA.dwg				
FILE NAME/CUSTOMER ➔						
DRAWN: 6/1/2023		(2) 6' X 55' RAMPS W/ EQUALIZER SIDE VIEW				
CHECKED:						
MANAG.APPR:						
ISSUED TO: MANUFACTURE						
DESIGN DRAFTER: R.BAKER						
FABRICATOR:		SIZE B	SCALE 1:100	DWG TYPE/NO.		REV 0
				SHEET 32 OF 42		

DECKING

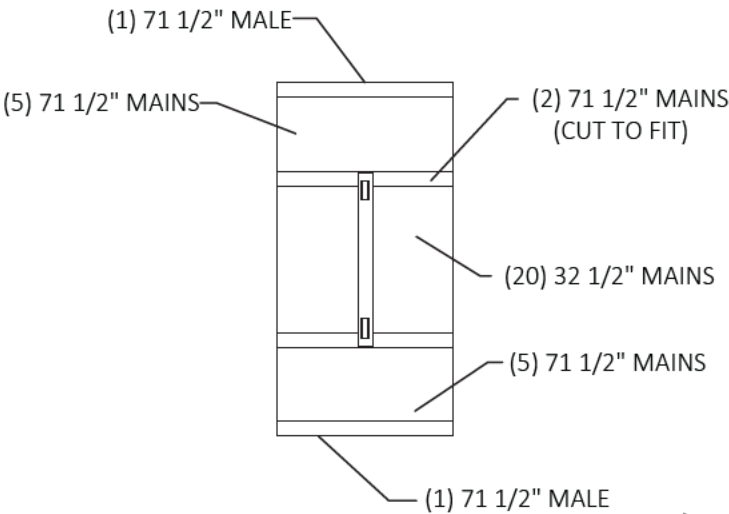

(1) 67" MALE

(109) 67" MAINS

(109) 67" MAINS

(1) 67" MALE

DECKING COLOR:

D:\Programs\LOGO ELEVATION LOGO\PLT\LOGO BW.dwg

-SHEET DETAIL-					
FILE NAME/CUSTOMER		→ SHORES AT THE COMMON AREA.dwg			
DRAWN: 6/1/2023		(2) 6' X 55' RAMPS W/ EQUALIZER DECKING DIAGRAM			
CHECKED:					
MANAG.APPR:					
ISSUED TO: MANUFACTURE					
DESIGN DRAFTER: R.BAKER		SIZE B	SCALE 1:80	DWG TYPE/NO.	REV 0
FABRICATOR:					SHEET 33 OF 42


DECKING CUT LIST		
QTY.	DESCRIPTION	COLOR
218	67" MARINE MAINS	
2	67" MARINE MALES	
12	71-1/2" MARINE MAINS	
20	32 1/2" MARINE MAINS	
2	71 1/2" MARINE MALES	

DRAFT

D:\Programs\Autocad\Autocad\Autocad.dwg	--SHEET DETAIL--		SHORES AT THE COMMON AREA.dwg				
	FILE NAME/CUSTOMER ➔						
	DRAWN: 6/1/2023		(2) 6' X 55' RAMPS W/ EQUALIZER DECKING CUT SHEET				
	CHECKED:						
	MANAG.APPR:						
	ISSUED TO: MANUFACTURE						
	DESIGN DRAFTER: R.BAKER		SIZE	SCALE	DWG TYPE/NO.		REV
	FABRICATOR:		B	1:80			0
				SHEET 34 OF 42			

D

D

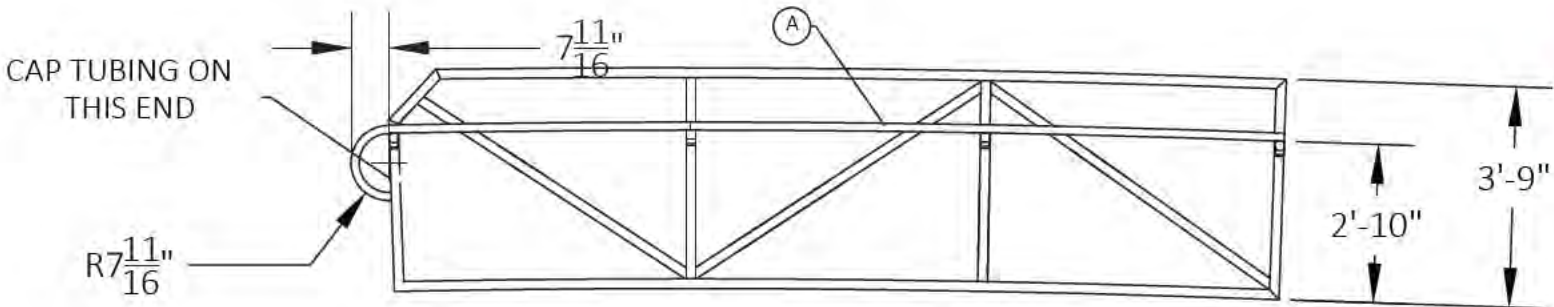


STOCK LIST			
DET. NO.	QTY.	DESCRIPTION	
A	2	1 1/4" SCH. 40 ALUM. PIPE 18' LG. **ROLLED ON ONE END** CUT TO FIT**	
B	8	GRAB BAR BRACKETS 1 3/4" LG.	
C	2	1" X 2" TUBING 15'-2" LG.	

END RAMP SECTION

C

C

SEE ATTACHMENT SHEET FOR THIS END OF THE RAMP

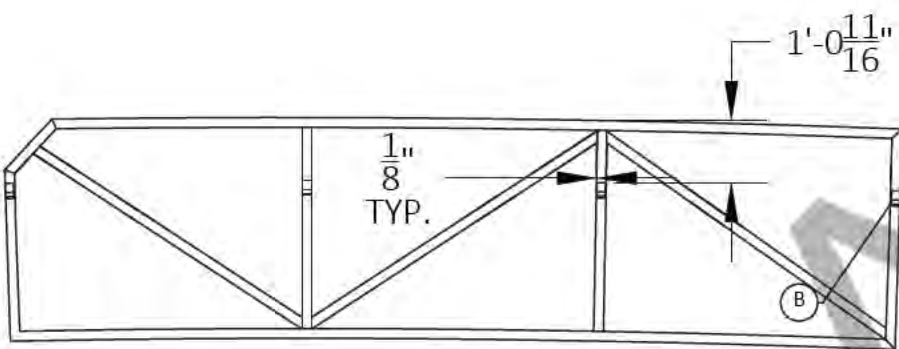


1'-0 11/16"
FROM THE TOP OF
THE RAMP TO THE
TOP OF THE GRAB RAIL
BRACKET

BOLT-UPS
ON THE THIS
END OF THE RAMP

B


B

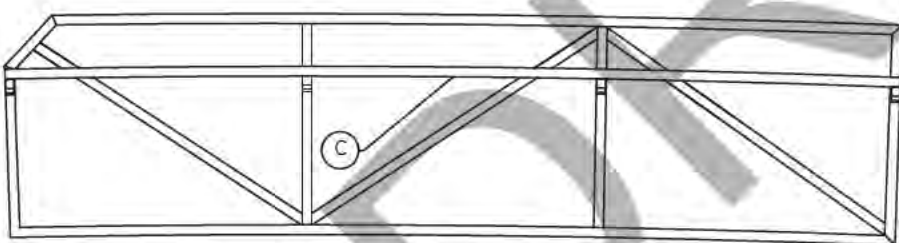


END RAMP SECTION

A

A

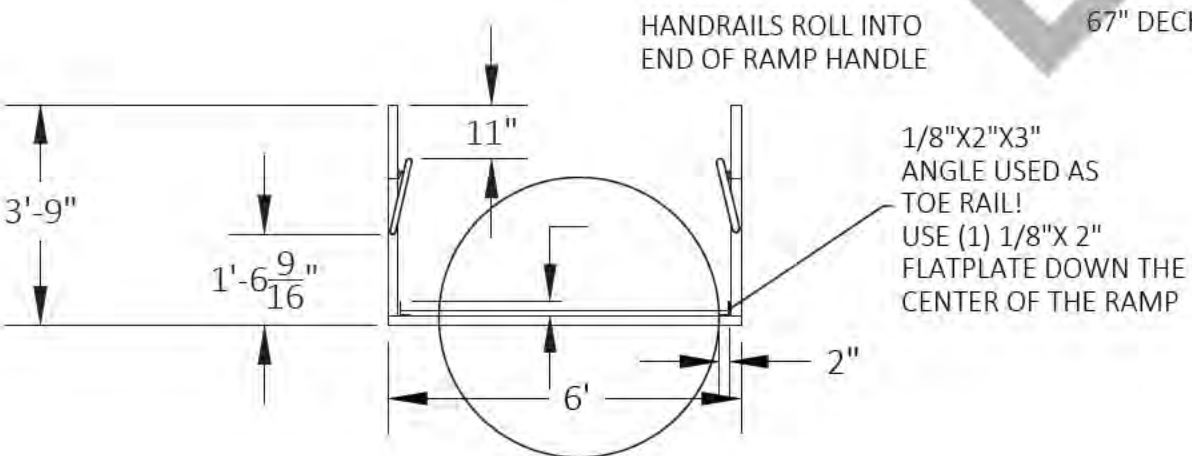


12 11/16"
FROM THE TOP OF
THE RAMP TO THE
TOP OF THE GRAB RAIL
BRACKET

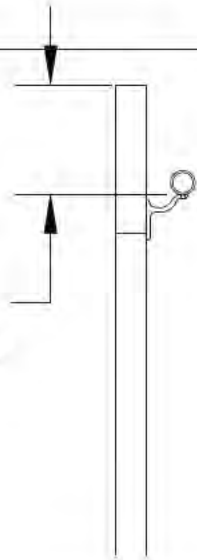

6 X 15' END
RAMP SECTION

-SHEET DETAIL-			
FILE NAME/CUSTOMER		SHORES AT THE COMMON AREA.dwg	
DRAWN: 6/1/2023		(2) 6' X 55' RAMPS W/ EQUALIZER ERD	
CHECKED:			
MANAG.APPR:			
ISSUED TO: MANUFACTURE			
DESIGN DRAFTER: R.BAKER			
FABRICATOR:			
SIZE	SCALE	DWG TYPE/NO.	REV
B	1:40		0
SHEET 35 OF 42			


INSIDE VIEW

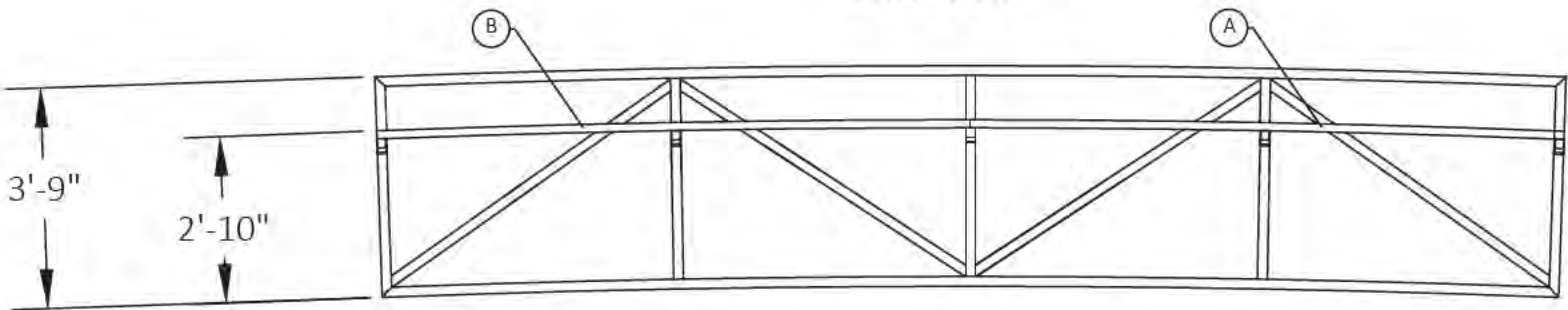

STOCK LIST		
DET. NO.	QTY.	DESCRIPTION
A	2	1 1/4" SCH. 40 ALUM. PIPE 20' LG. CUT TO FIT**
B	2	1 1/4" SCH. 40 ALUM PIPE 10'-1 5/16" LG.
C	10	GRAB BAR BRACKETS 1 3/4" LG.


MIDDLE RAMP SECTION

BOLT-UPS
ON THE THIS
END OF THE RAMP

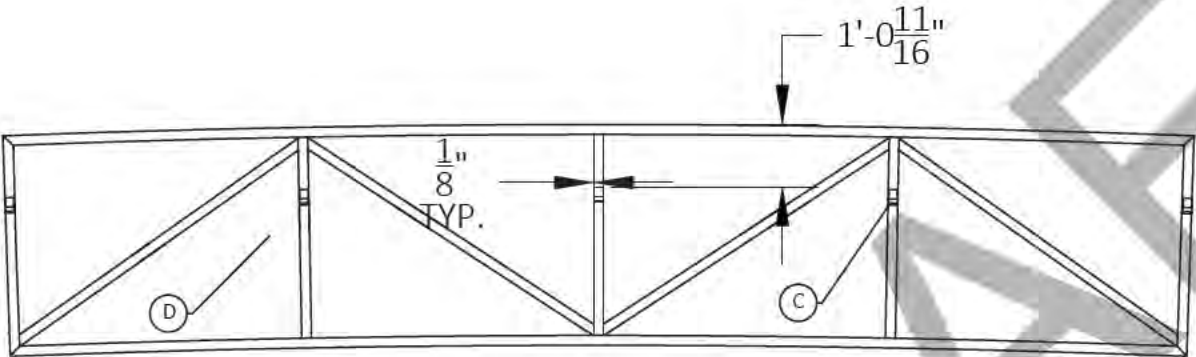


1'-0 ¹¹/₁₆"
FROM THE TOP OF
THE RAMP TO THE
TOP OF THE GRAB RAIL
BRACKET

MIDDLE RAMP SECTION

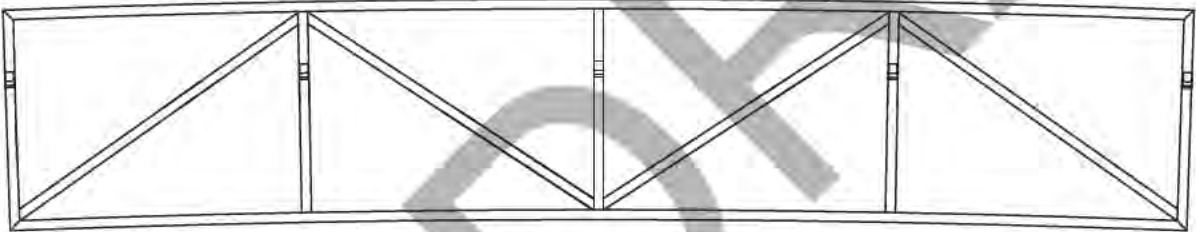

6' X 20' MIDDLE
RAMP SECTION

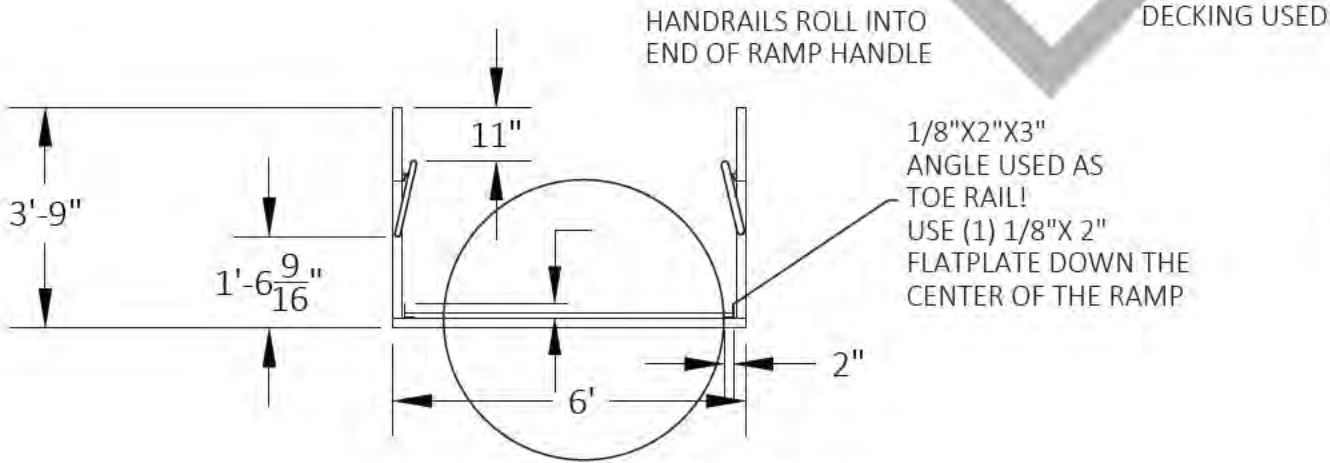

HANDRAILS ROLL INTO
END OF RAMP HANDLE

DECKING USED


1/8"X2"X3"
ANGLE USED AS
TOE RAIL!
USE (1) 1/8"X 2"
FLATPLATE DOWN THE
CENTER OF THE RAMP

12 ¹¹/₁₆"
FROM THE TOP OF
THE RAMP TO THE
TOP OF THE GRAB RAIL
BRACKET

-SHEET DETAIL-			
FILE NAME/CUSTOMER		SHORES AT THE COMMON AREA.dwg	
DRAWN: 6/1/2023		(2) 6' X 55' RAMPS W/ EQUALIZER	
CHECKED:		MRD	
MANAG. APPR:			
ISSUED TO: MANUFACTURE			
DESIGN DRAFTER: R. BAKER		SIZE B	SCALE 1:24
FABRICATOR:		DWG TYPE/NO.	REV 0
		SHEET 36 OF 42	


A	2	1 1/4" SCH. 40 ALUM. PIPE 13' LG. **ROLLED ON ONE END** CUT TO FIT**
B	2	1 1/4" SCH. 40 ALUM PIPE 10'-1 5/16" LG.
C	10	GRAB BAR BRACKETS 1 3/4" LG.

INSIDE VIEW

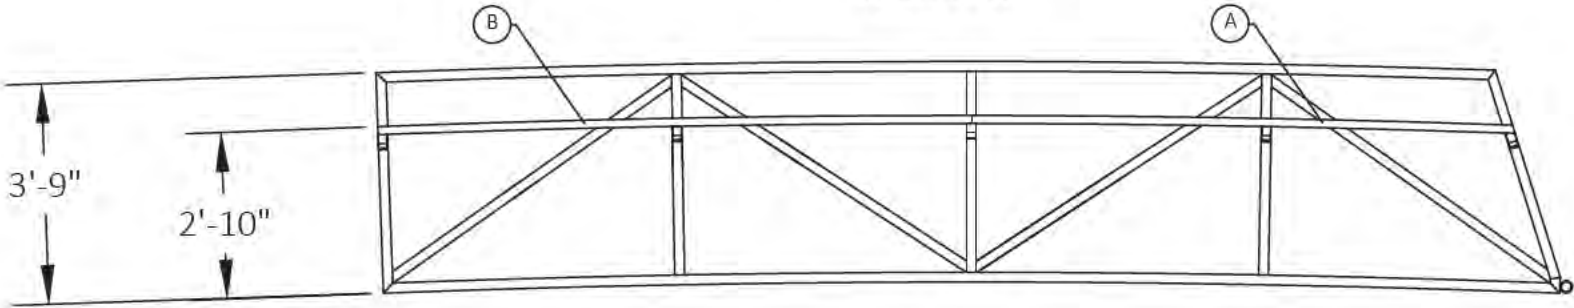


EQUALIZER END RAMP SECTION

BOLT-UPS
ON THE THIS
END OF THE RAMP

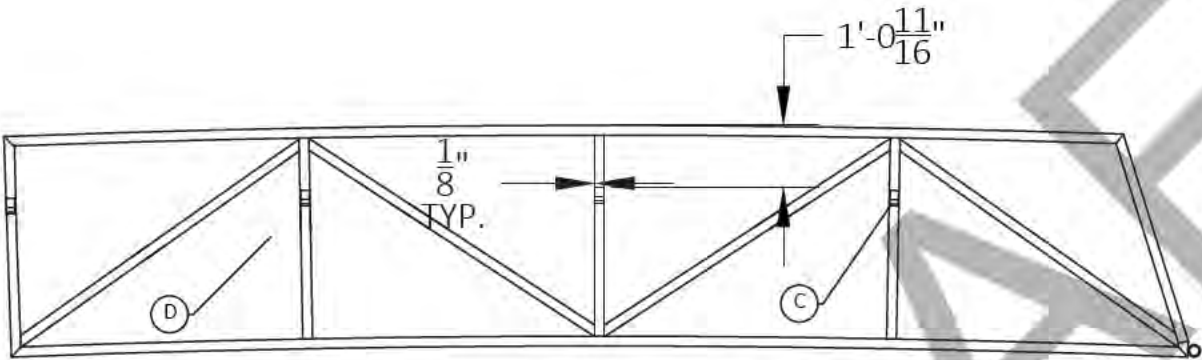


1'-0 11/16"
FROM THE TOP OF
THE RAMP TO THE
TOP OF THE GRAB RAIL
BRACKET

72" TRACK AND PIPE
ON THE THIS
END OF THE RAMP

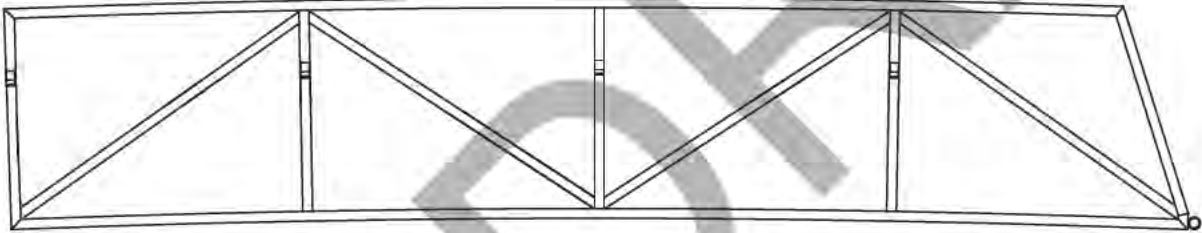

EQUALIZER END RAMP SECTION

6' X 20' EQUALIZER END
RAMP SECTION

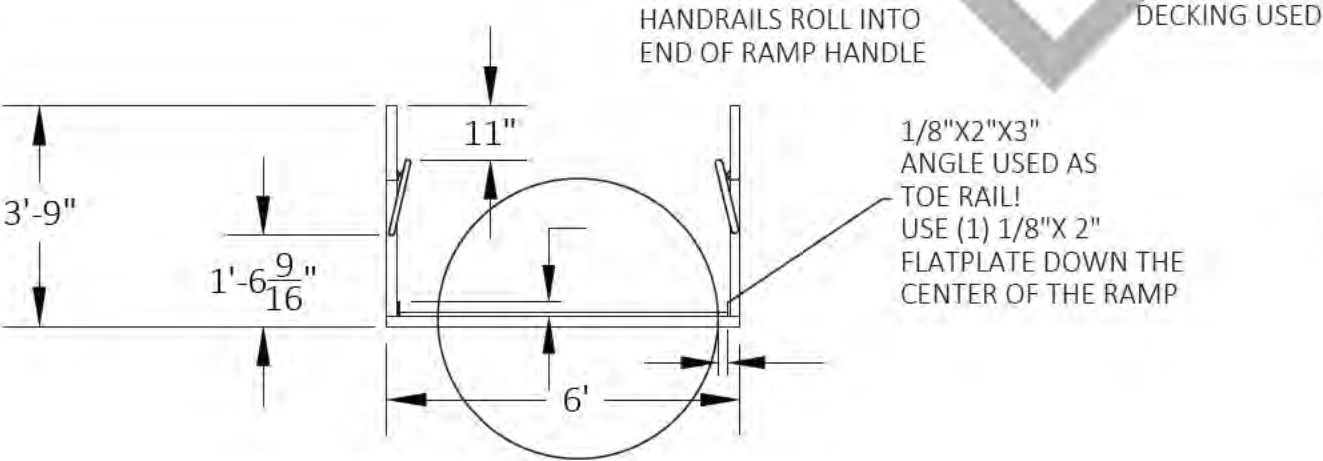


HANDRAILS ROLL INTO
END OF RAMP HANDLE

DECKING USED


1/8"X2"X3"
ANGLE USED AS
TOE RAIL!
USE (1) 1/8"X 2"
FLATPLATE DOWN THE
CENTER OF THE RAMP

12 11/16"
FROM THE TOP OF
THE RAMP TO THE
TOP OF THE GRAB RAIL
BRACKET

-SHEET DETAIL-			
FILE NAME/CUSTOMER		SHORES AT THE COMMON AREA.dwg	
DRAWN: 6/1/2023		(2) 6' X 55' RAMPS W/ EQUALIZER EERD	
CHECKED:			
MANAG. APPR:			
ISSUED TO: MANUFACTURE			
DESIGN DRAFTER: R. BAKER		SIZE B	SCALE 1:40
FABRICATOR:		DWG TYPE/NO.:	REV 0
		SHEET 37 OF 42	

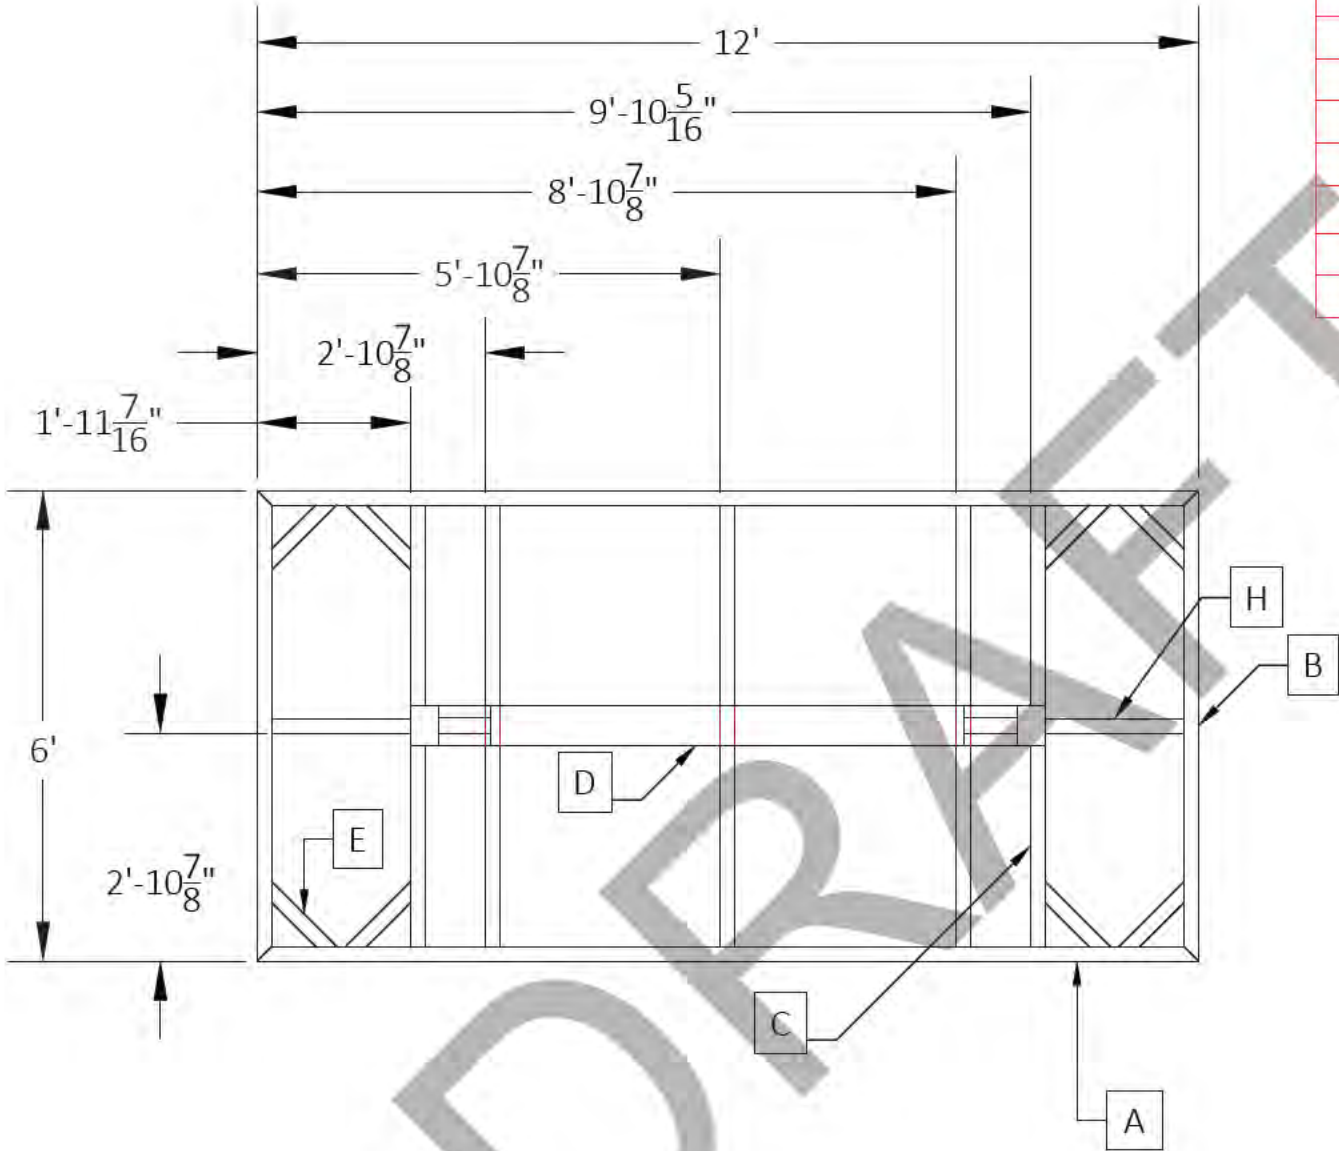


CUT LIST							
DIE NUMBER	ITEM	QTY.	DESCRIPTION	DEGREE	FT	IN	TOTAL FT
FS-00431	A	2	8" H.W.	45°-45°	12	0"	24.00
FS-00431	B	2	8" H.W.	45°-45°	6	0"	12.00
FS-00431	C	5	8" H.W.	45°-45°	5	7 1/2"	#####
	D	1	6" H.W.	0°-0°	8	5/8"	8.05
FS-00431	E	8	8" H.W.	45°-45°	1	2"	9.33
FH-07812	F	2	RAMP PIPE	0°-0°		8"	1.33
FS-00678	G	2	¾" X 6" FLATPLATE	0°-0°		2 1/4"	####
FS-00431	H	2	8" H.W.	0°-0°	2	9 3/16"	####
FS-07813	I	1	RAMP TRACK	0°-0°	8	0	8.00

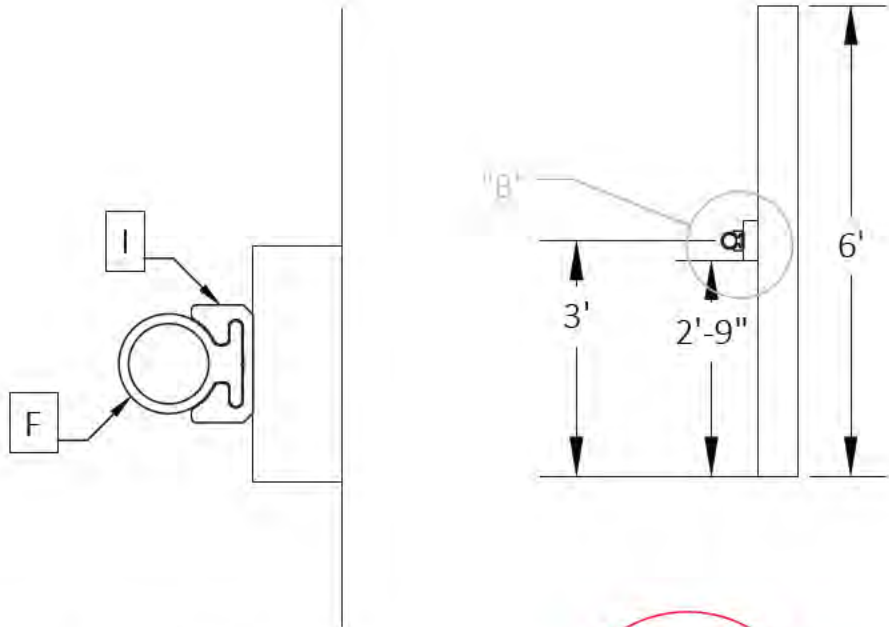

VIEW IN CIRCLE "B"

1074

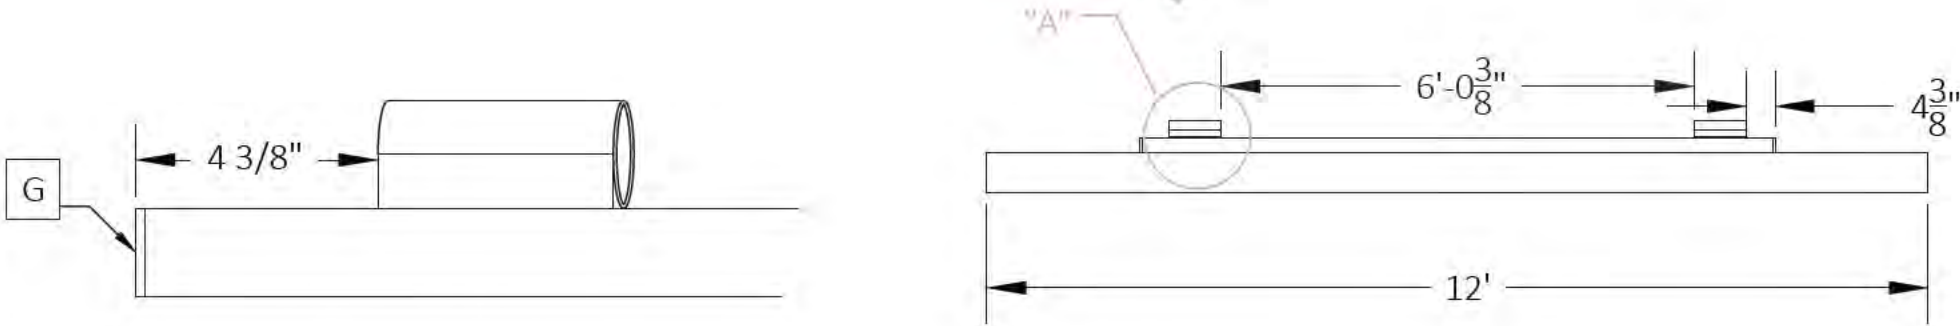

VIEW IN CIRCLE "A"

SHEET INFORMATION	-SHEET DETAIL-			SHORES AT THE COMMON AREA.dwg			
	FILE NAME/CUSTOMER ➔						
	DRAWN: 6/1/2023			(2) 6' X 55' RAMPS W/ EQUALIZER 1074			
	CHECKED:						
	MANAG.APPR:						
	ISSUED TO: MANUFACTURE						
	DESIGN DRAFTER: R.BAKER			SIZE B	SCALE 1:30	DWG TYPE/NO.	REV 0
	FABRICATOR:			SHEET 39 OF 42			

D

D

C



C

B

B

A

A

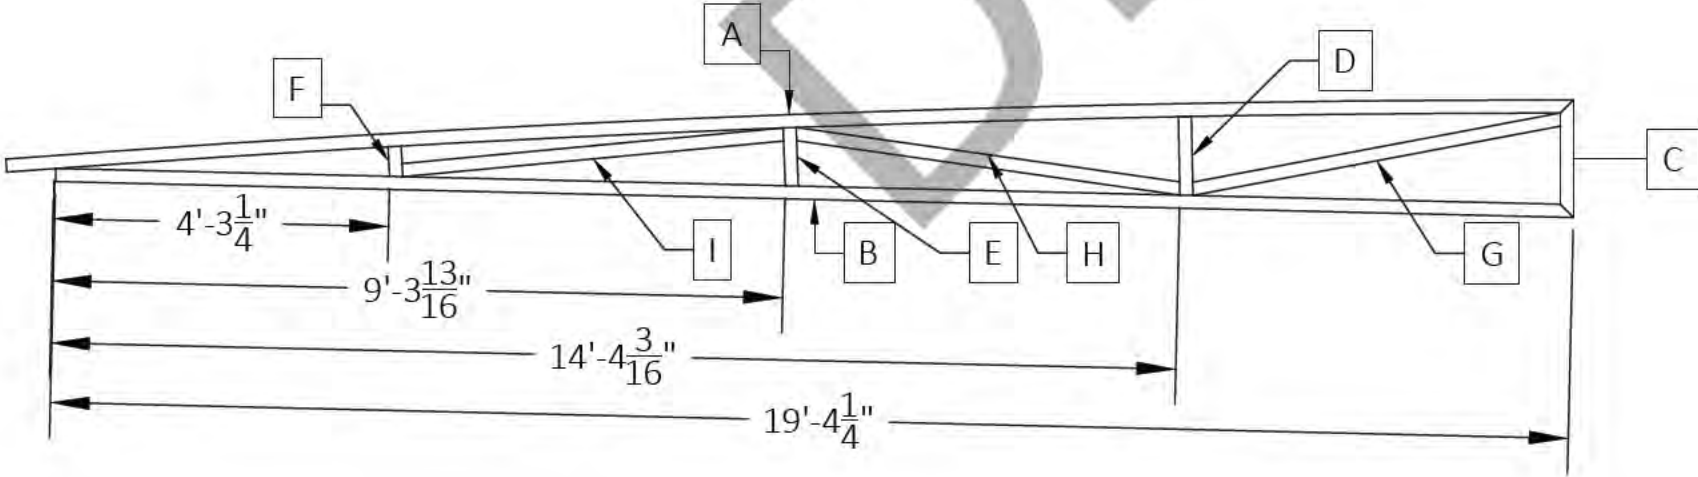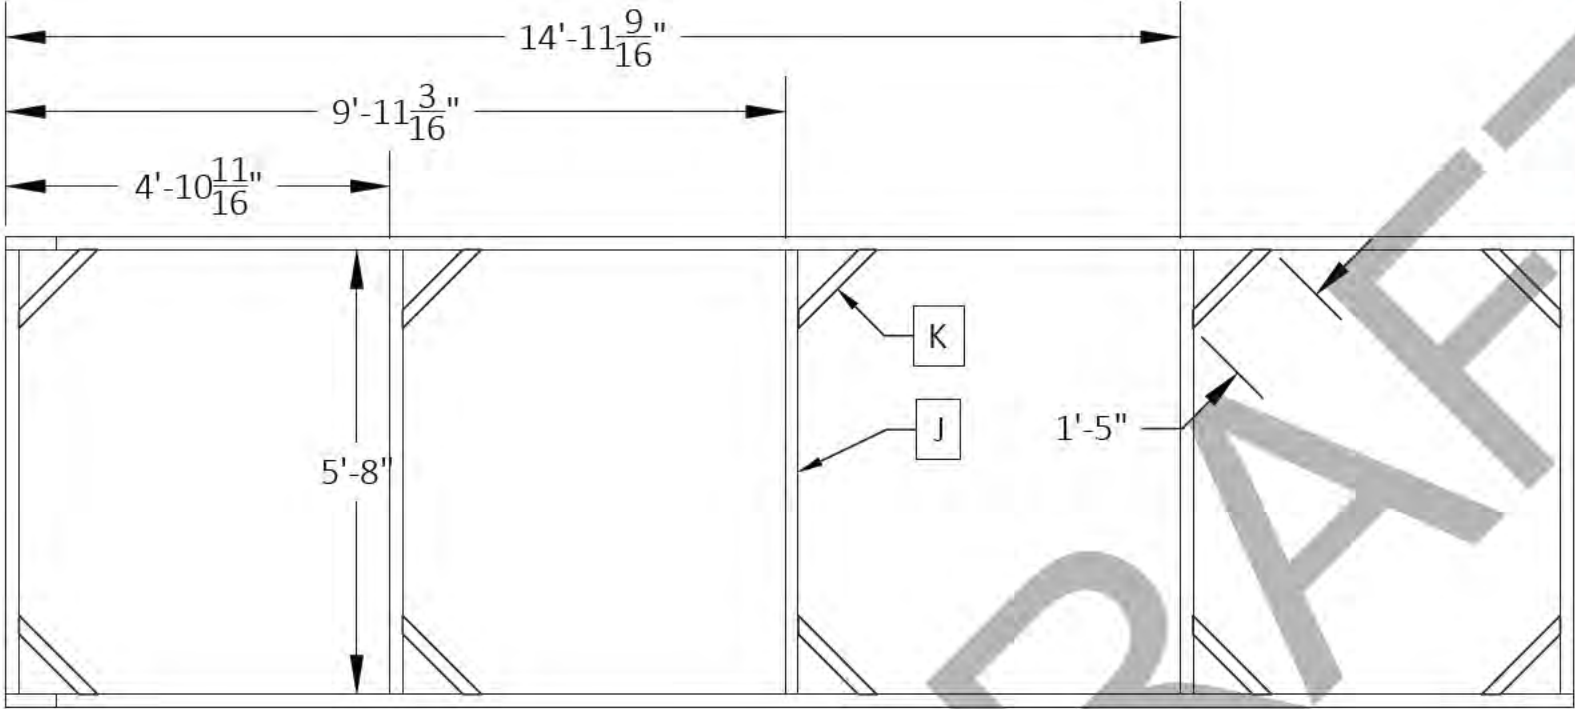

(4)REQUIRED

CUT/STOCK LIST							
DIE NUMBER	ITEM	QTY.	DESCRIPTION	DEGREE	FT.	IN.	TOTAL FT.
FH-01356	A	2	1/8" X 2" X 2" TUBE	45°-0°	20	0"	40.00
FH-01356	B	2	1/8" X 2" X 2" TUBE	45°-45°	19	4 1/4"	#####
FH-01356	C	2	1/8" X 2" X 2" TUBE	45°-45°	1	6"	3.00
FH-01356	D	2	1/8" X 2" X 2" TUBE	0°-2°	1	1/16"	2.01
FH-01356	E	2	1/8" X 2" X 2" TUBE	0°-2°		8 15/16"	####
FH-01356	F	2	1/8" X 2" X 2" TUBE	0°-2°		4 11/16	0.78
FH-01356	G	2	1/8" X 2" X 2" TUBE	10°-11°	4	8 7/8	9.48
FH-01356	H	2	1/8" X 2" X 2" TUBE	9°-10°	4	11 1/4	9.88
FH-01356	I	2	1/8" X 2" X 2" TUBE	2°-3°	4	10 1/2	9.75
FH-01356	J	5	1/8" X 2" X 2" TUBE	0°-0°	5	8	28.33
FH-01356	K	10	1/8" X 2" X 2" TUBE	0°-2°	1	5	14.17

SHEET INFORMATION LOG	-SHEET DETAIL-			SHORES AT THE COMMON AREA.dwg				
	FILE NAME/CUSTOMER ➔							
	DRAWN: 6/1/2023			(2) 6' X 55' RAMPS W/ EQUALIZER UC				
	CHECKED:							
	MANAG.APPR:							
	ISSUED TO: MANUFACTURE							
	DESIGN DRAFTER: R.BAKER			SIZE	SCALE	DWG TYPE/NO.		REV
	FABRICATOR:			B	1:30			0
					SHEET 40 OF 42			

➔ ACCESSORIES ➔			
QTY.	DESCRIPTION	PC	COLOR
54	HORIZONTAL BUMPER		
24	CORNER BUMPER		
105	SUPER CUSHION		
2	DIAGONAL CABLES (RAMP)		
132	POST TRIM (2pc. - # of post)		
1	ROLLER GUIDE ASSEMBLY		
55	FLOAT PLUGS		
42	CLEATS		
51	20' STAIR NOSING (sti k)		
2	RAMP WEIGHT LIMIT TAG		
24	4" PVC CAPS		
24	SPUD POLE **SI ENCERS *		
24	4" GALVANIZED SPUD POLES		
2	DECKING TOUCH-UP		

SHEET INFORMATION LOGO BMP	-SHEET DETAIL-		SHORES AT THE COMMON AREA.dwg				
	FILE NAME/CUSTOMER ➔						
	DRAWN: 6/1/2023		ACCESSORY SHEET				
	CHECKED:						
	MANAG.APPR:						
	ISSUED TO: MANUFACTURE						
	DESIGN DRAFTER: R.BAKER		SIZE B	SCALE 1:30	DWG TYPE/NO.		REV 0
	FABRICATOR:						SHEET 41 OF 42

D:\Papers\LOGO VIGRATION LOGO\FSI LOGO REV.dwg

-SHEET DETAIL-						
FILE NAME/CUSTOMER ➡		SHORES AT THE COMMON AREA.dwg				
DRAWN: 6/1/2023		LOAD LIST				
CHECKED:						
MANAG.APPR:						
ISSUED TO: MANUFACTURE						
DESIGN DRAFTER: R.BAKER		SIZE B	SCALE 1:30	DWG TYPE/NO.		REV 0
FABRICATOR:						SHEET 42 OF 42

D

D

C


C

B

B

A

A

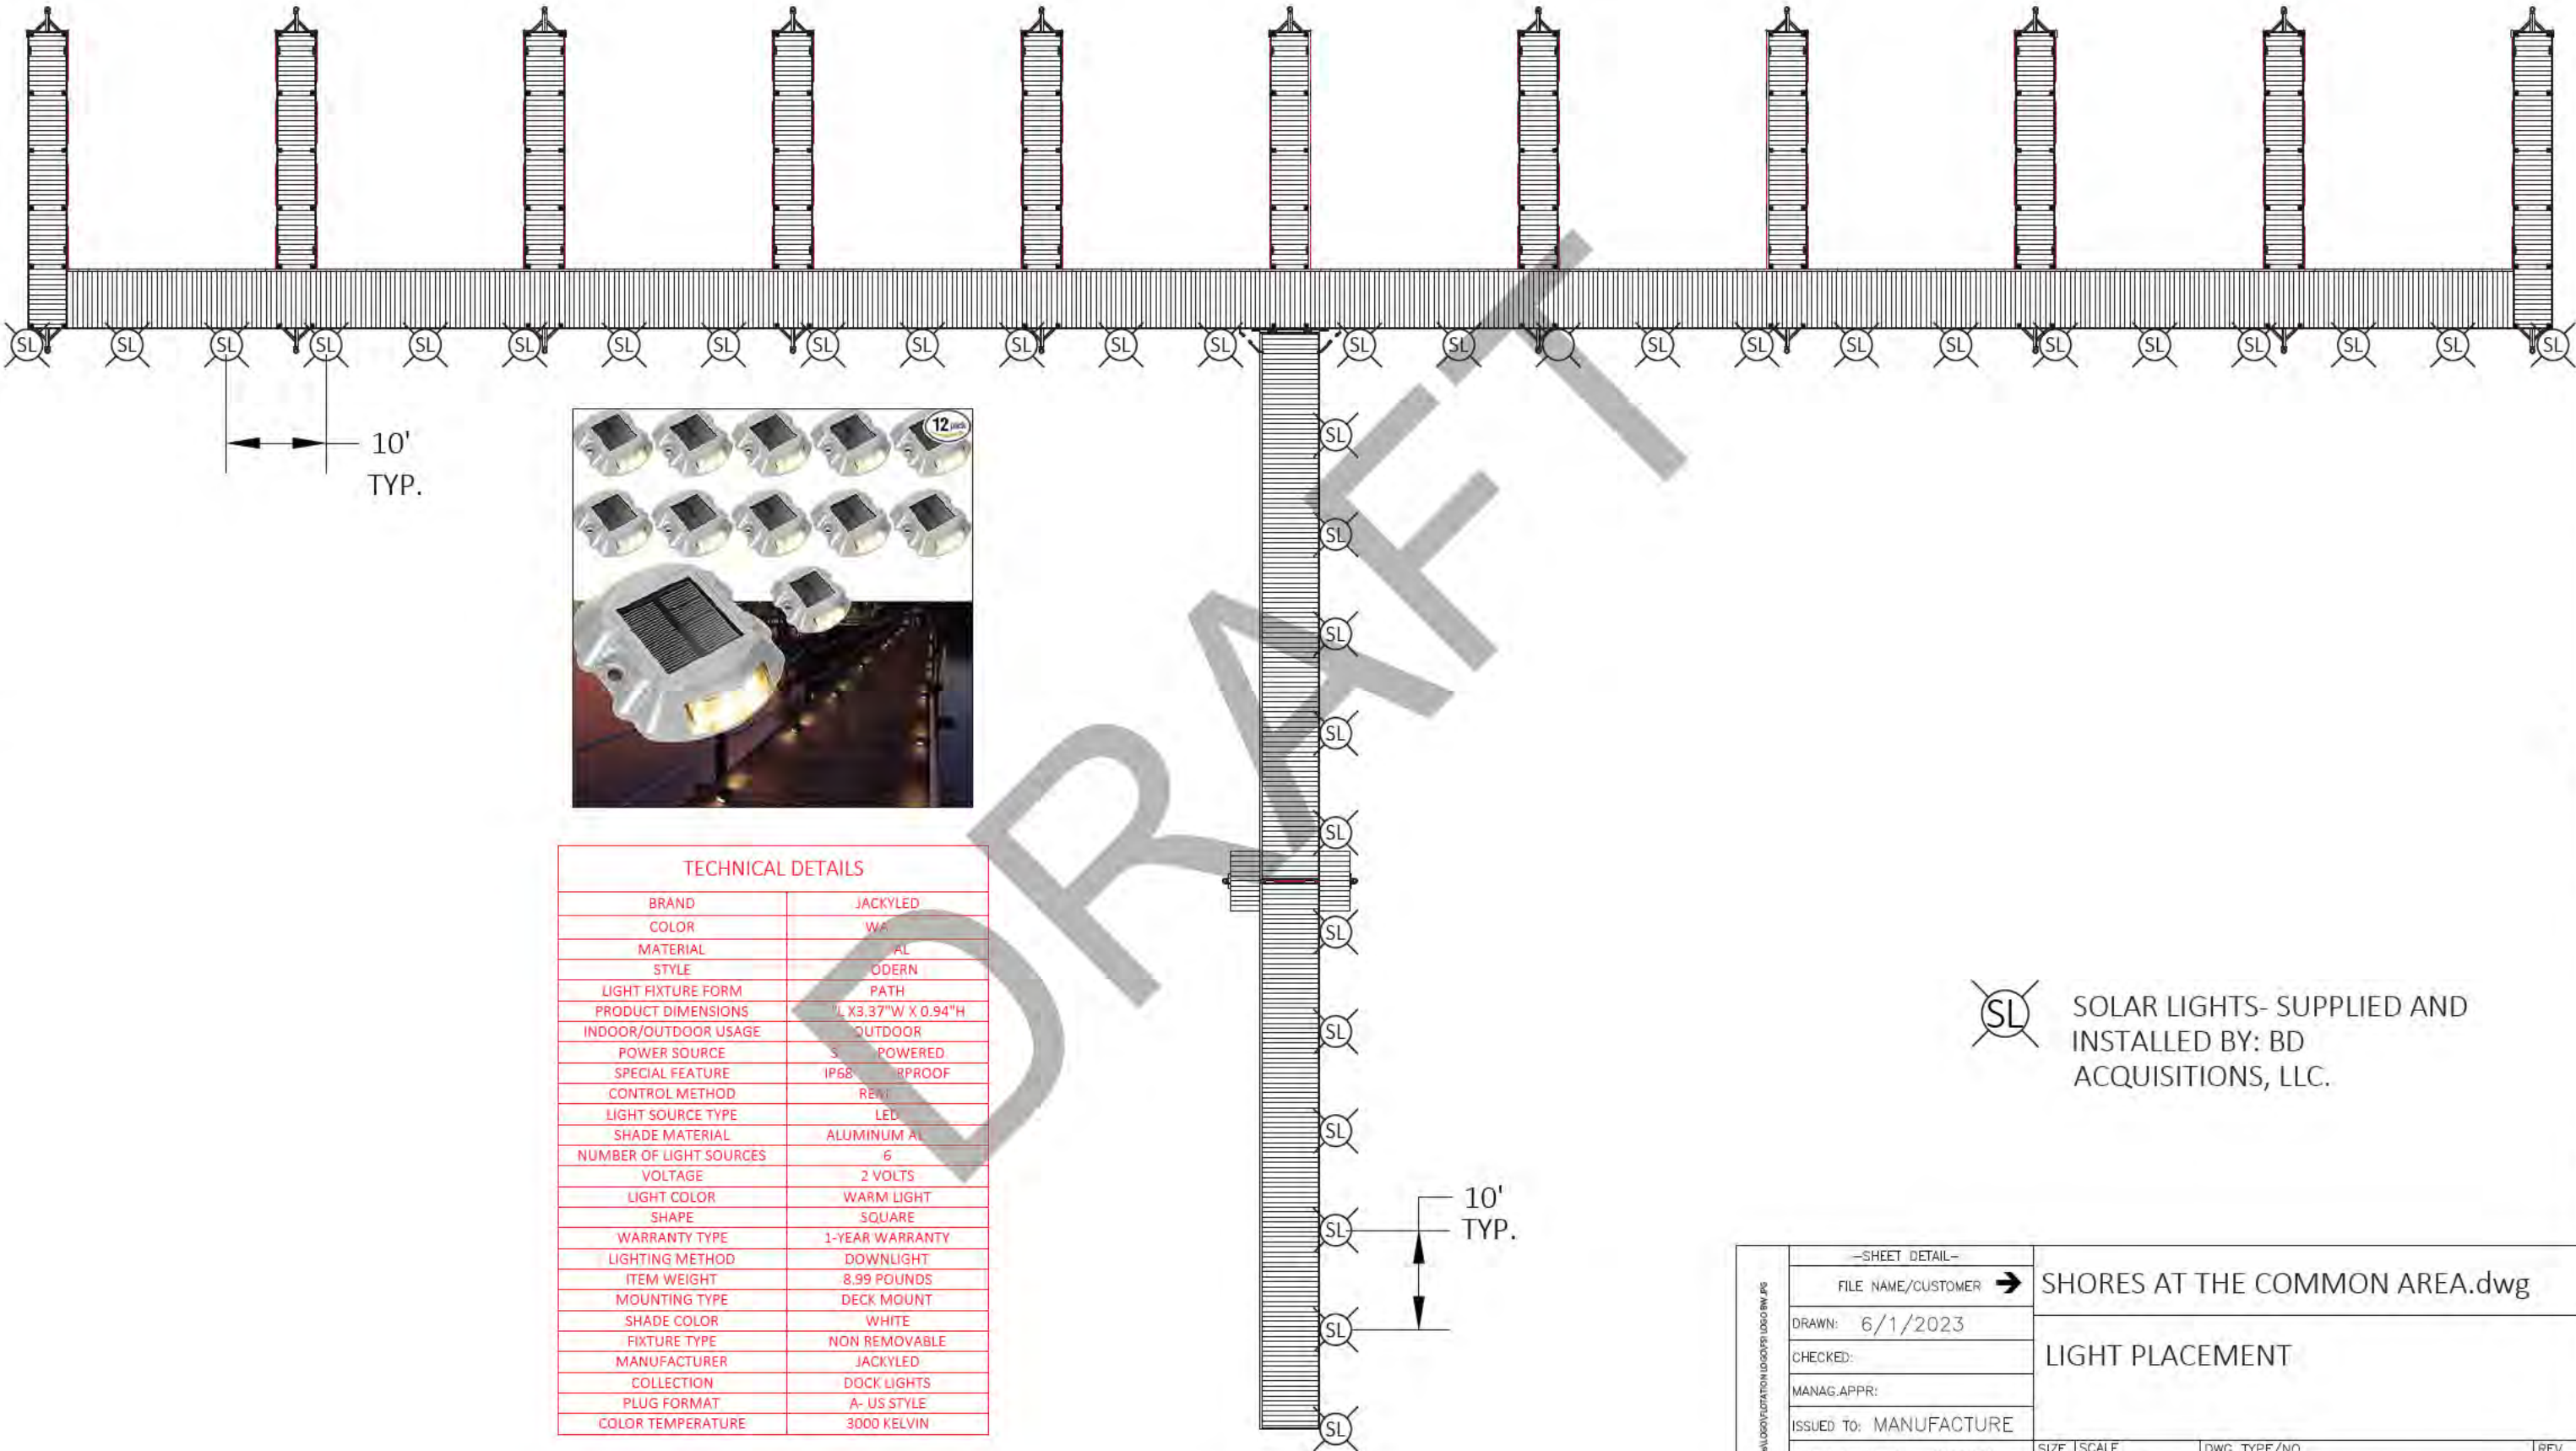

10'
TYP.



TECHNICAL DETAILS	
BRAND	JACKYLED
COLOR	WARM WHITE
MATERIAL	ALUMINUM
STYLE	MODERN
LIGHT FIXTURE FORM	PATH
PRODUCT DIMENSIONS	3.37"W X 0.94"H
INDOOR/OUTDOOR USAGE	OUTDOOR
POWER SOURCE	SOLAR POWERED
SPECIAL FEATURE	IP68 WATERPROOF
CONTROL METHOD	REMOTE
LIGHT SOURCE TYPE	LED
SHADE MATERIAL	ALUMINUM AL
NUMBER OF LIGHT SOURCES	6
VOLTAGE	2 VOLTS
LIGHT COLOR	WARM LIGHT
SHAPE	SQUARE
WARRANTY TYPE	1-YEAR WARRANTY
LIGHTING METHOD	DOWNLIGHT
ITEM WEIGHT	8.99 POUNDS
MOUNTING TYPE	DECK MOUNT
SHADE COLOR	WHITE
FIXTURE TYPE	NON REMOVABLE
MANUFACTURER	JACKYLED
COLLECTION	DOCK LIGHTS
PLUG FORMAT	A- US STYLE
COLOR TEMPERATURE	3000 KELVIN


SL SOLAR LIGHTS- SUPPLIED AND
INSTALLED BY: BD
ACQUISITIONS, LLC.

10'
TYP.

D:\Purcell\LOG\PLATATION LOG.dwg LOG.dwg

-SHEET DETAIL-	
FILE NAME/CUSTOMER ➔	
DRAWN: 6/1/2023	
CHECKED:	
MANAG.APPR:	
ISSUED TO: MANUFACTURE	
DESIGN DRAFTER: R.BAKER	
FABRICATOR:	

SHORES AT THE COMMON AREA.dwg			
LIGHT PLACEMENT			
SIZE	SCALE	DWG TYPE/NO.	REV
B	1:200		0
			SHEET 42 OF 42

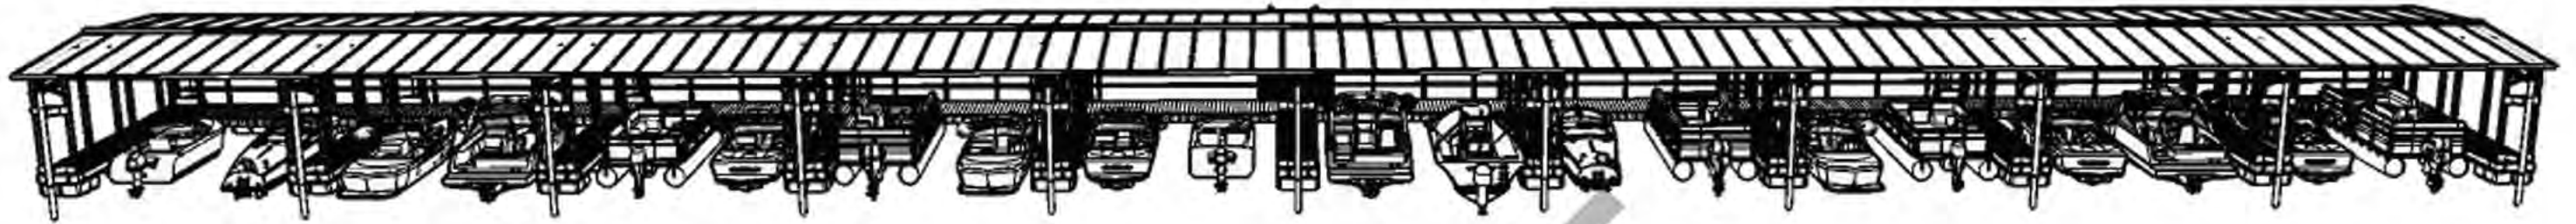

THE SHORES AT THE PENINSULA
2769 County Road 2730
Honey Grove, TX 75446

DESIGN CRITERIA

BUILDING CODE: IBC 2015 & ASCE 7-10

LOADING:

DEAD LOAD (roof) 3psf
DEAD LOAD (bridge) 3.5psf
LIVE LOAD (roof) 20psf
LIVE LOAD (bridge) 25psf
SNOW LOAD 4psf
WIND LOAD 23psf

ALUMINUM CODE: ADM 2010
ALUMINUM ALLOY: 6005A-T61
FILLER ALLOY: 5356

THE PEDESTRIAN BRIDGE SHOULD BE
LIMITED TO A CAPACITY OF 12 PERSONS
OR 2,000LBS.

DRAWING LIST			
SHEET NUMBER	DESCRIPTION	SHEET NUMBER	DESCRIPTION
1	BANK VIEW A	22	8' COLLAR FRONT
2	BANK VIEW B	23	8' COLLAR TOP
3	ANK VIEW	24	8' COLLAR
4	LEFT VIEW	25	4IN STUB UP
5	ANGLE CUTLIST	26	3' COLLAR VIEWS
6	WATER VIEW A	27	3' COLLAR
7	WATER VIEW B	28	21' POLE
	WATER VIEW C	29	SR1
	AN VIEW	30	SR2
10	ANCHORING VIEW	31	RAMP SIDE VIEW
11	FLOAT DIAGRAM	32	RAMP SIDE DIAGRAM
12	ROOF ASSEMBLY	33	RAMP DECKING DIAGRAM
13	FRAME DIAGRAM	34	RAMP DECKING CUTLIST
14	DECKING DIAGRAM	35	END RAMP DETAIL
15	POST DIAGRAM	36	MIDDLE RAMP DETAIL
16	BW627L	37	EQ END RAMP DETAIL
17	BW625	38	EQ END RAMP ATTACHMENT
18	BW625A	39	EQUALIZER
19	ATTACHMENT SHEET	40	UNDERCARRIAGE
20	F424	41	ACCESSORIES
21	8' COLLAR SIDE	42	LOAD SHEET



BANK VIEW SECTION "A"

BANK VIEW
SECTION "B"

BANK VIEW SECTION "C"

D

D

C

C

B

B

A

A

K-SP1
24

SP-1
29

D:\Virtual\LOGO\FLUTATION LOGO\VEI LOGO.BMP	-SHEET DETAIL-			SHORES AT THE PENINSULA.dwg			
	FILE NAME/CUSTOMER ➔						
	DRAWN: 6/1/2023			BANK VIEW SECTION "A"			
	CHECKED:						
	MANAG.APPR:						
	ISSUED TO: MANUFACTURE						
	DESIGN DRAFTER: R.BAKER			SIZE B	SCALE 1:88	DWG TYPE/NO.	REV 0
	FABRICATOR:						
						SHEET 1 OF 42	



BANK VIEW SECTION "A"

BANK VIEW
SECTION "B"

BANK VIEW SECTION "C"

D

D

C

C

B

B

A

A

SP-2
30

RA-1
19

-SHEET DETAIL-

FILE NAME/CUSTOMER

SHORES AT THE PENINSULA.dwg

DRAWN: 6/1/2023

CHECKED:

MANAG.APPR:

ISSUED TO: MANUFACTURE

DESIGN DRAFTER: R.BAKER

FABRICATOR:

BANK VIEW
SECTION "B"

SIZE
B

SCALE
1:32

DWG TYPE/NO.

REV
0

SHEET 2 OF 42

BANK VIEW SECTION "A"

BANK VIEW
SECTION "B"

BANK VIEW SECTION "C"

K-SP1
24

-SHEET DETAIL-

FILE NAME/CUSTOMER →

SHORES AT THE PENINSULA.dwg

DRAWN: 6/1/2023

CHECKED:

MANAG.APPR:

ISSUED TO: MANUFACTURE

DESIGN DRAFTER: R.BAKER

FABRICATOR:

BANK VIEW
SECTION "C"

SIZE

B

SCALE

1:80

DWG TYPE/NO.

REV

0

SHEET 3 OF 42



ROOF MATERIAL CUT LIST

	QTY.	2" X 2" ANGLE BRACING
F	10	6'-5 1/12" LG.
G	10	6'-5 1/8" LG.
H	10	6'-5 1/16" LG.
I	10	6'-3 5/16"
J	20	4'-5 1/4"
K	40	5'-2 7/16
L	10	29'-7 1/8
	QTY.	Z-BEAM
N	16	30'
O	64	29'

D:\Virtual\LOGO\UTATION\LOGO\VS LOGO.BMP	-SHEET DETAIL-			SHORES AT THE PENINSULA.dwg			
	FILE NAME/CUSTOMER ➔						
	DRAWN: 6/1/2023			RIGHT SIDE VIEW			
	CHECKED:						
	MANAG.APPR:						
	ISSUED TO: MANUFACTURE						
	DESIGN DRAFTER: R.BAKER						SIZE B
	FABRICATOR:						SHEET 5 OF 42

BANK VIEW SECTION "A"

BANK VIEW
SECTION "B"

BANK VIEW SECTION "C"

K-SP1
24

-SHEET DETAIL-

FILE NAME/CUSTOMER

SHORES AT THE PENINSULA.dwg

DRAWN: 6/1/2023

CHECKED:

MANAG.APPR:

ISSUED TO: MANUFACTURE

DESIGN DRAFTER: R.BAKER

FABRICATOR:

WATER VIEW
SECTION "A"

SIZE
B

SCALE
1:50

DWG TYPE/NO.


REV
0

SHEET 6 OF 42

BANK VIEW SECTION "A"

BANK VIEW
SECTION "B"

BANK VIEW SECTION "C"


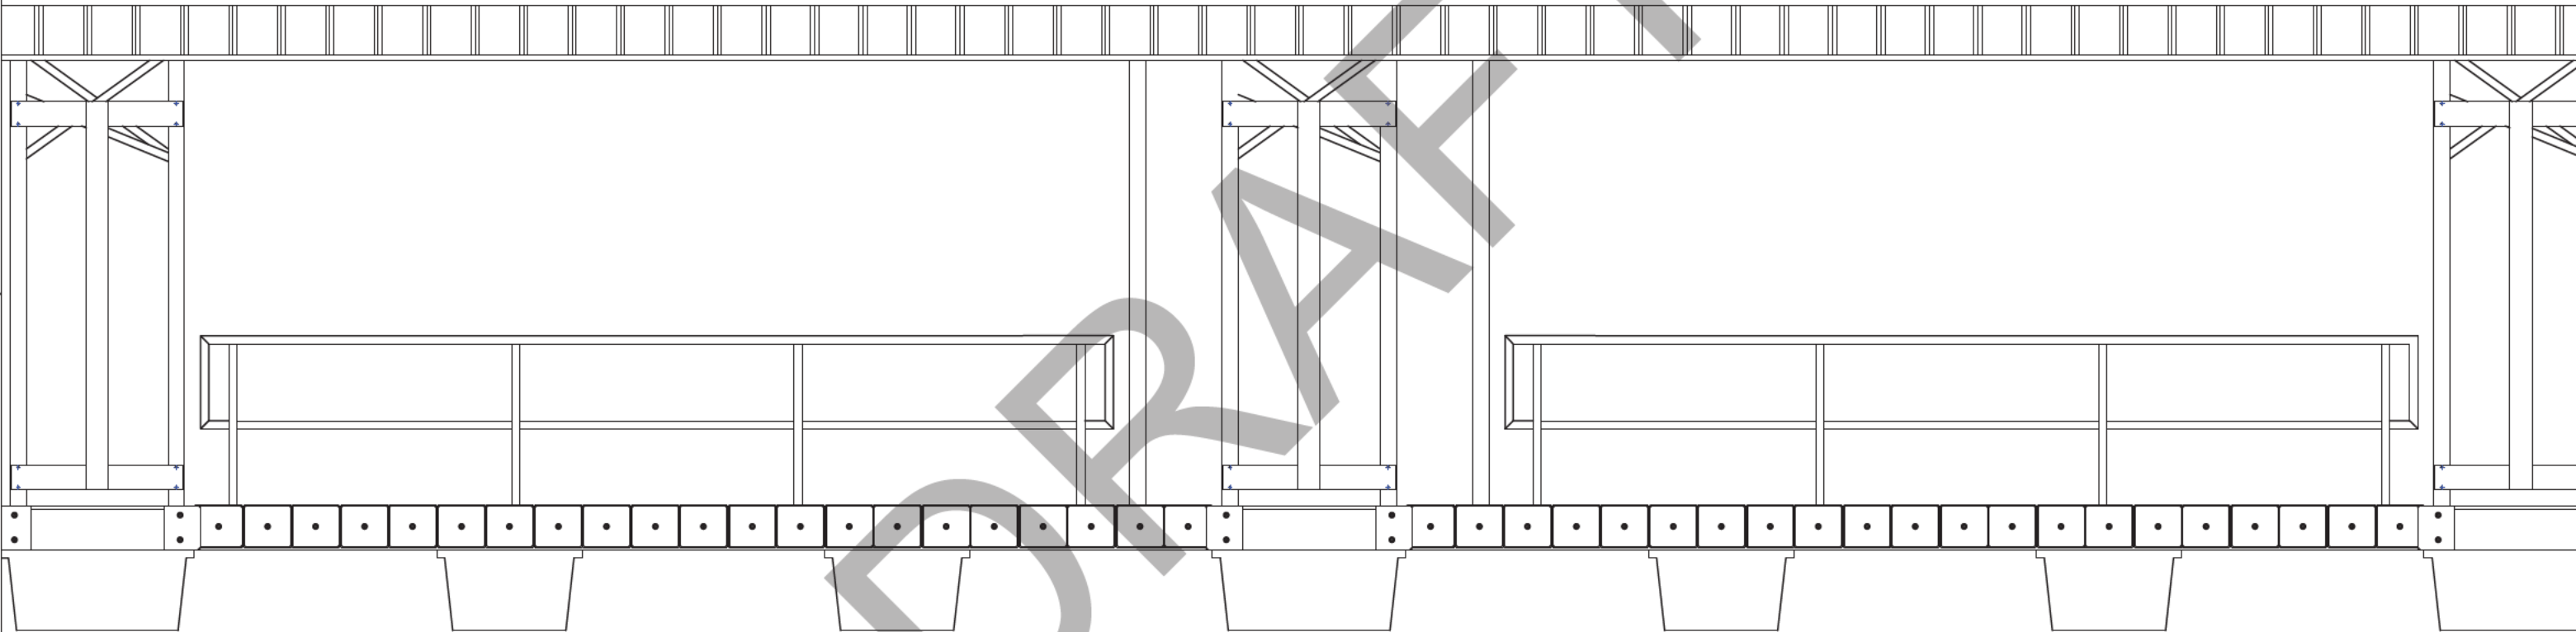


D:\Virtual\LOGO\UTATION\LOGO\VS LOGO BW.JPG	-SHEET DETAIL-				SHORES AT THE PENINSULA.dwg			
	FILE NAME/CUSTOMER ➔							
	DRAWN: 6/1/2023				WATER VIEW SECTION "A"			
	CHECKED:							
	MANAG.APPR:							
	ISSUED TO: MANUFACTURE							
	DESIGN DRAFTER: R.BAKER				SIZE	SCALE	DWG TYPE/NO.	REV
	FABRICATOR:				B	1:50		0
						SHEET 7 OF 42		

BANK VIEW SECTION "A"

BANK VIEW
SECTION "B"

BANK VIEW SECTION "C"

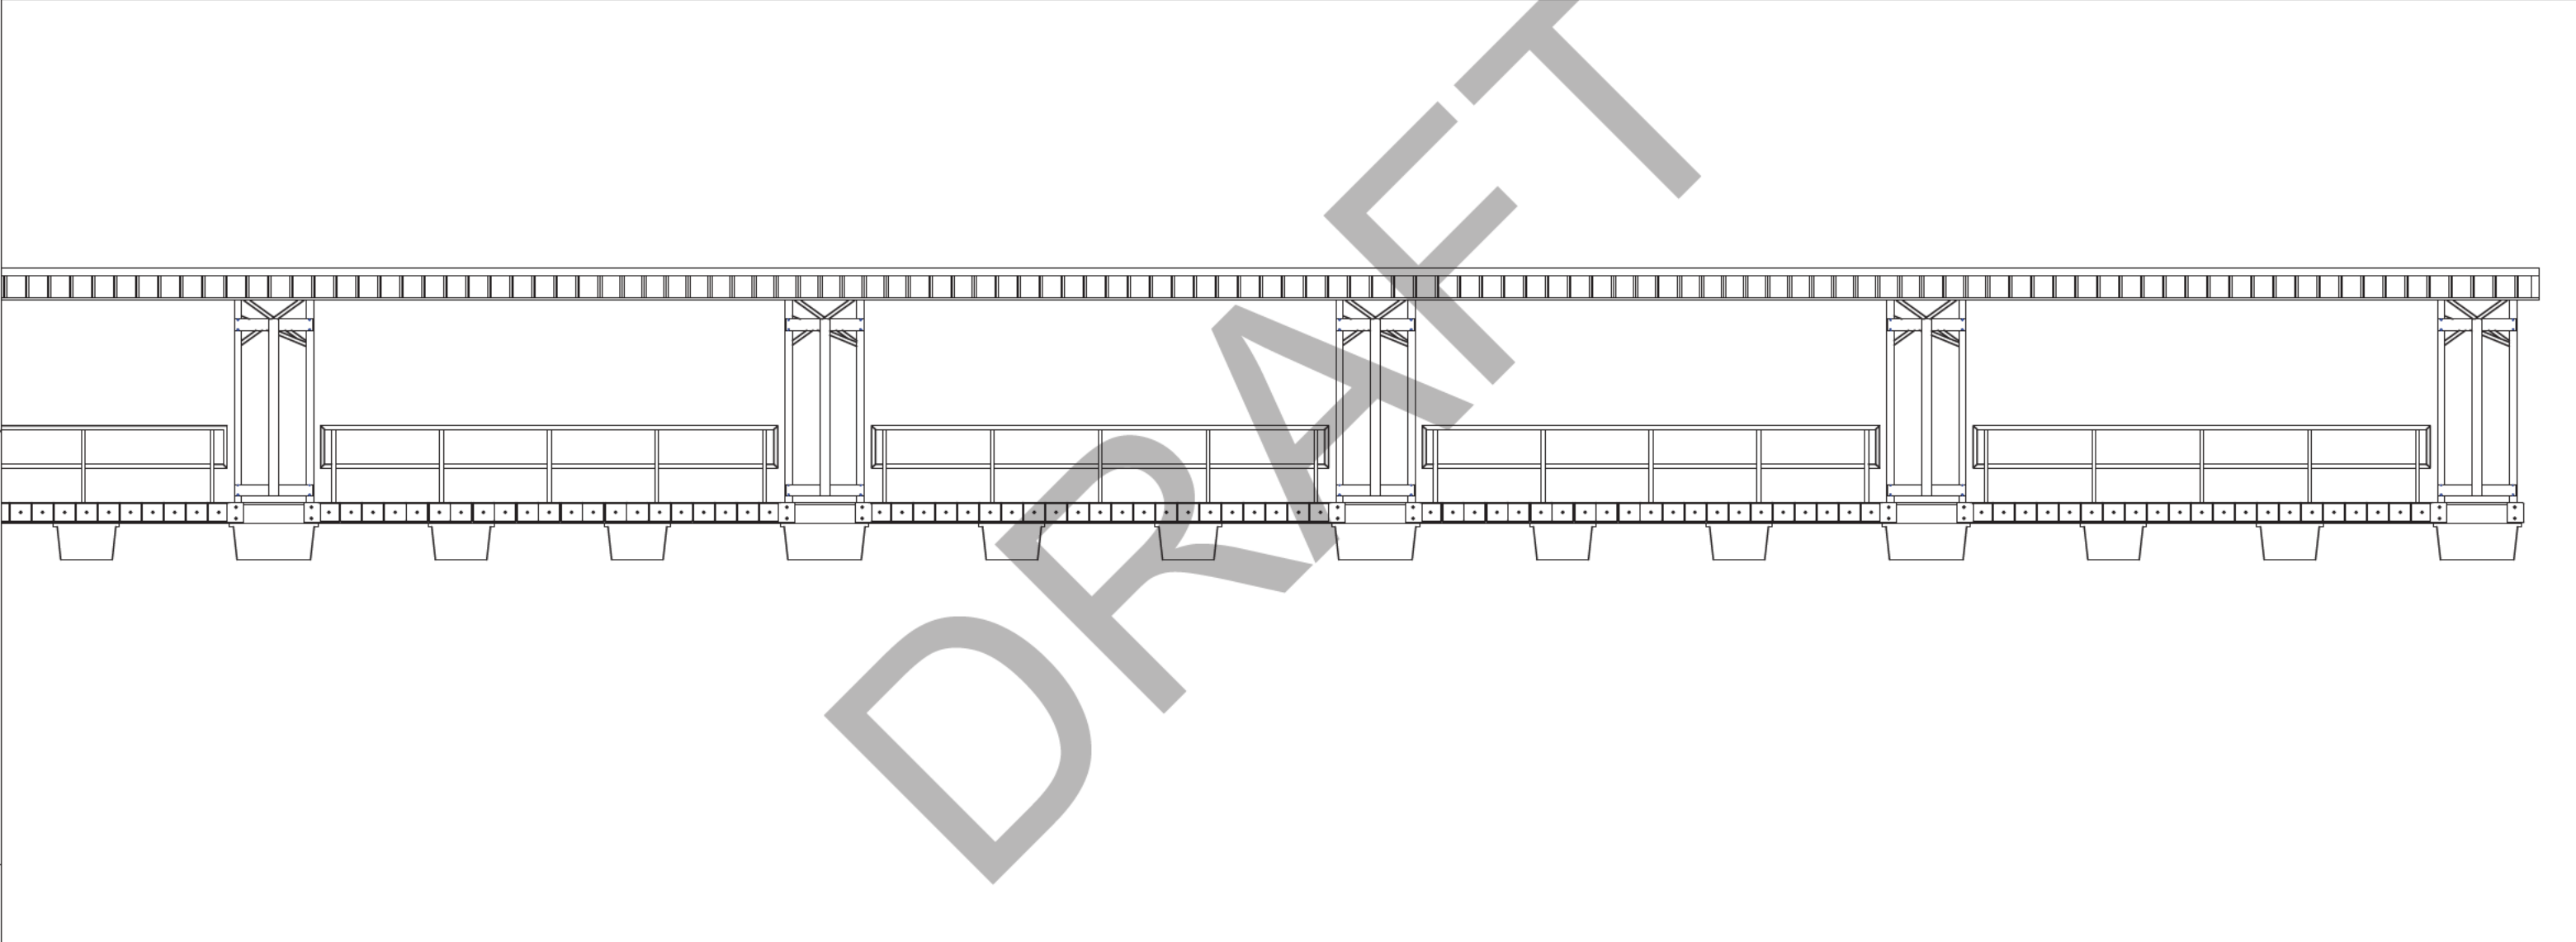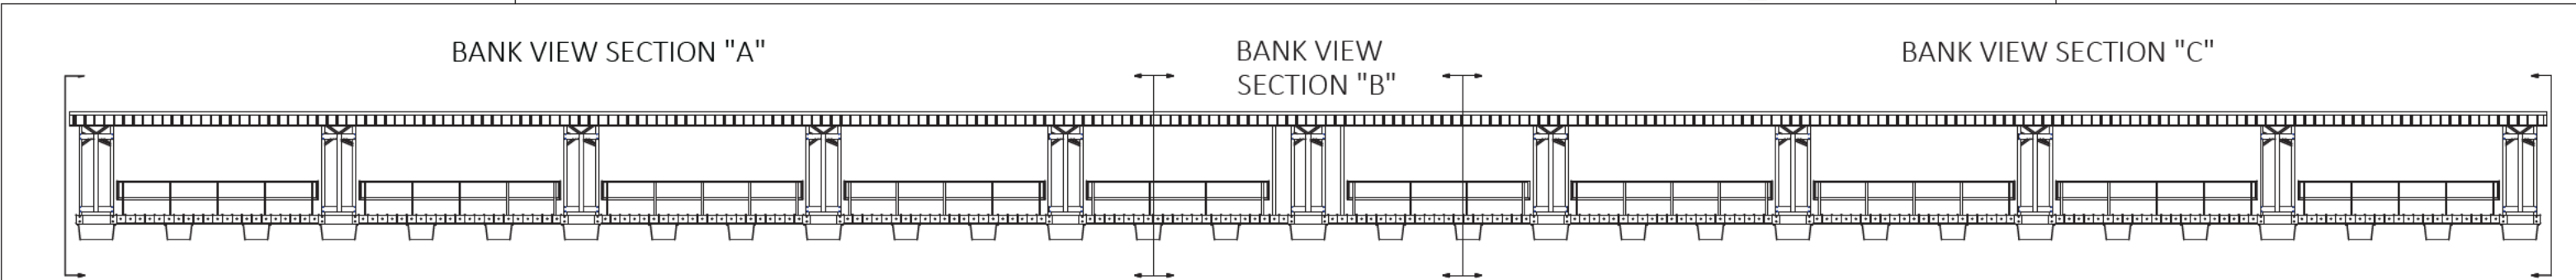

-SHEET DETAIL-		SHORES AT THE PENINSULA.dwg	
FILE NAME/CUSTOMER →		WATER VIEW SECTION "A"	
DRAWN: 6/1/2023		SIZE SCALE DWG TYPE/NO. REV	
CHECKED:		B 1:80	
MANAG.APPR:		SHEET 8 OF 42	
ISSUED TO: MANUFACTURE			
DESIGN DRAFTER: R.BAKER			
FABRICATOR:			

D

D

C


C

B

B

A

A

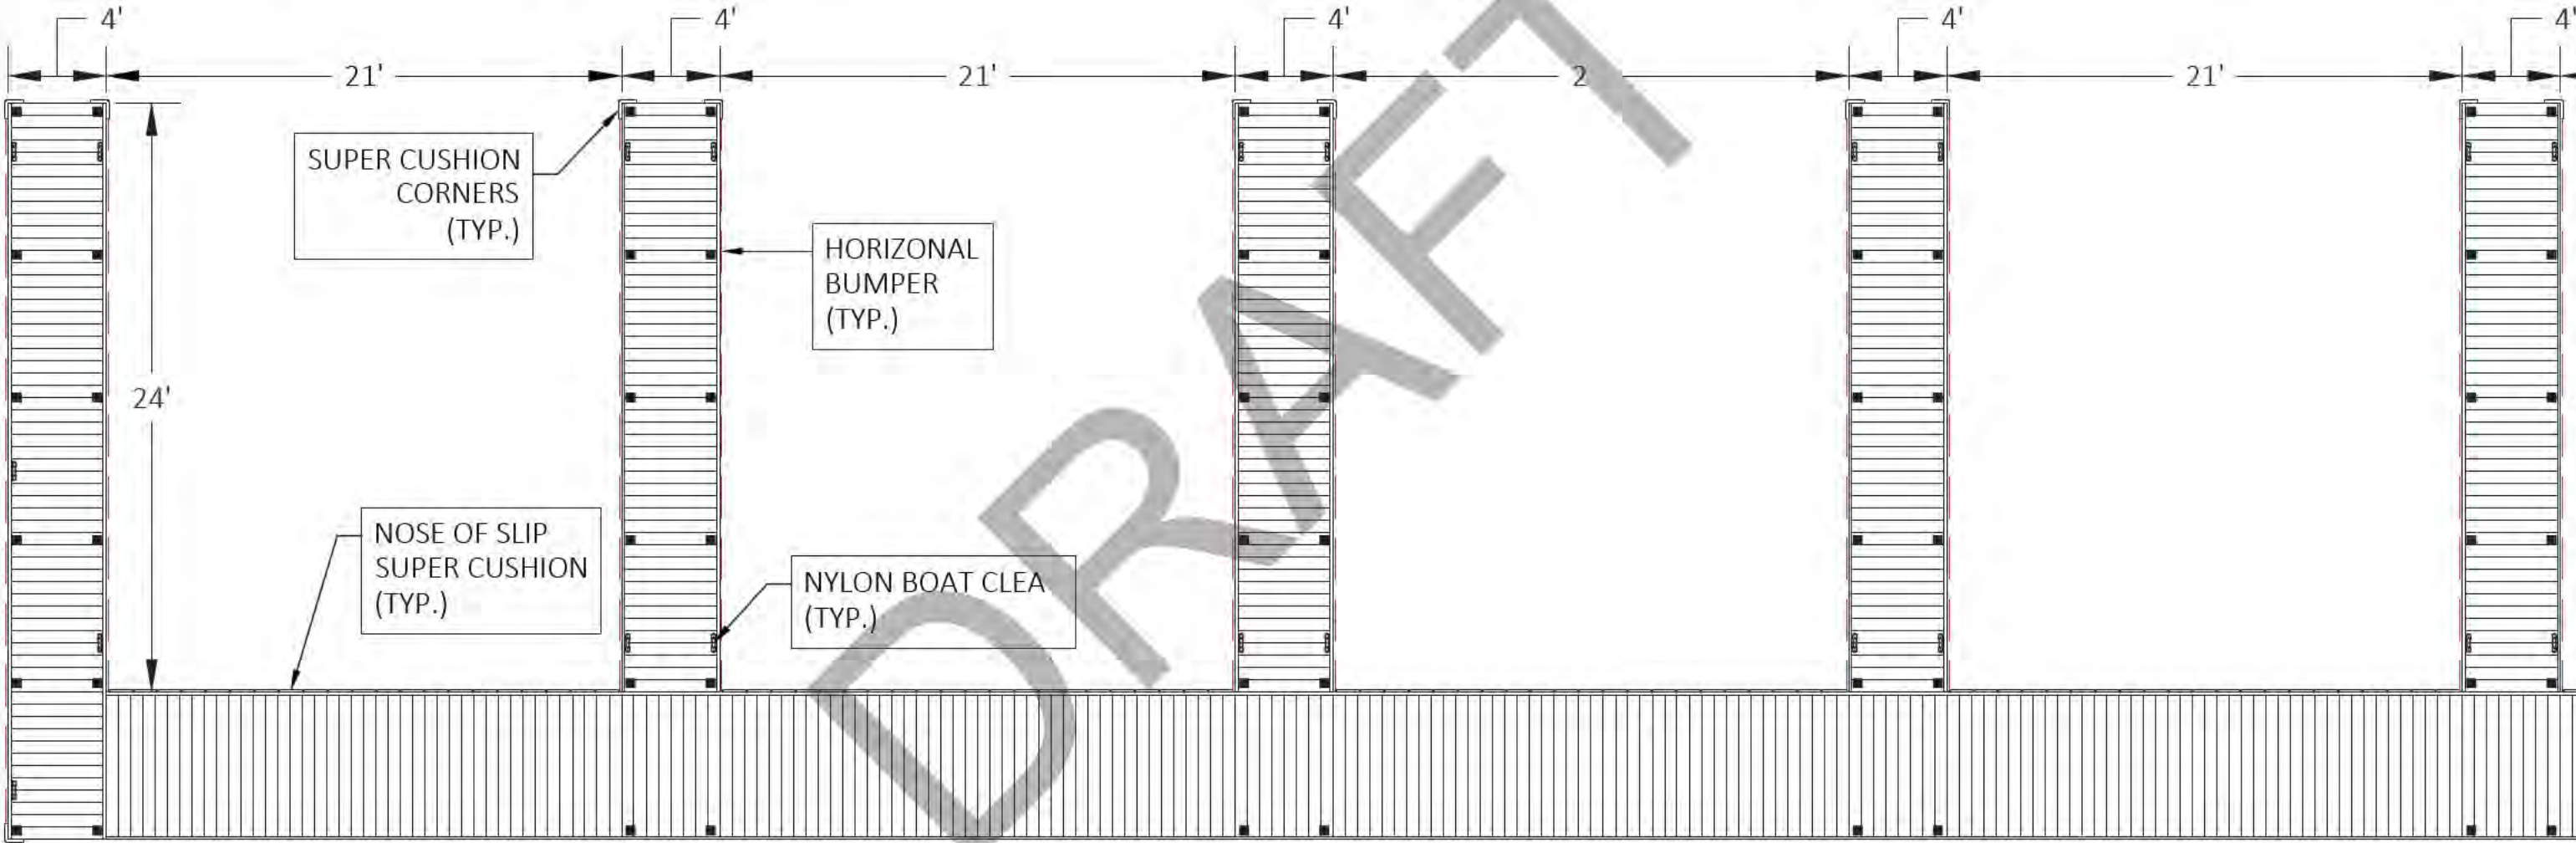

ACC. INCLUDE:

- (105) NOSE OF SLIP SUPER CUSHION
- (42) NYLON BOAT CLEATS
- (540') HORIZONTAL BUMPER
- (24) SUPER CUSHION CORNER BUMPERS

-SHEET DETAIL-

FILE NAME/CUSTOMER →

SHORES AT THE PENINSULA.dwg

DRAWN: 6/1/2023

CHECKED:

MANAG. APPR:

ISSUED TO: MANUFACTURE

DESIGN DRAFTER: R. BAKER

FABRICATOR:

PLAN VIEW

SIZE B SCALE 1:50

DWG TYPE/NO.

REV

0

SHEET 9 OF 42



D

D

C


C

B

B

A

A

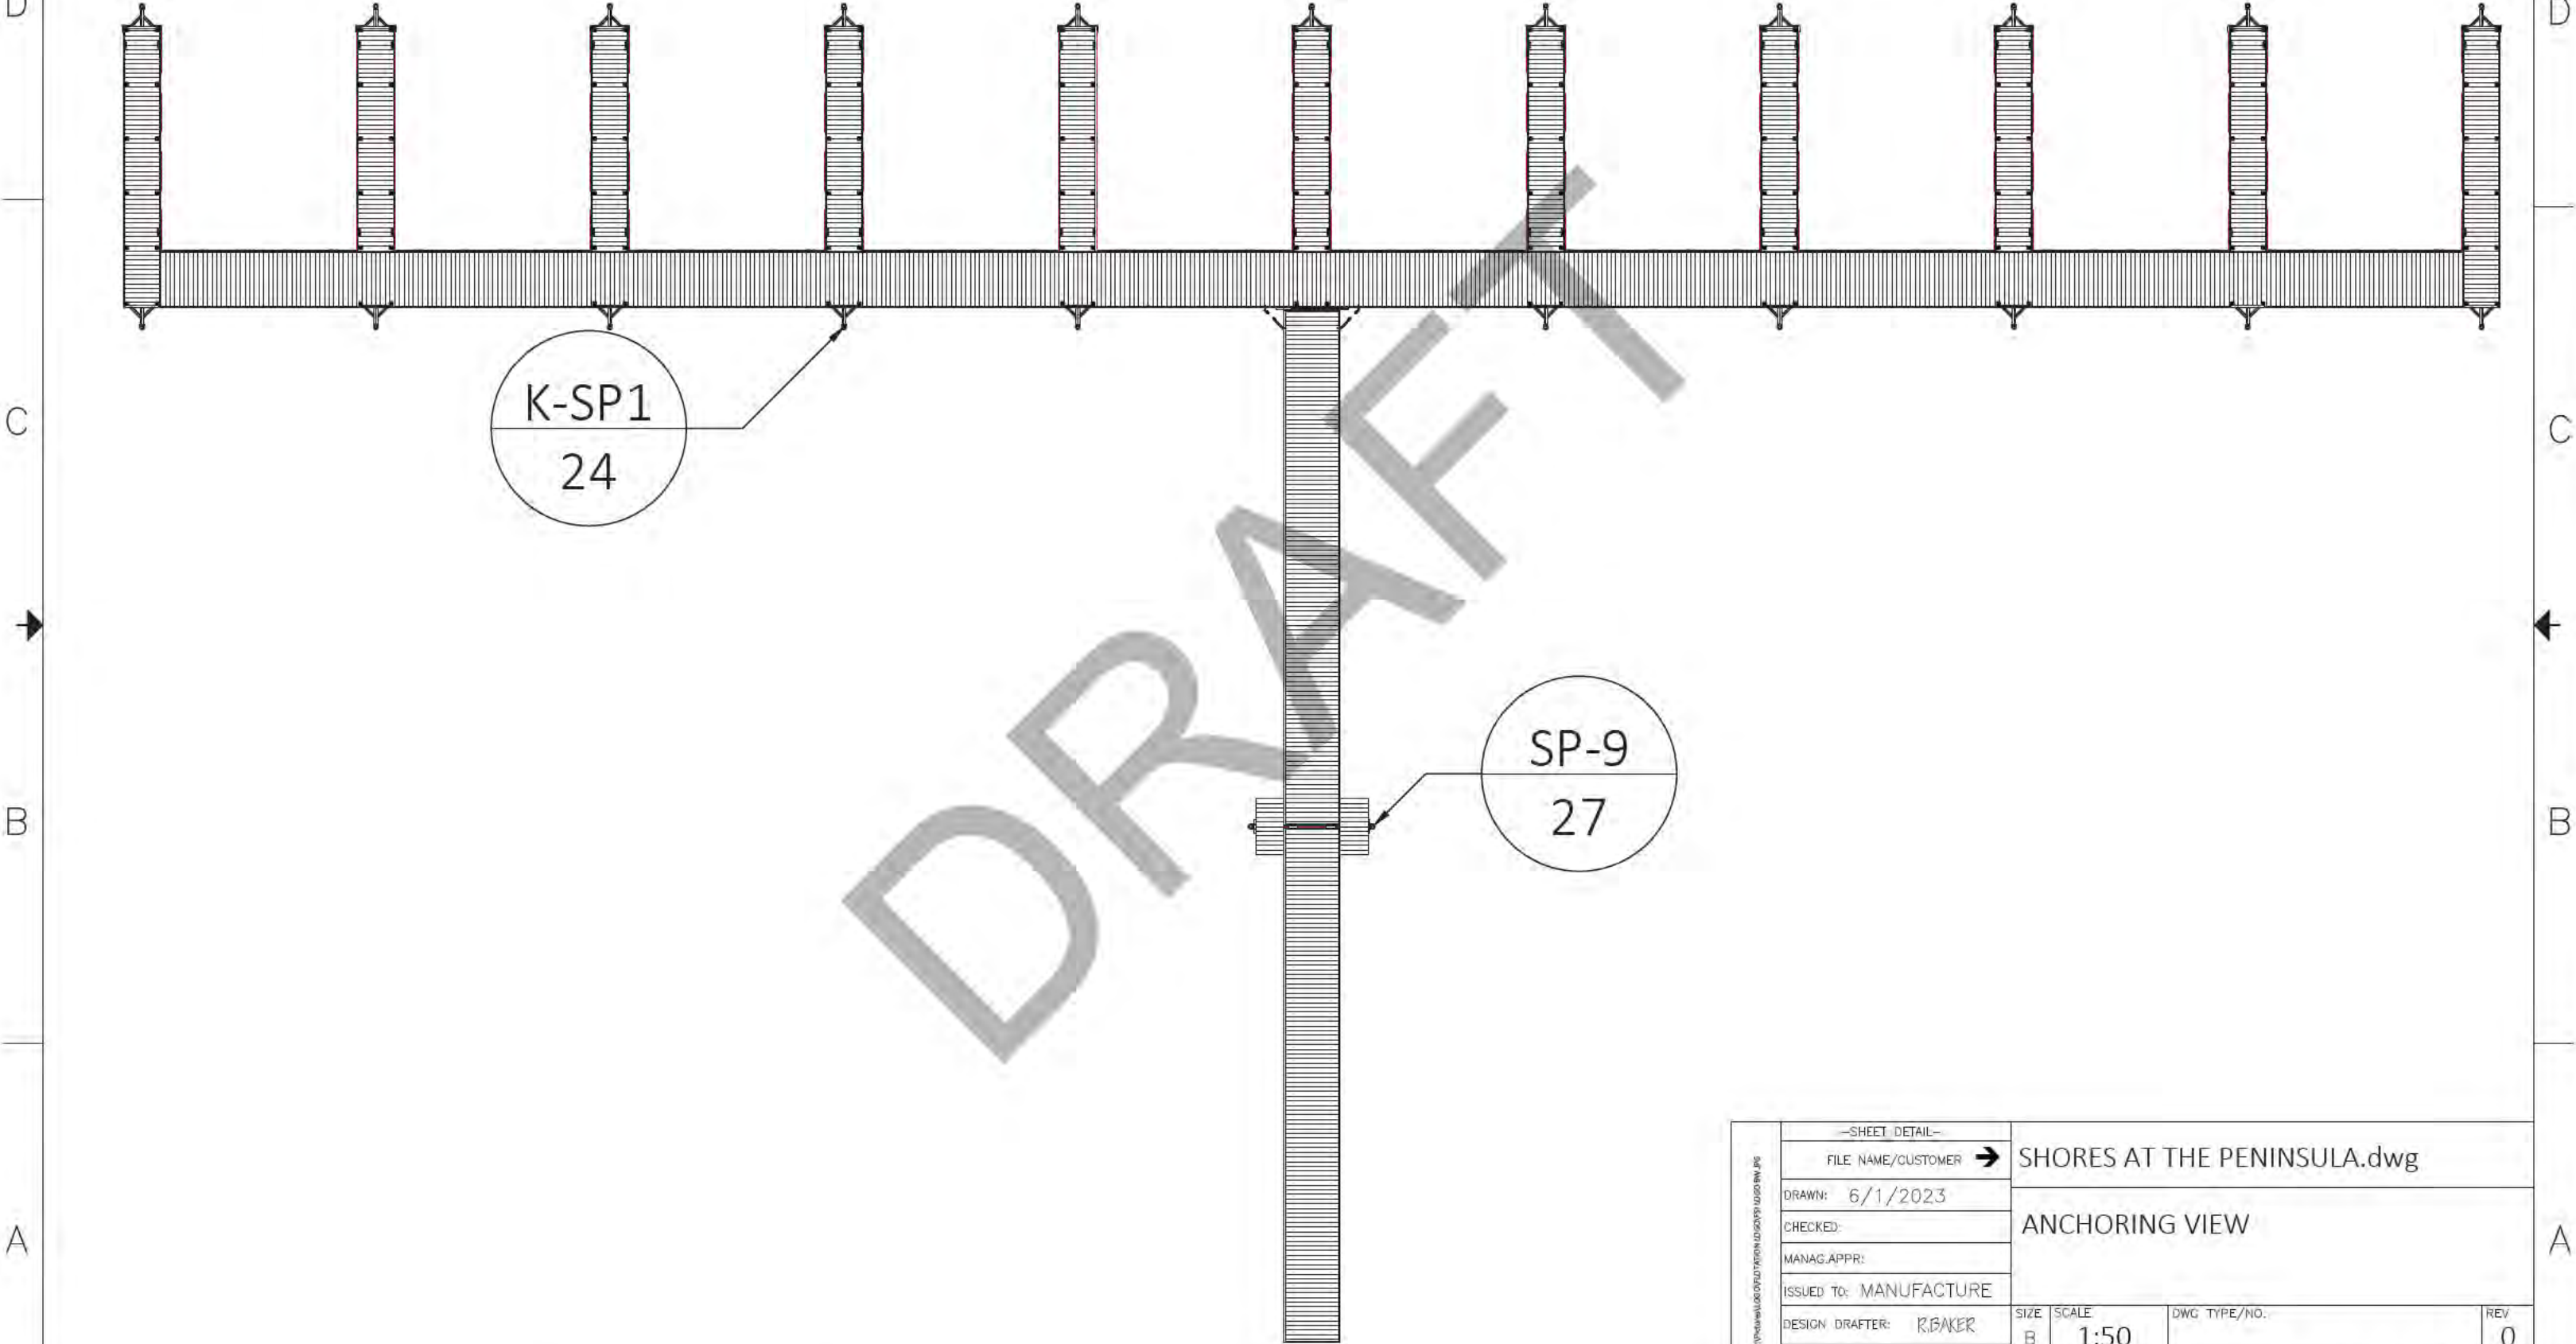

SHEET INFORMATION	--SHEET DETAIL--			SHORES AT THE PENINSULA.dwg			
	FILE NAME/CUSTOMER ➔						
	DRAWN: 6/1/2023			ANCHORING VIEW			
	CHECKED:						
	MANAG.APPR:						
	ISSUED TO: MANUFACTURE						
	DESIGN DRAFTER: R.BAKER			SIZE B	SCALE 1:50	DWG TYPE/NO.	REV 0
	FABRICATOR:					SHEET 10 OF 42	

D

D

C


C

B


B

A

A

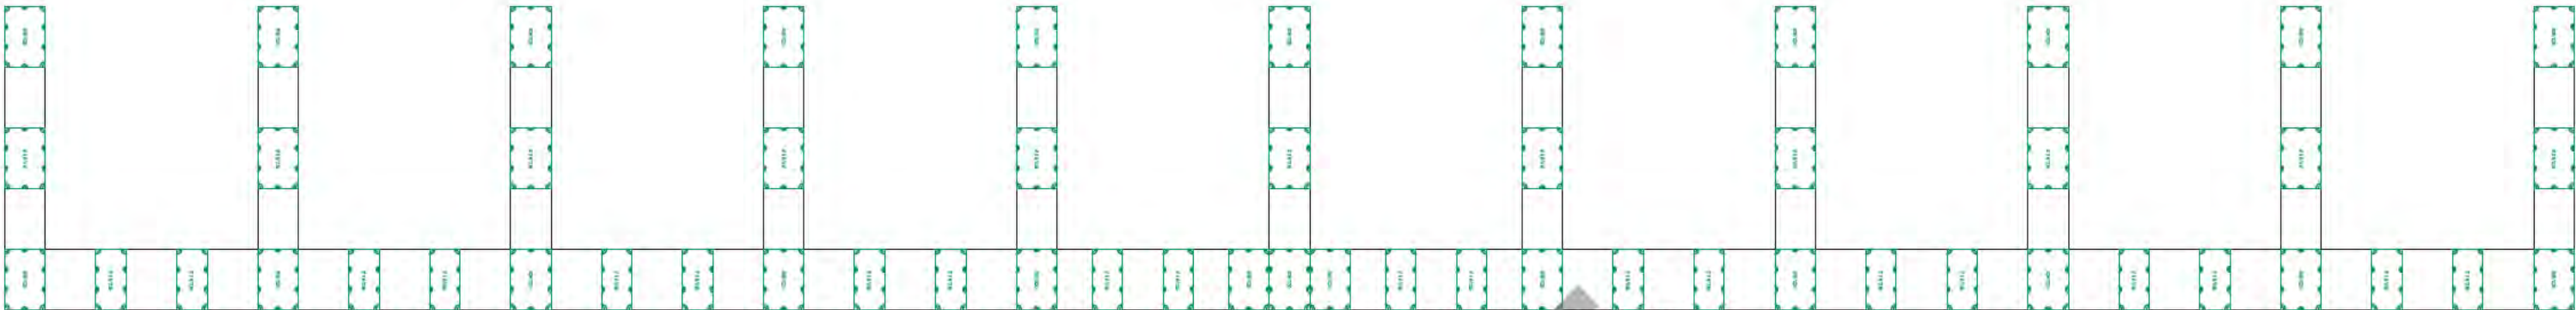


RAMP ATTACHMENT FLOATATION

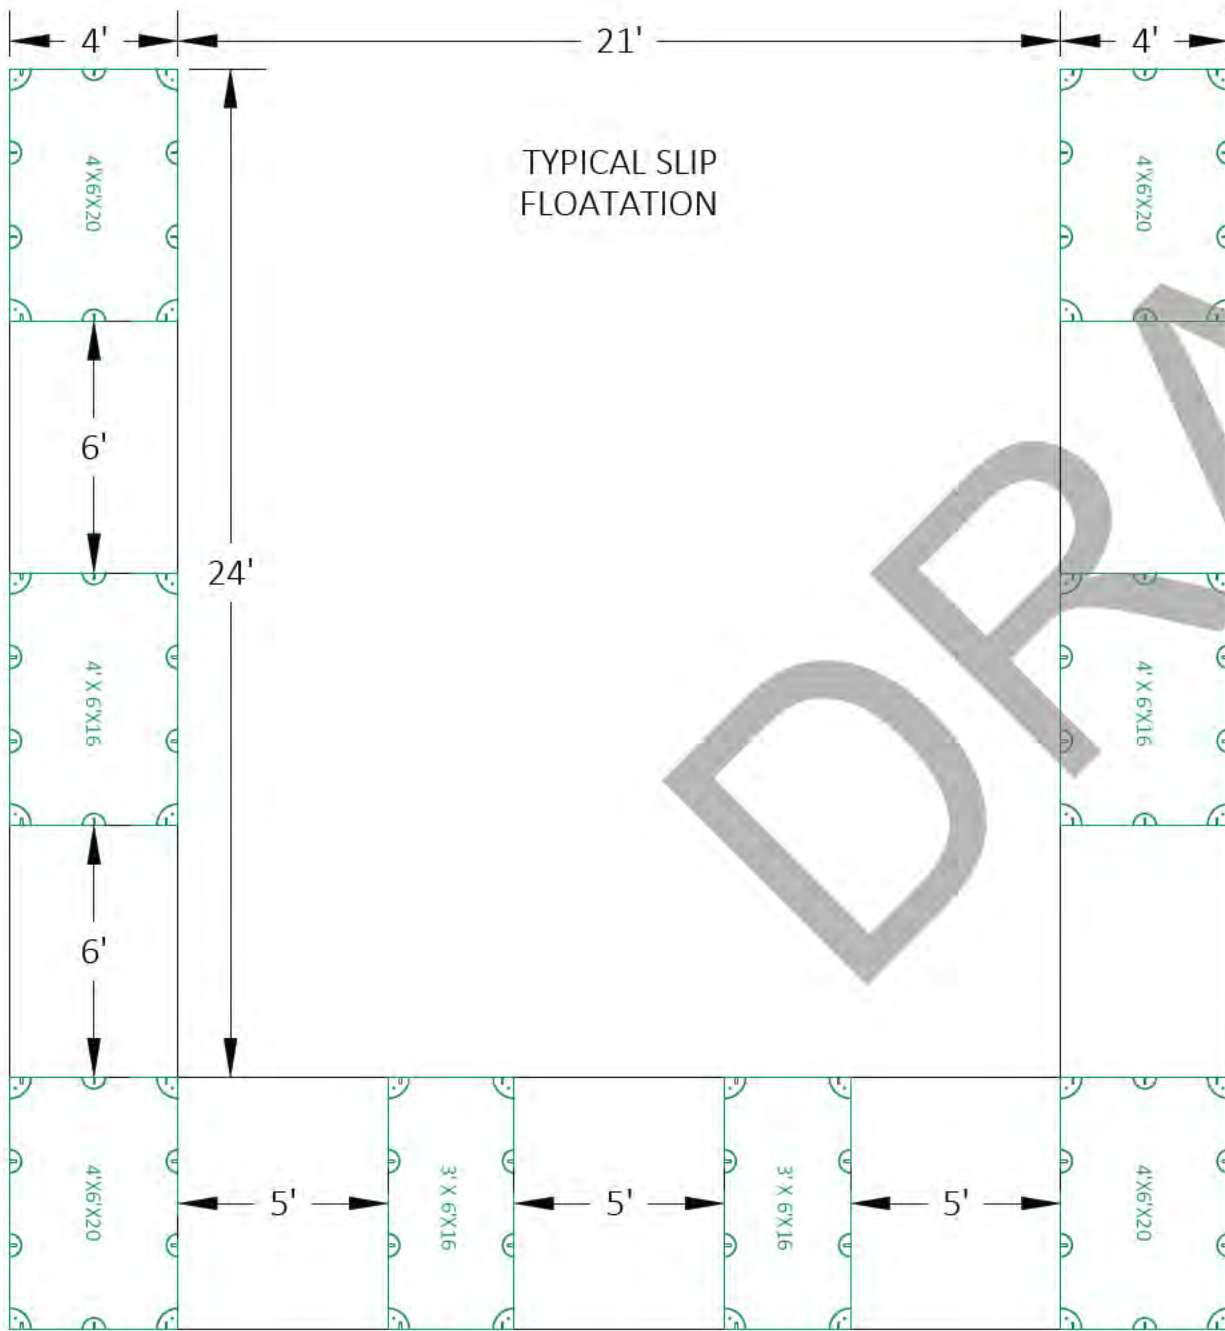

TYPICAL SLIP
FLOATATION


RAMP ATTACHMENT FLOATATION

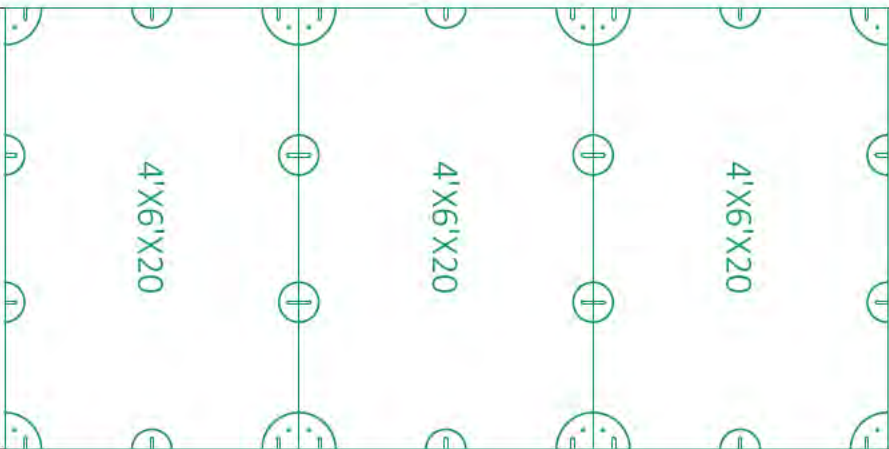

4 X 6 X 16-11
4 X 6 X 20-24
3 X 6 X 16-20


-SHEET DETAIL-		SHORES AT THE PENINSULA.dwg		
FILE NAME/CUSTOMER		DRAWN: 6/1/2023		
CHECKED:		MANAG.APPR:		
ISSUED TO: MANUFACTURE		DESIGN DRAFTER: R.BAKER		
FABRICATOR:		SIZE B		
		SCALE 1:56		
		DWG TYPE/NO.		
		REV 0		
		SHEET 11 OF 42		

- (2) 3/8"X5 1/2" H.B.
- (4) 3/8"X7/8" WASHERS
- (2) 3/8" NYLOCK NUTS
PER POST

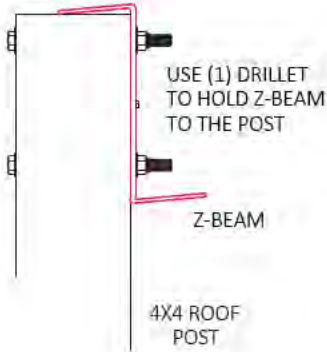

OVERHANG THE
ROOF POST 1'

Z-BEAM LAPS OVER
THE NEXT Z-BEAM 4'

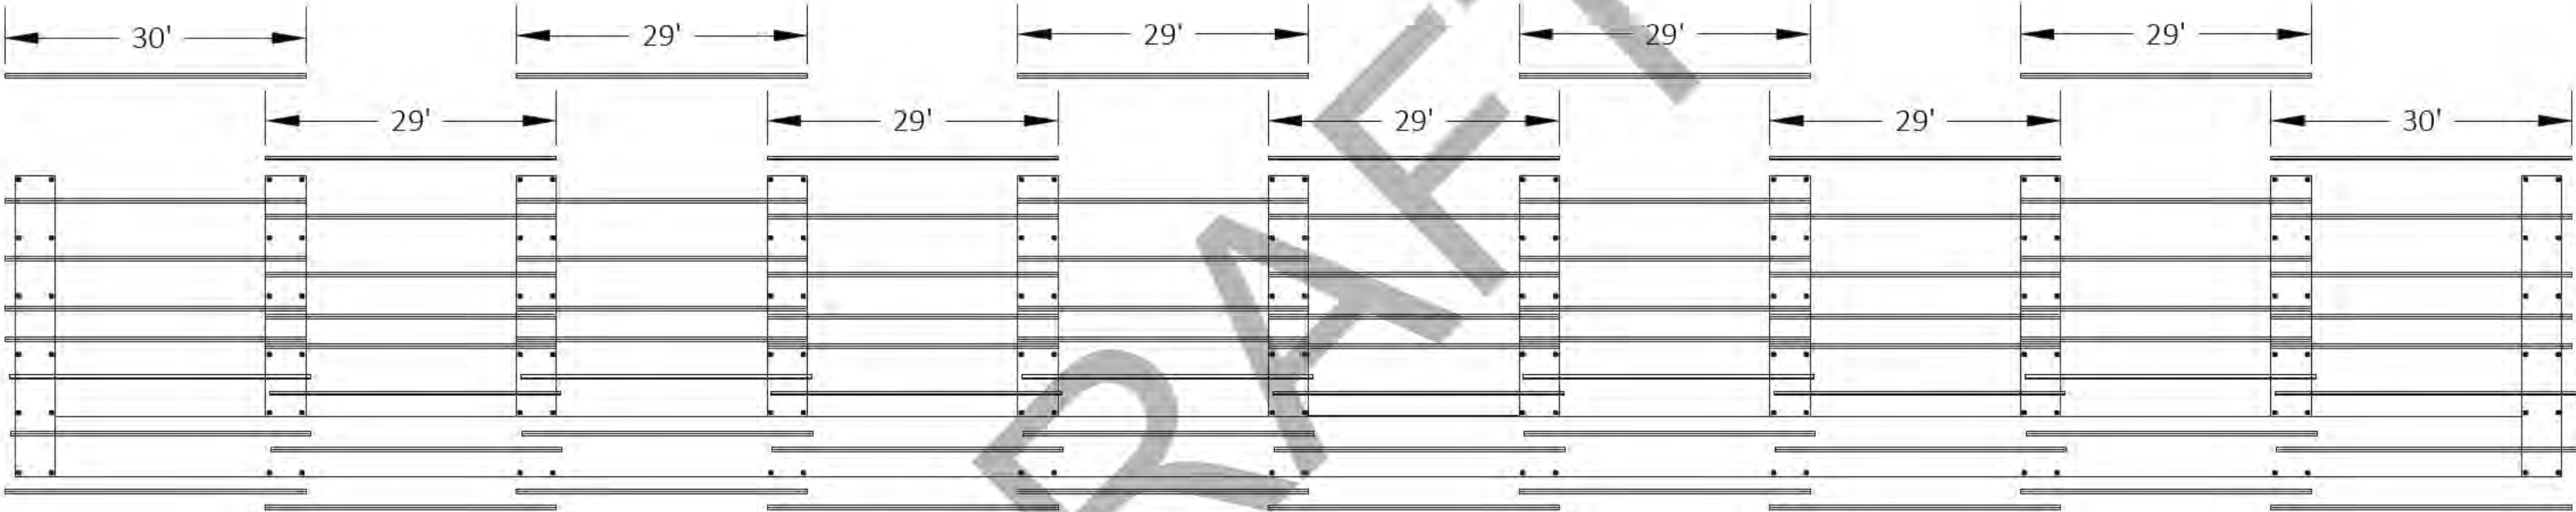

SHEET 12 OF 42	--SHEET DETAIL--			SHORES AT THE PENINSULA.dwg
	FILE NAME/CUSTOMER ➔			
	DRAWN: 6/1/2023			ROOF ASSEMBLY
	CHECKED:			
	MANAG. APPR:			
	ISSUED TO: MANUFACTURE			
	DESIGN DRAFTER: R. BAKER			
	FABRICATOR:			
SIZE	SCALE	DWG TYPE/NO.		REV
B	1:180			0
		SHEET 12 OF 42		

D

D

C


C

B

B

A


A

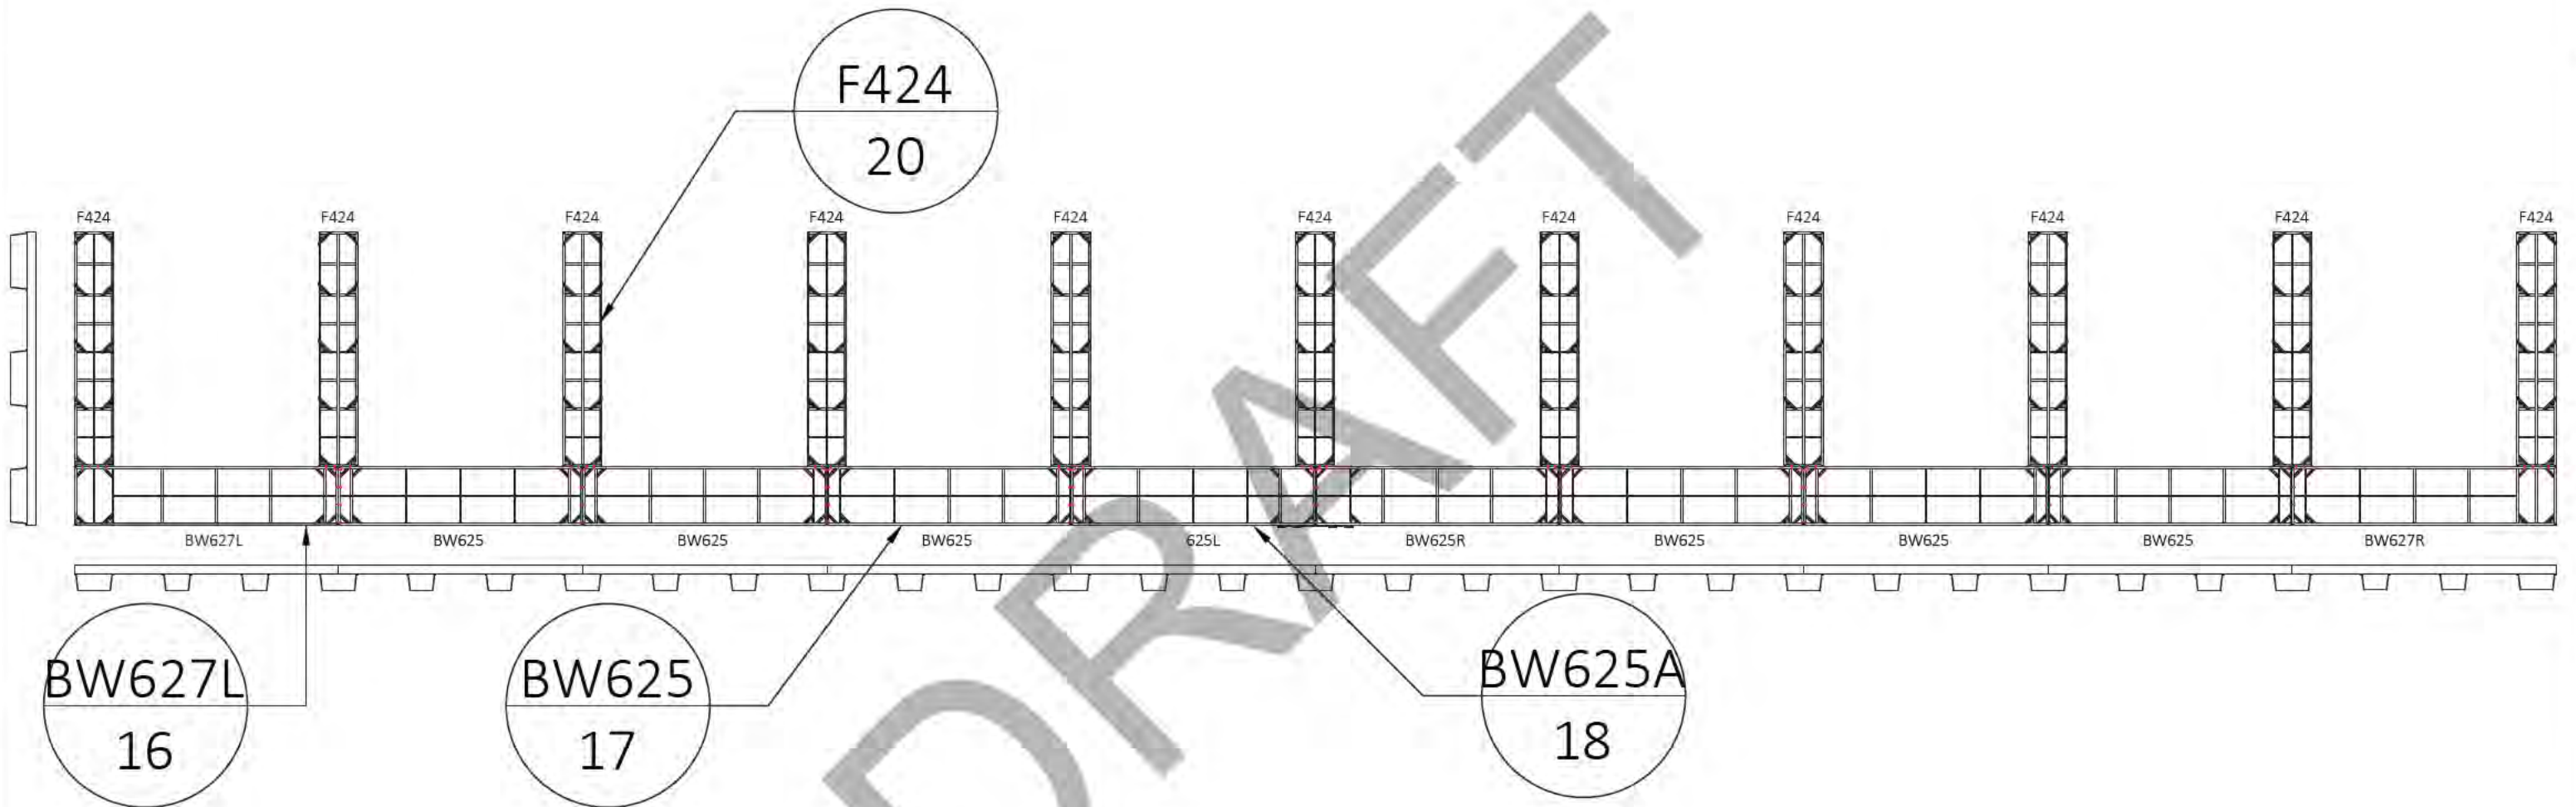

SHEET INFORMATION SHEET NO. 13 OF 42 DWG NO. 13 OF 42	--SHEET DETAIL--			SHORES AT THE PENINSULA.dwg			
	FILE NAME/CUSTOMER ➔						
	DRAWN: 6/1/2023			FRAME DIAGRAM			
	CHECKED:						
	MANAG.APPR:						
	ISSUED TO: MANUFACTURE						
	DESIGN DRAFTER: R.BAKER			SIZE	SCALE	DWG TYPE/NO.	REV
	FABRICATOR:			B	1:180		0
					SHEET	13 OF 42	

D

D

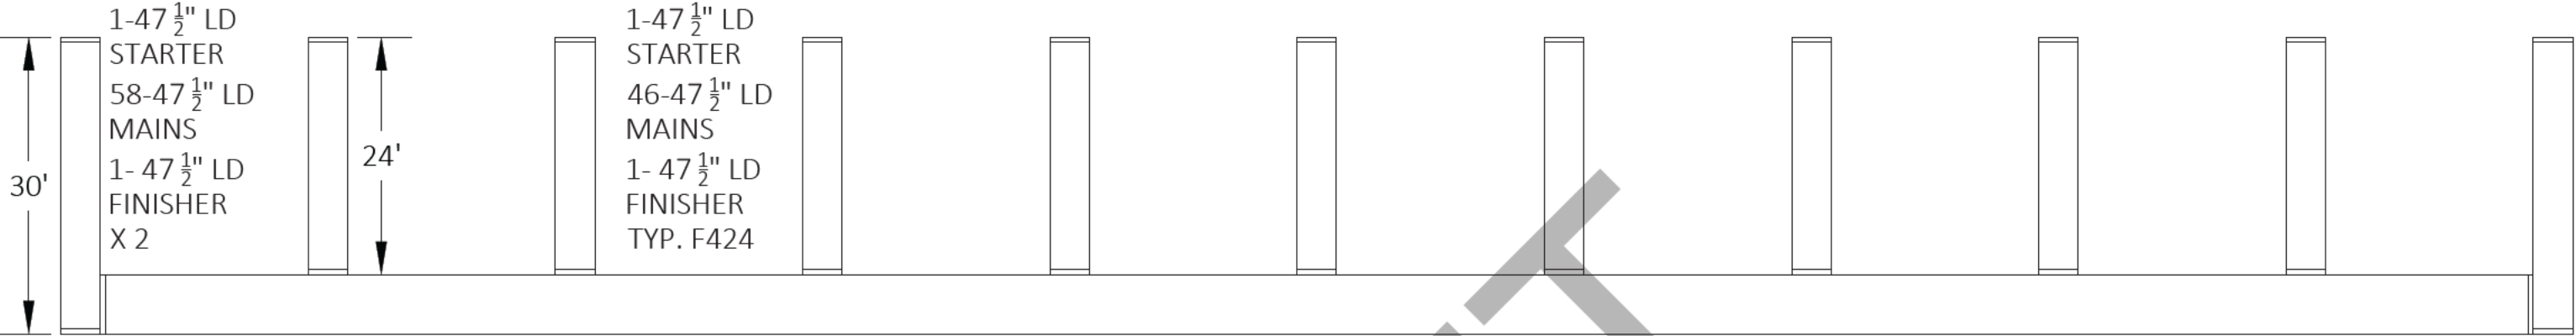

C

C

1-5' 11 1/2" LD STARTER
490-5' 11 1/2" LD MAINS
1- 5' 11 1/2" LD FIN SHER

B

B

DECKING CUT LIST		
QTY.	DESCRIPTION	COLOR
530	47-1/2" LOCKDRY MAINS	
490	5' 11-1/2" LOCKDRY MAINS	
11	47-1/2" LOCKDRY STARTER	
1	5' 11-1/2" LOCKDRY STARTER	
11	47-1/2" LOCKDRY FINISHER	
1	5' 11-1/2" LOCKDRY FINISHER	


A

A

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--SHEET DETAIL--				
FILE NAME/CUSTOMER	➔ SHORES AT THE PENINSULA.dwg			
DRAWN: 6/1/2023	DECKING DIAGRAM			
CHECKED:				
MANAG.APPR:				
ISSUED TO: MANUFACTURE				
DESIGN DRAFTER: R.BAKER				
FABRICATOR:	SIZE B	SCALE 1:180	DWG TYPE/NO.	REV 0
				SHEET 14 OF 42

CUT/STOCK LIST						
DIE NUMBER	ITEM	QTY.	DESCRIPTION	FT.	IN.	TOTAL FT.
FH-07803	A	44	4"X4" POST	10	2	447.3333
FH-07803	B	22	4"X4" POST	10	8-1/16	234.7813
FH-07803	C	22	4"X4" POST	11	2-3/16	246.0104
FH-07803	D	22	4"X4" POST	11	2 3/8	246.3542
FH-07803	E	22	4"X4" POST	10	8 1/4	235.1250



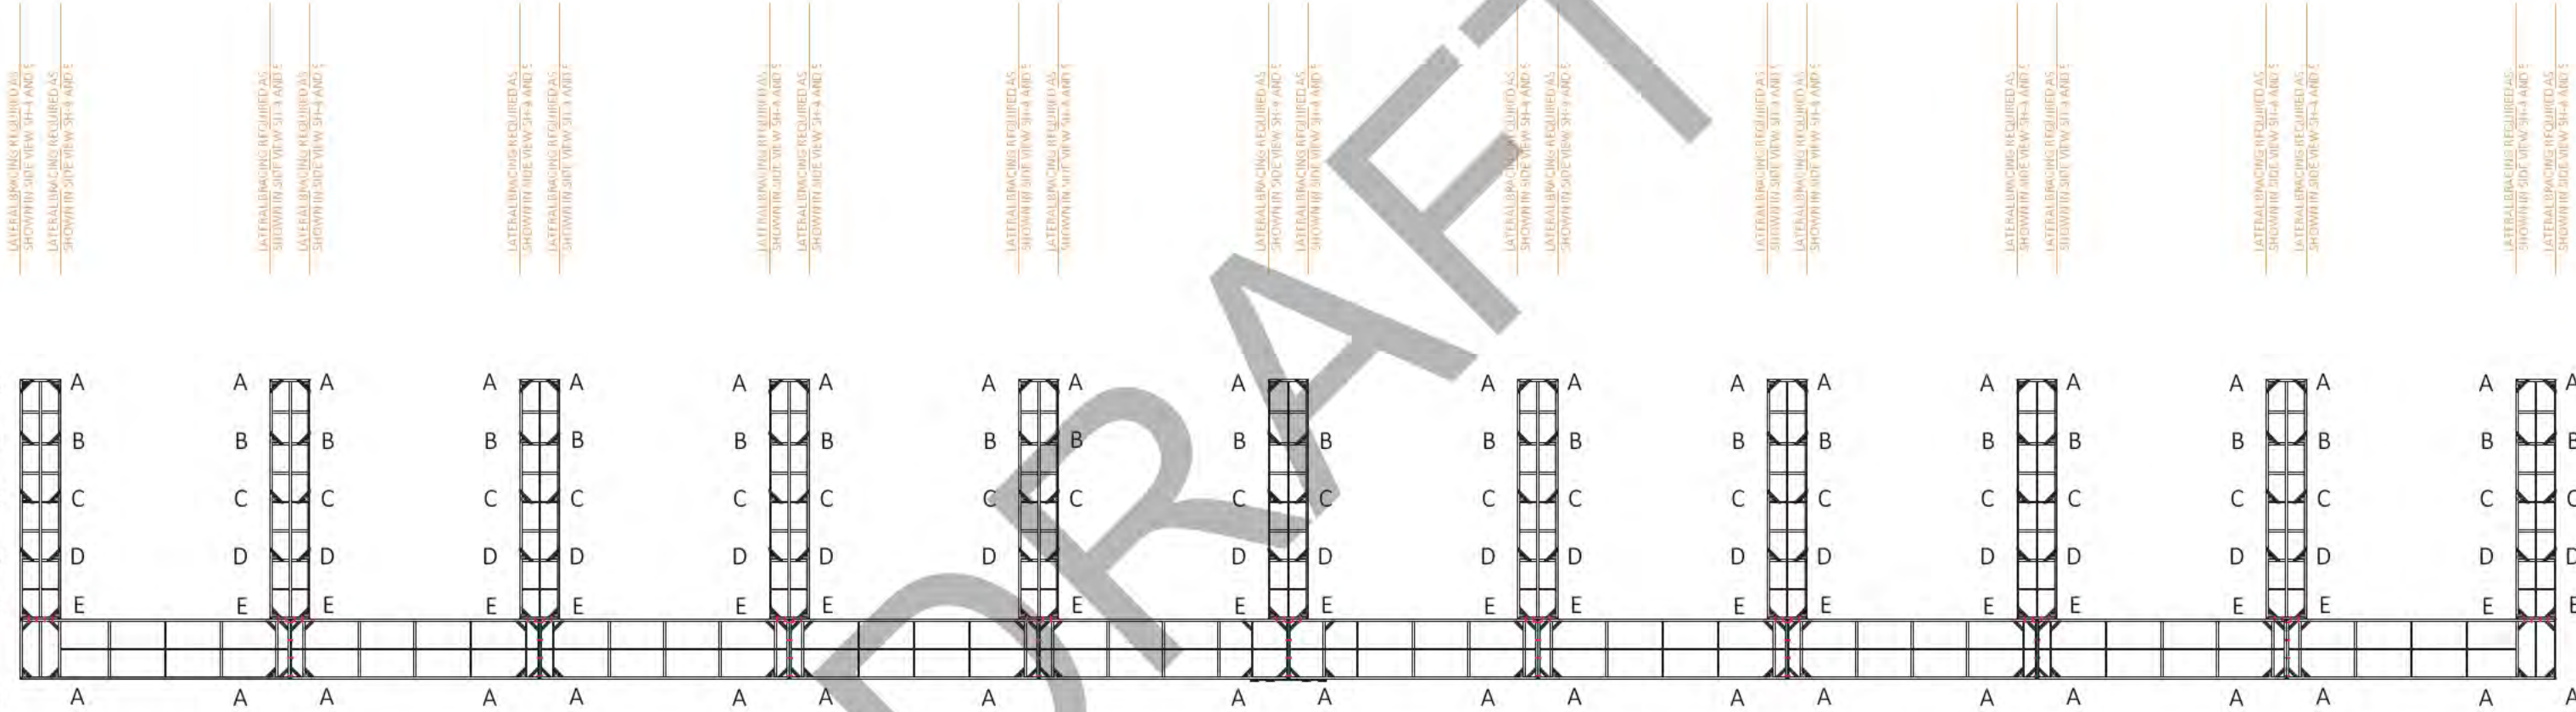


SHEET INFORMATION LOGS 1000 BM 10	--SHEET DETAIL--		SHORES AT THE PENINSULA.dwg			
	FILE NAME/CUSTOMER ➔					
	DRAWN: 6/1/2023		POST DIAGRAM			
	CHECKED:					
	MANAG.APPR:					
	ISSUED TO: MANUFACTURE					
	DESIGN DRAFTER: R.BAKER					
	FABRICATOR:		SIZE B	SCALE 1:180	DWG TYPE/NO.	REV 0
				SHEET 15 OF 42		

CUT LIST							
DIE NUMBER	ITEM	QTY.	DESCRIPTION	DEGREE	FT	IN	TOTAL FT
FS-084499	A	2	10" H.W.	45°-45°	27	0"	54.000000
FS-084499	B	2	10" H.W.	45°-45°	6	0"	12.000000
FS-084499	C	1	10" H.W.	0°-0°	5	7 1/2"	#####
FS-04306	D	4	8" L.W.	0°-0°	5	7 1/2"	#####
FH-07805	E	3	CORNER SLEEVE	0°-0°		10"	2.500000
FH-00487	F	16	1"X2" GUSSET	45°-45°	1	9 13/16"	#####
FH-01356	G	1	1/8" X 2" X 2" TUBE	0°-0°	22	9 3/4"	#####
FH-01356	H	1	1/8" X 2" X 2" TUBE	0°-0°	5	7 1/2"	#####
FS-04774	I	6	2" X 2" ANGLE	0°-0°		2"	1.000000

NOTE:
.375" X 5 1/2" BOLTS WILL BE USED TO ATTACH
LEFT AND RIGHT BACKWALKS TOGETHER AND
FINGERS TO THE BACKWALK

NOTE:
USE .375 WELD OF APPROPRIATE TYPE PER
SHOP STANDARD (TYP.) OR AS NOTED

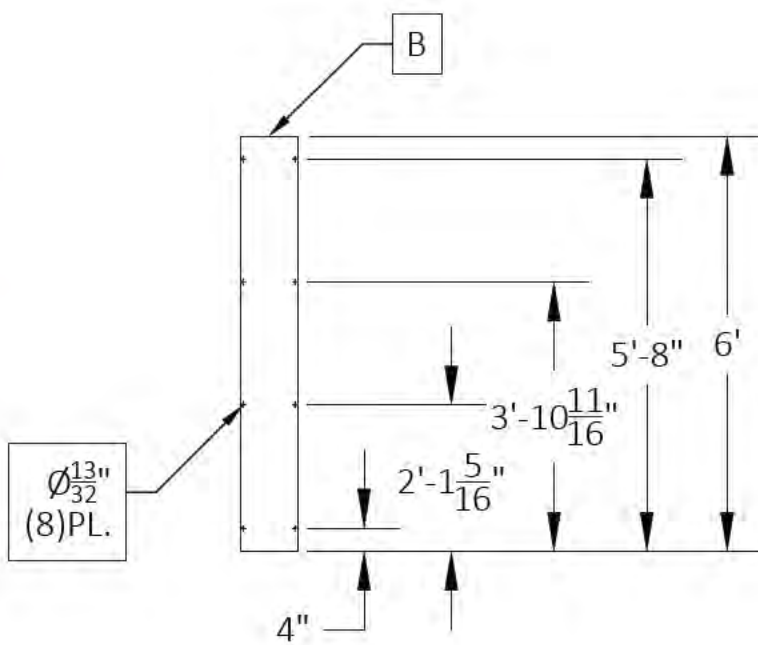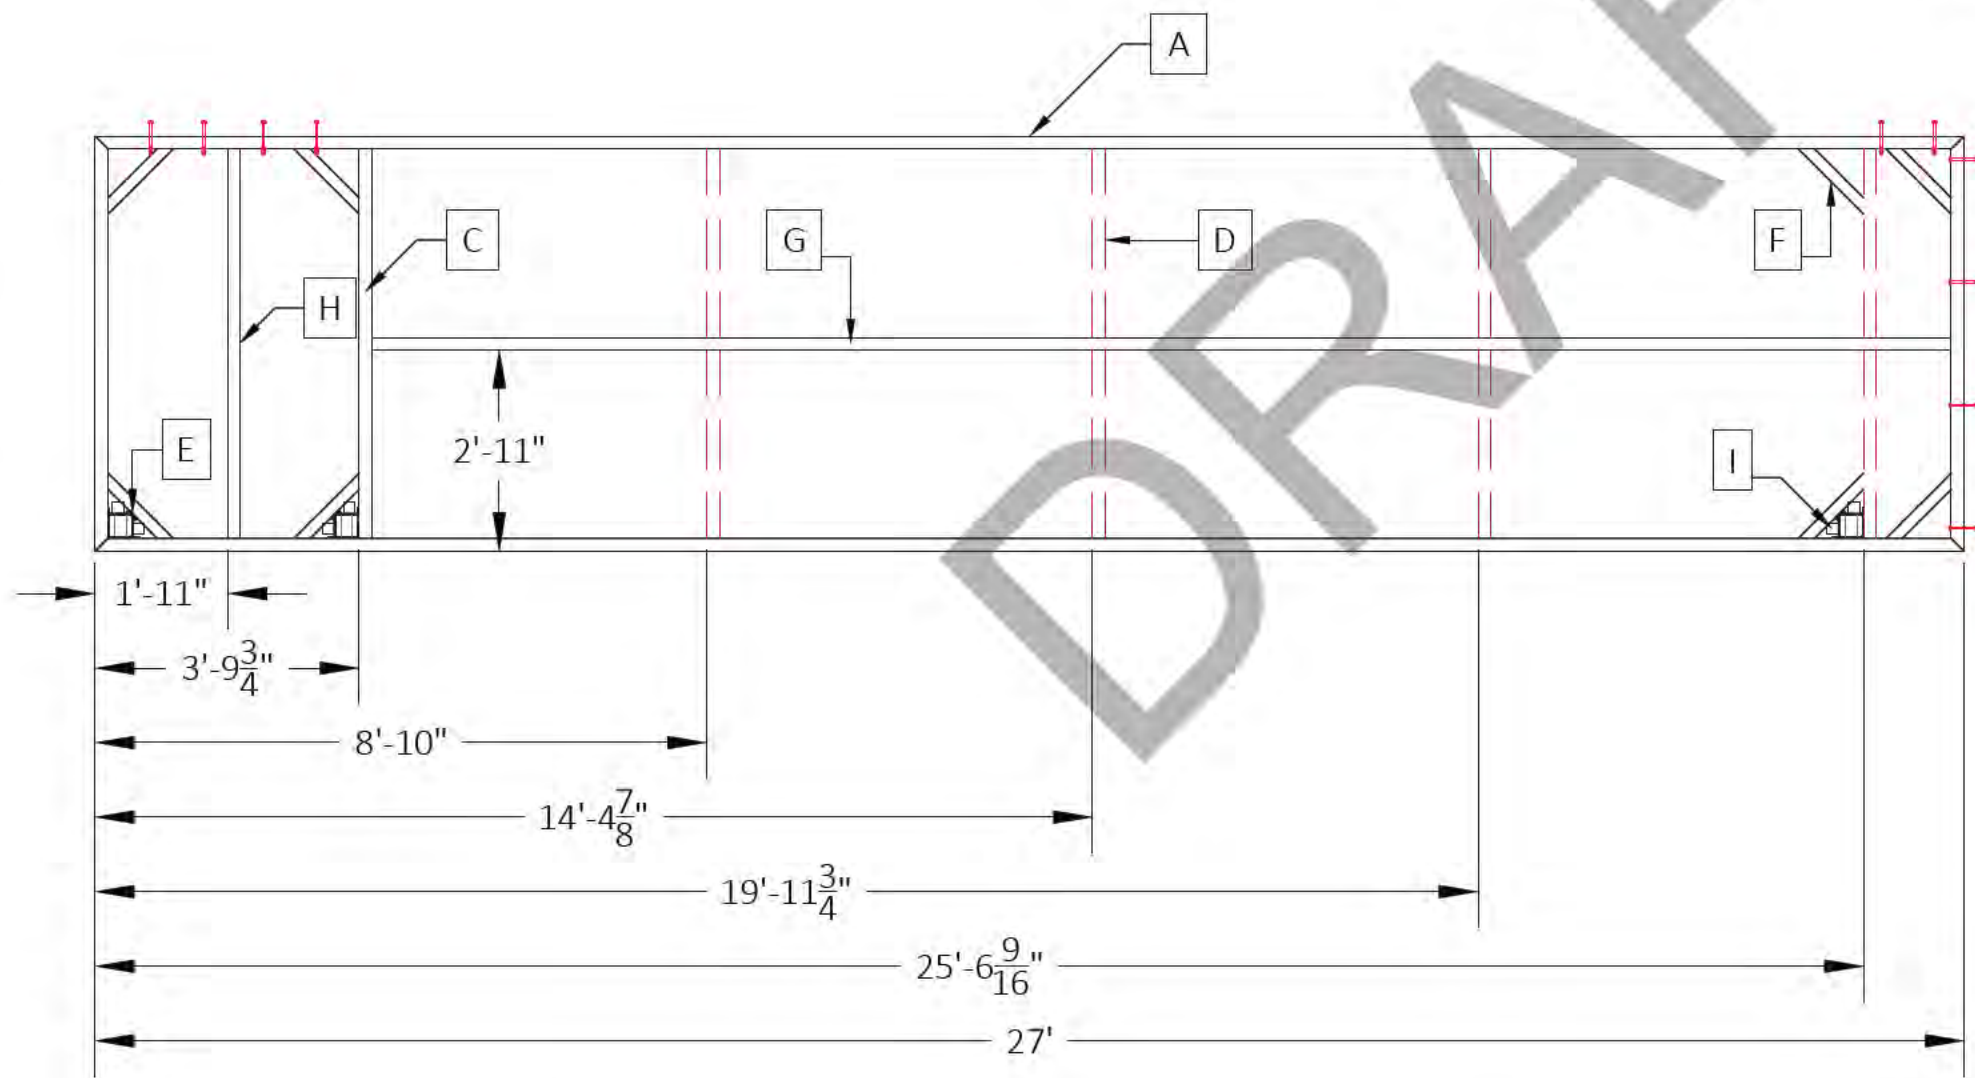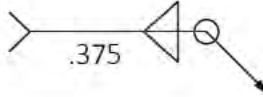




BW627L
(1)REQUIRED

DWG: 162001 (SHEET) 162001.dwg	-SHEET DETAIL-		SHORES AT THE PENINSULA.dwg			
	FILE NAME/CUSTOMER ➔					
	DRAWN: 6/1/2023		BW627L			
	CHECKED:					
	MANAG.APPR:					
	ISSUED TO: MANUFACTURE					
	DESIGN DRAFTER: R.BAKER		SIZE	SCALE	DWG TYPE/NO.	REV
	FABRICATOR:		B	1:34		0
				SHEET	16 OF 42	

CUT LIST							
DIE NUMBER	ITEM	QTY	DESCRIPTION	DEGREE	FT	IN	TOTAL FT
FS-084499	A	2	10" H.W.	45°-45°	25	0"	50.000000
FS-084499	B	2	10" H.W.	45°-45°	6	0"	12.000000
FS-04306	C	5	8" L.W.	0°-0°	5	7 1/2"	#####
FH-07805	D	2	CORNER SLEEVE	0°-0°		10"	1.666667
FH-00487	E	16	1"X2" GUSSET	45°-45°	1	9 13/16"	#####
FH-01356	F	1	1/8" X 2" X 2" TUBE	0°-0°	24	7 1/2"	#####
FS-04774	G	6	2" X 2" ANGLE	0°-0°		2"	1.000000

NOTE:
.375" X 5 1/2" BOLTS WILL BE USED TO ATTACH
LEFT AND RIGHT BACKWALKS TOGETHER AND
FINGERS TO THE BACKWALK

NOTE:
USE .375 WELD OF APPROPRIATE TYPE PER
SHOP STANDARD (TYP.) OR AS NOTED

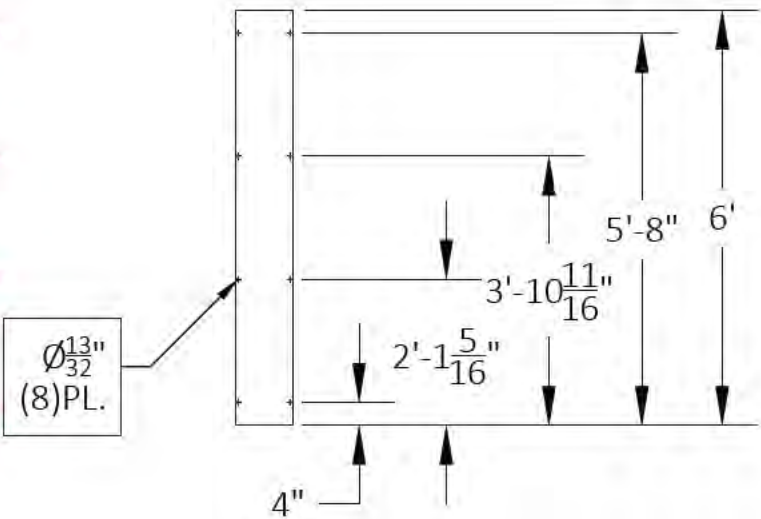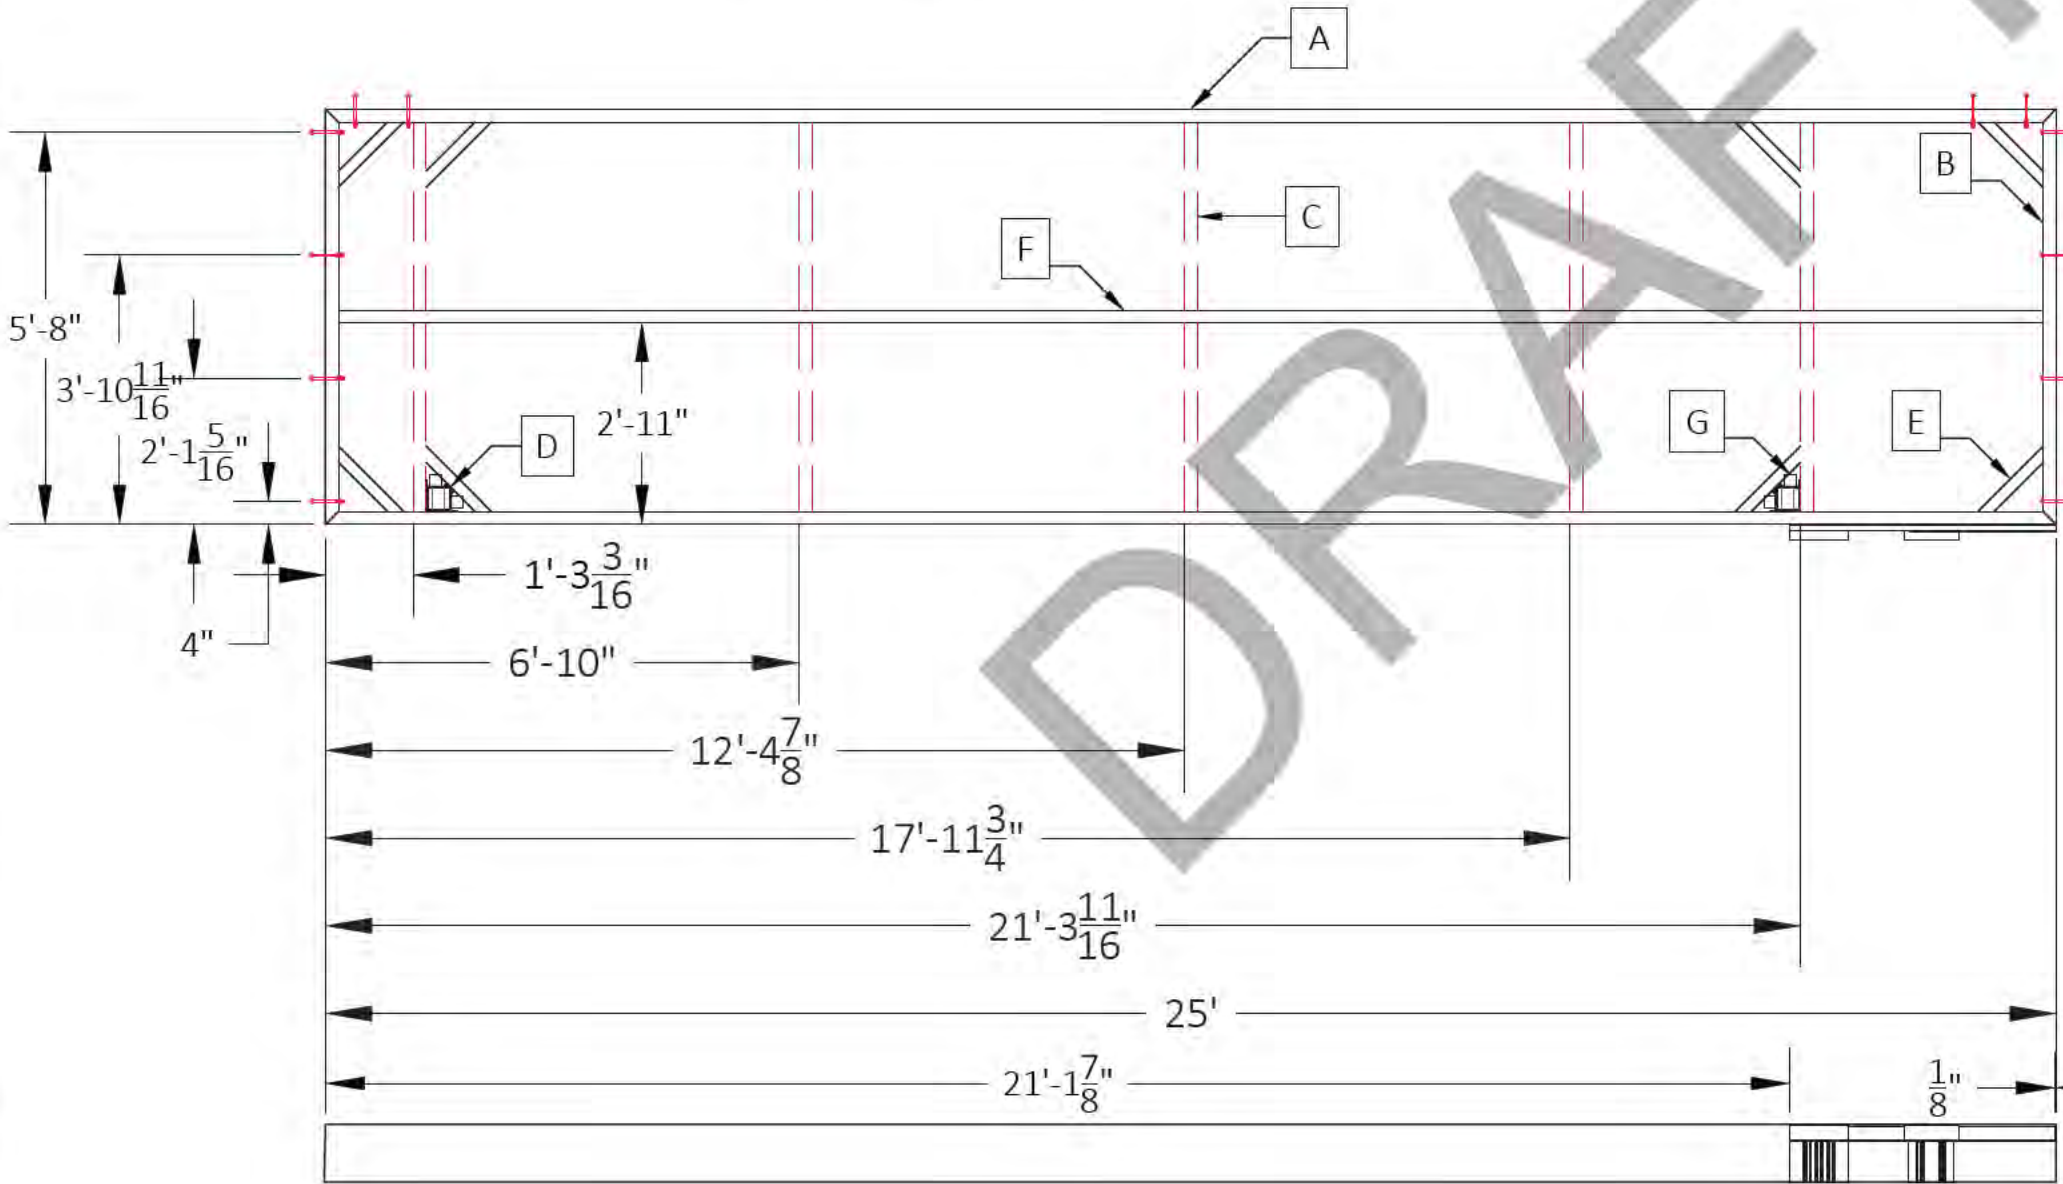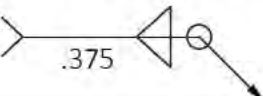

BW625L

(1)REQUIRED


DWG NAME: SHORES AT THE PENINSULA.dwg	--SHEET DETAIL--		SHORES AT THE PENINSULA.dwg			
	FILE NAME/CUSTOMER ➔					
	DRAWN: 6/1/2023		BW625L			
	CHECKED:					
	MANAG.APPR:					
	ISSUED TO: MANUFACTURE					
	DESIGN DRAFTER: R.BAKER		SIZE	SCALE	DWG TYPE/NO.	REV
	FABRICATOR:		B	1:34		0
				SHEET	18 OF 42	

CUT LIST							
DIE NUMBER	ITEM	QTY.	DESCRIPTION	DEGREE	FT	IN	TOTAL FT
FH-07812	A	2	RAMP PIPE	0°-0°		10"	1.67
FH-07812	B	2	RAMP PIPE	0°-0°		9 9/16"	####
FS-07813	C	1	PAMP TRACK	0°-0°	3	10"	3.83
FS-08499	D	2	10" H.W.	0°-0°		7"	1.17
FS-00431	E	2	8" H.W.	0°-0°		7"	1.17

*MEASUREMENTS MUST BE EXACT!



WELD THE RAMP
TRACK TO THE FRAME!!

NOTE:
USE .375 WELD OF APPROPRIATE TYPE PER
SHOP STANDARD (TYP.) OR AS NOTED

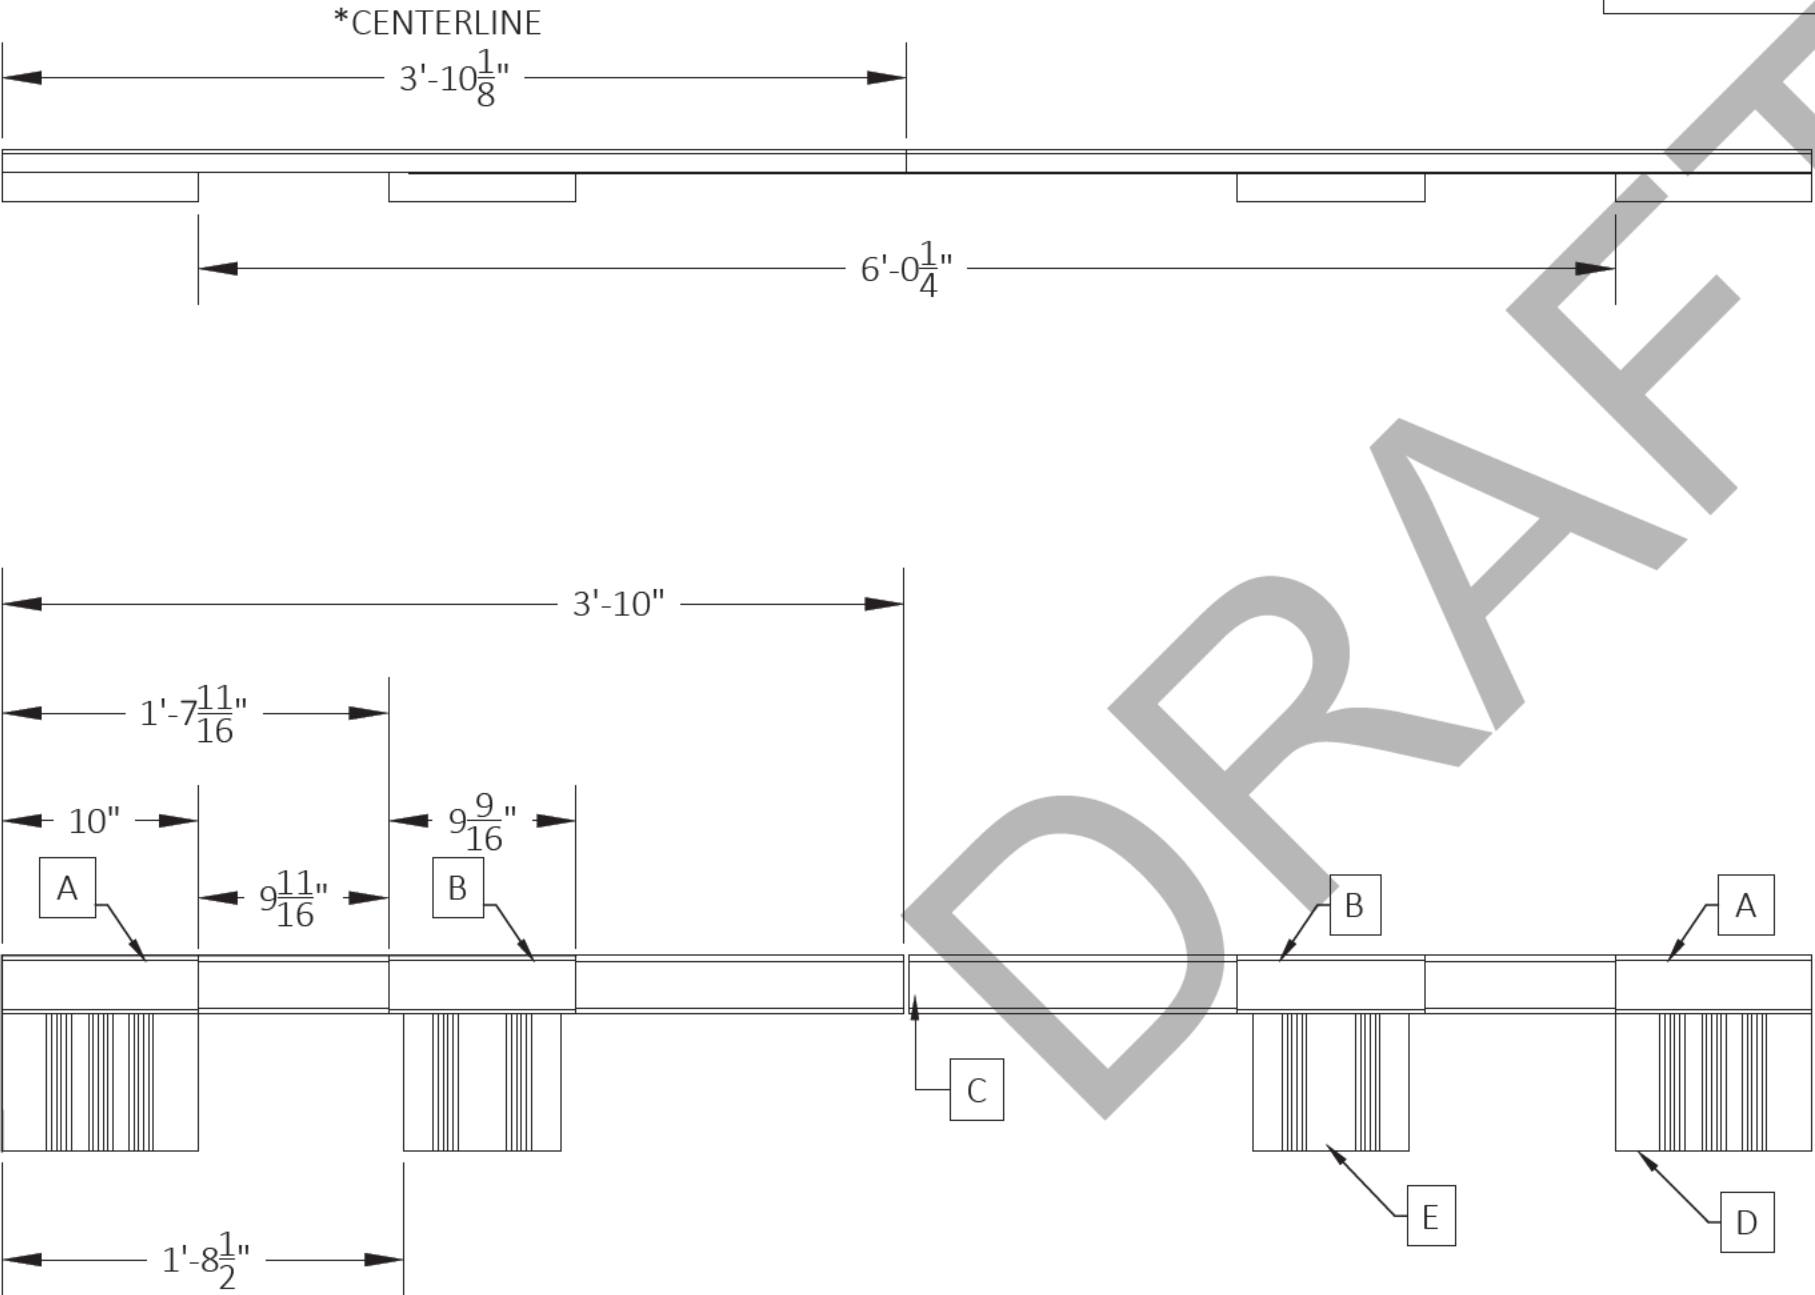

SHEET INFORMATION LOGO BLM .PS	-SHEET DETAIL-		SHORES AT THE PENINSULA.dwg				
	FILE NAME/CUSTOMER ➔						
	DRAWN: 6/1/2023		RA-1				
	CHECKED:						
	MANAG.APPR:						
	ISSUED TO: MANUFACTURE						
	DESIGN DRAFTER: R.BAKER						SIZE
	FABRICATOR:		B	1:10			0
				SHEET 19 OF 42			

CUT/STOCK LIST							
DIE NUMBER	ITEM	QTY.	DESCRIPTION	DEGREE	FT.	IN.	TOTAL FT.
FS-084499	A	2	10" H.W.	45°-45°	24	0"	48.00
FS-084499	B	2	10" H.W.	45°-45°	4	0"	8.00
FS-04306	C	7	8" L.W.	0°-0°	3	7 1/2"	####
FH-07805	D	10	CORNER SLEEVE	0°-0°		10"	8.33
FH-00487	E	20	1"X2" GUSSET	45°-45°	1	9 13/16"	####
FH-01356	F	1	1/8" X 2" X 2" TUBE	0°-0°	23	7 1/2"	####
FS-04774	G	20	2" X 2" ANGLE	0°-0°		2"	3.33

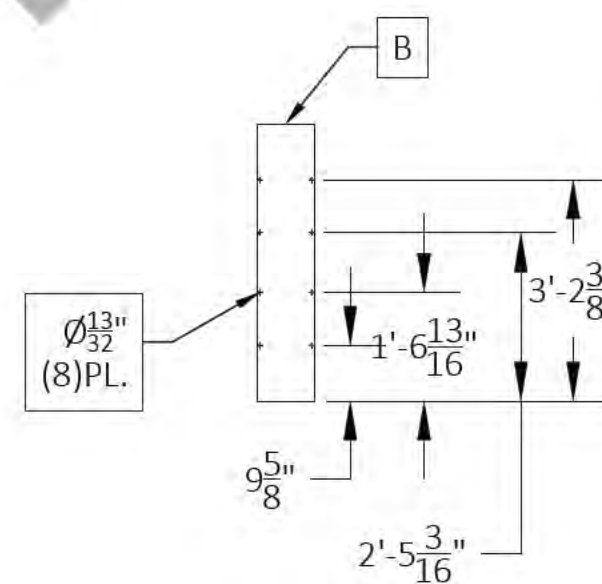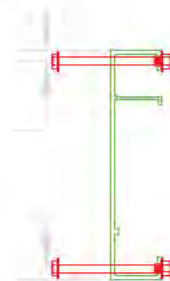

(11)REQUIRED

D:\P\dwg\10-60458.DWG

--SHEET DETAIL--					
FILE NAME/CUSTOMER ➔		SHORES AT THE PENINSULA.dwg			
DRAWN: 6/1/2023		F424			
CHECKED:					
MANAG.APPR:					
ISSUED TO: MANUFACTURE					
DESIGN DRAFTER: R.BAKER		SIZE B	SCALE 1:34	DWG TYPE/NO.	REV 0
FABRICATOR:				SHEET 20 OF 42	

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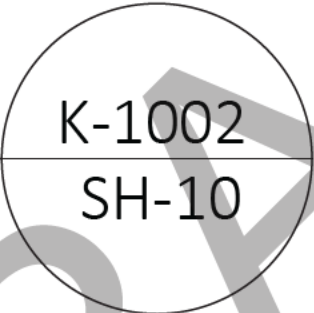
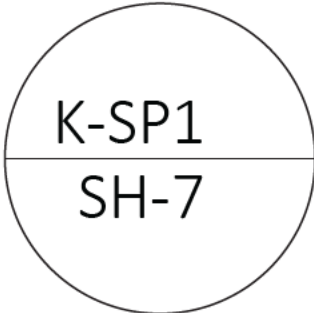
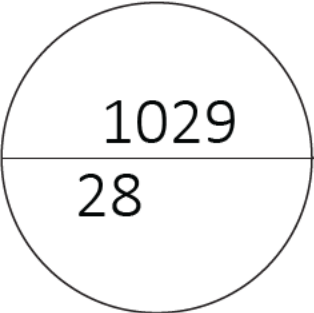
C

B


B

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INSERT STUB-UP MATERIAL AS SHOWN
IN POST TO WHICH SPUD POLE
SLEEVES ATTACH. FASTEN USING
A DRILLET TO HOLD IN PLACE
DURING INSTALLATION.
SEE SH-3C FOR SLEEVE LOCATION



DRILLET LOCATION

FLUSH WITH THE
BOTTOM OF THE POST

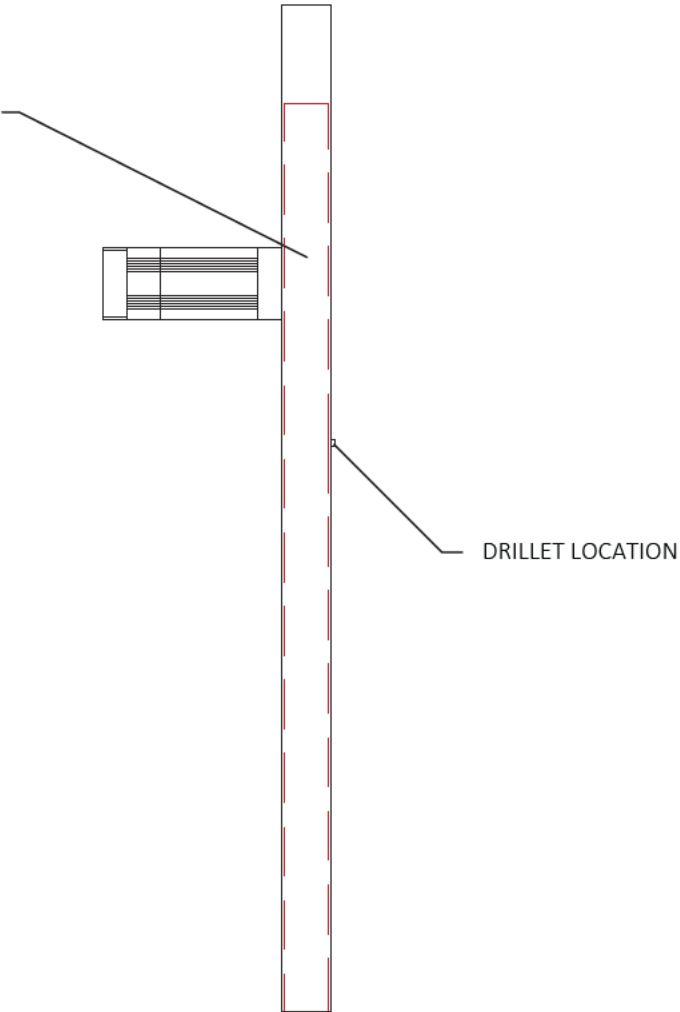K-SP1 ASSEMBLIES ARE TO BE BOLTED
TO THE FRAMES AND POST AT THE
SPECIFICALLY MARKED PLACES.

D:\P\penins\LOGO\BLM.JPG

--SHEET DETAIL	
FILE NAME/CUSTOMER ➔	
DRAWN: 6/1/2023	
CHECKED:	
MANAG.APPR:	
ISSUED TO: MANUFACTURE	
DESIGN DRAFTER: R.BAKER	
FABRICATOR:	

SIZE	SCALE	DWG TYPE/NO.	REV
B	1:36		0
			SHEET 21 OF 42

SHORES AT THE PENINSULA.dwg

8' COLLAR SIDE VIEW

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INSERT STUB-UP MATERIAL AS SHOWN
IN POST TO WHICH SPUD POLE
SLEEVES ATTACH. FASTEN USING
A DRILLET TO HOLD IN PLACE
DURING INSTALLATION.
SEE SH-3C FOR SLEEVE LOCATION

FLUSH WITH THE
BOTTOM OF THE POST

K-SP1 ASSEMBLIES ARE TO BE BOLTED
TO THE FRAMES AND POST AT THE
SPECIFICALLY MARKED PLACES.

D:\Programs\Autodesk\AutoCAD 2010\AutoCAD 2010.dwg	--SHEET DETAIL--			SHORES AT THE PENINSULA.dwg			
	FILE NAME/CUSTOMER ➔						
	DRAWN: 6/1/2023			8' COLLAR FRONT VIEW			
	CHECKED:						
	MANAG.APPR:						
	ISSUED TO: MANUFACTURE						
	DESIGN DRAFTER: R.BAKER			SIZE B	SCALE 1:36	DWG TYPE/NO.	REV 0
	FABRICATOR:			SHEET 22 OF 42			

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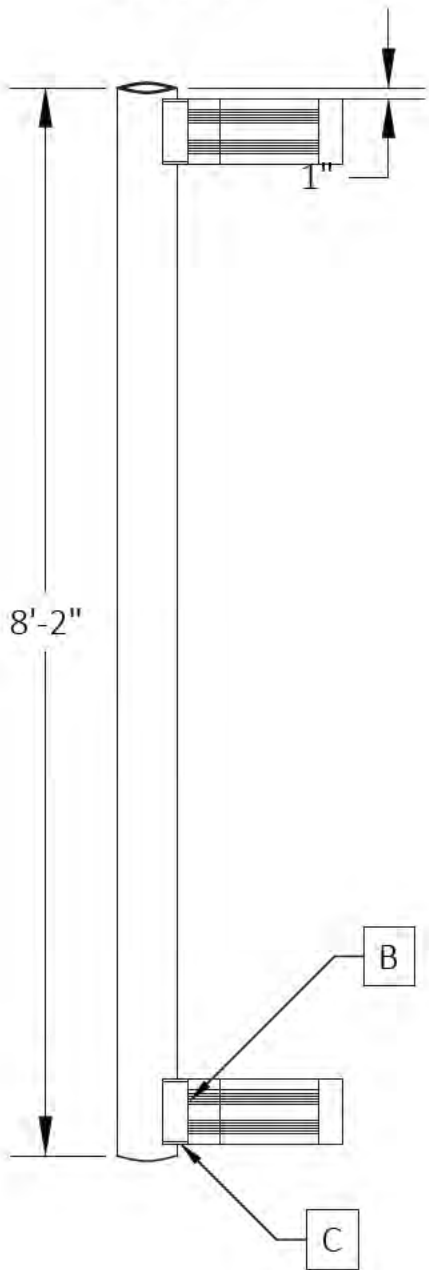
K-SP1 ASSEMBLIES ARE TO BE BOLTED
TO THE FRAMES AND POST AT THE
SPECIFICALLY MARKED PLACES.

K-SP1
24


INSERT STUB-UP MATERIAL AS SHOWN
IN POST TO WHICH SPUD POLE
SLEEVES ATTACH. FASTEN USING
A DRILLET TO HOLD IN PLACE
DURING INSTALLATION.
SEE SH-3C FOR SLEEVE LOCATION

D:\Virtual\LOCALIZATION\LOCAL.dwg	-SHEET DETAIL-			SHORES AT THE PENINSULA.dwg			
	FILE NAME/CUSTOMER ➔						
	DRAWN: 6/1/2023			8' COLLAR TOP VIEW			
	CHECKED:						
	MANAG.APPR:						
	ISSUED TO: MANUFACTURE						
	DESIGN DRAFTER: R.BAKER			SIZE	SCALE	DWG TYPE/NO.	REV
	FABRICATOR:			B	1:42		0
						SHEET	23 OF 42


SIDE VIEW



7/16" Ø HOLE
8 PL. MATCH
DRILL AT
LOCATION

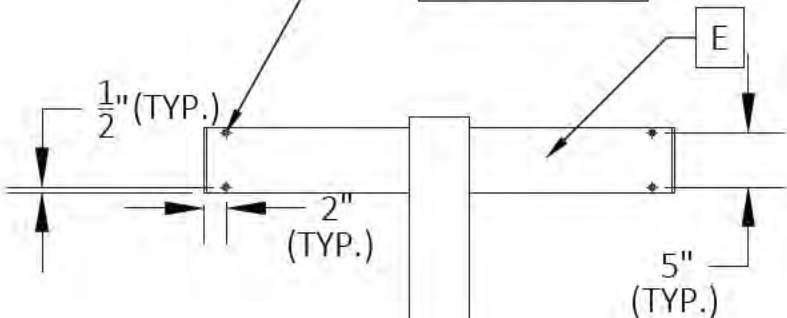

FRONT VIEW

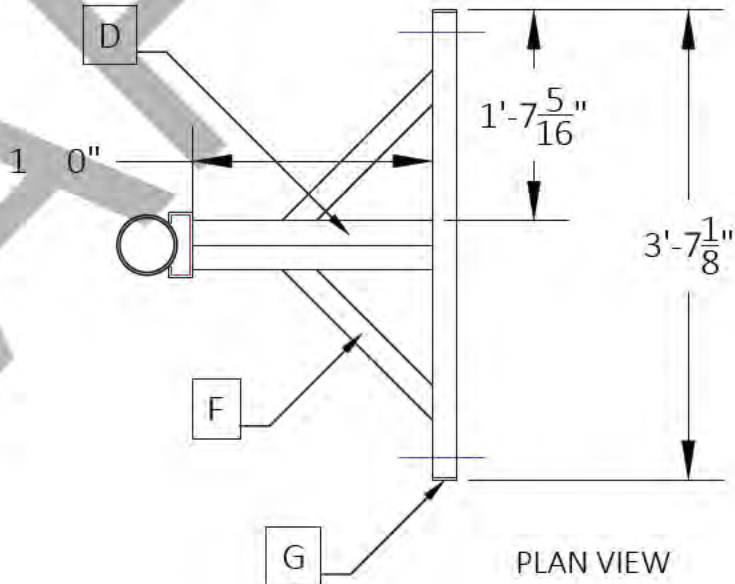

PLAN VIEW

CUT/STOCK LIST

DIE NUMBER	ITEM	QTY.	DESCRIPTION	DEGREE	FT.	IN.	TOTAL FT.
FH-04827	A	1	5" SCH. 40 ALUM PIPE	0°-0°	8	2"	8.17
FS-04739	B	2	6" H.W.	0°-0°		5 1/2"	####
FS-00490	C	4	1/4" X 2 1/4" PRE-CUT PLATE	0°-0°		6"	2.00
FS-04739	D	4	6" H.W.	0°-0°	1	10"	7.33
FS-04739	E	2	6" H.W.	0°-0°	3	6 5/8"	####
FS-04739	F	4	6" H.W.	45°-45°	1	7 1/2"	####
FS-00678	G	4	1/4" X 6" FLAT PLATE	0°-0°		2 1/4"	####



K-SP1 ASSEMBLIES ARE TO BE BOLTED TO THE FRAMES AND POST AT THE SPECIFICALLY MARKED PLACES.

K-SP1

(21)REQUIRED

--SHEET DETAIL--		SHORES AT THE PENINSULA.dwg		
FILE NAME/CUSTOMER		K-SP1		
DRAWN: 6/1/2023				
CHECKED:				
MANAG.APPR:				
ISSUED TO: MANUFACTURE				
DESIGN DRAFTER: R.BAKER		SIZE B	SCALE 1:18	DWG. TYPE/NO. REV 0
FABRICATOR:		SHEET 24 OF 42		

CUT/STOCK LIST							
DIE NUMBER	ITEM	QTY.	DESCRIPTION	DEGREE	FT.	IN.	TOTAL FT.
FH-07908	A	44	4" STUP UP	0°-0°	7	4	322.6667

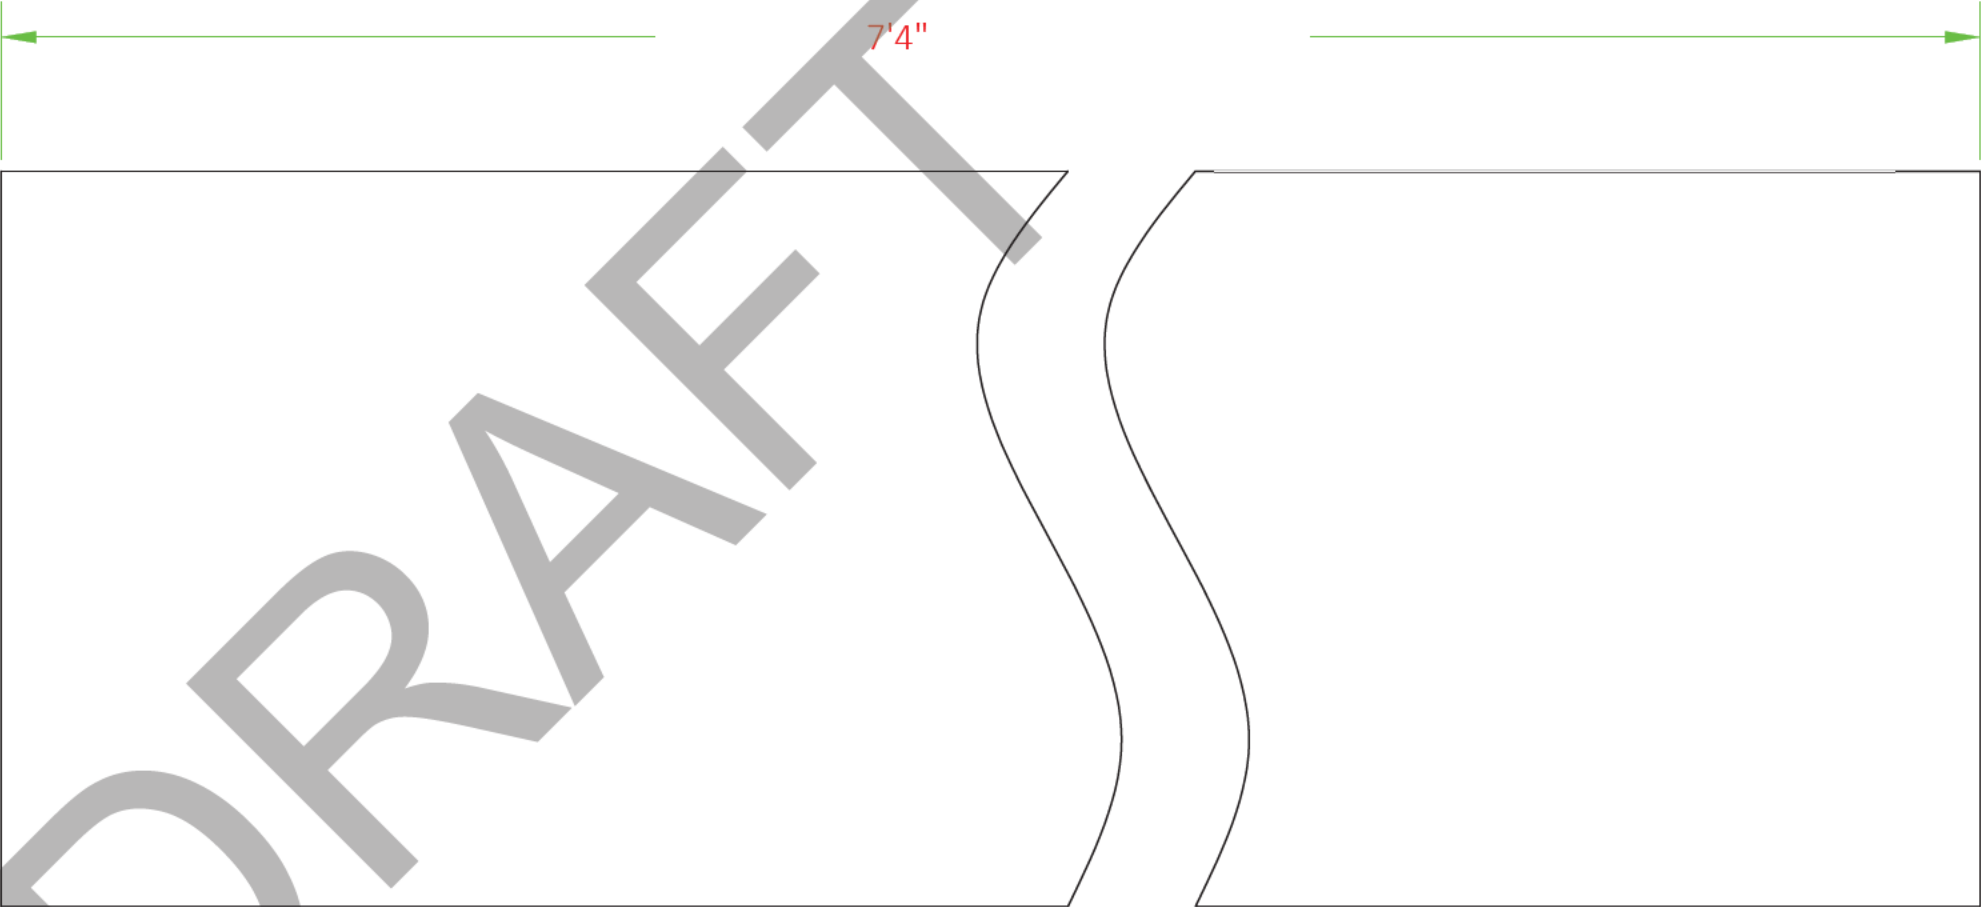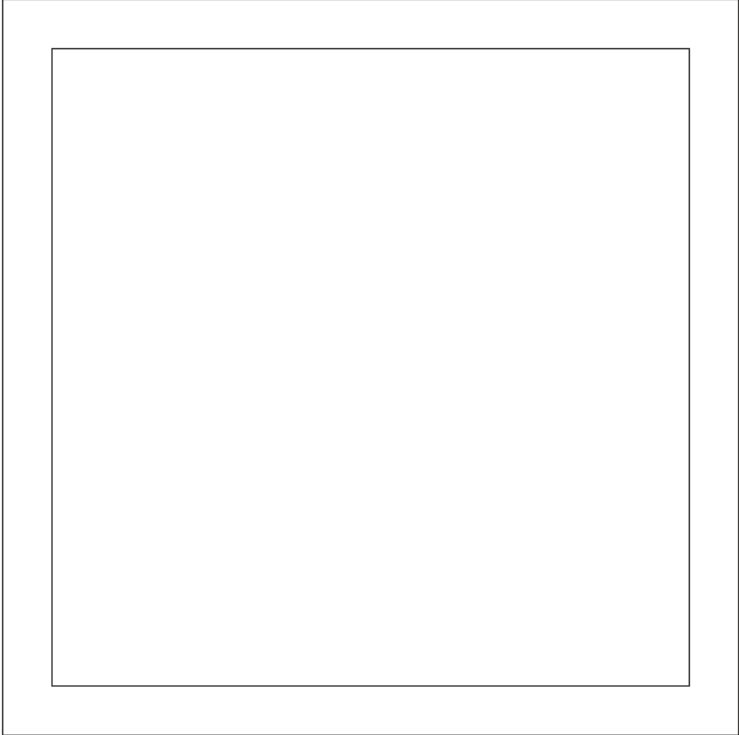

K-1002

D:\Program Files\Autodesk\AutoCAD 2013\AutoCAD 2013.dwg

-SHEET DETAIL-		SHORES AT THE PENINSULA.dwg				
FILE NAME/CUSTOMER ➔						
DRAWN: 6/1/2023		K-1002				
CHECKED:						
MANAG.APPR:						
ISSUED TO: MANUFACTURE						
DESIGN DRAFTER: R.BAKER		SIZE B	SCALE 1:1	DWG TYPE/NO.		REV 0
FABRICATOR:						SHEET 25 OF 42

D

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C


C

B

B





A

A

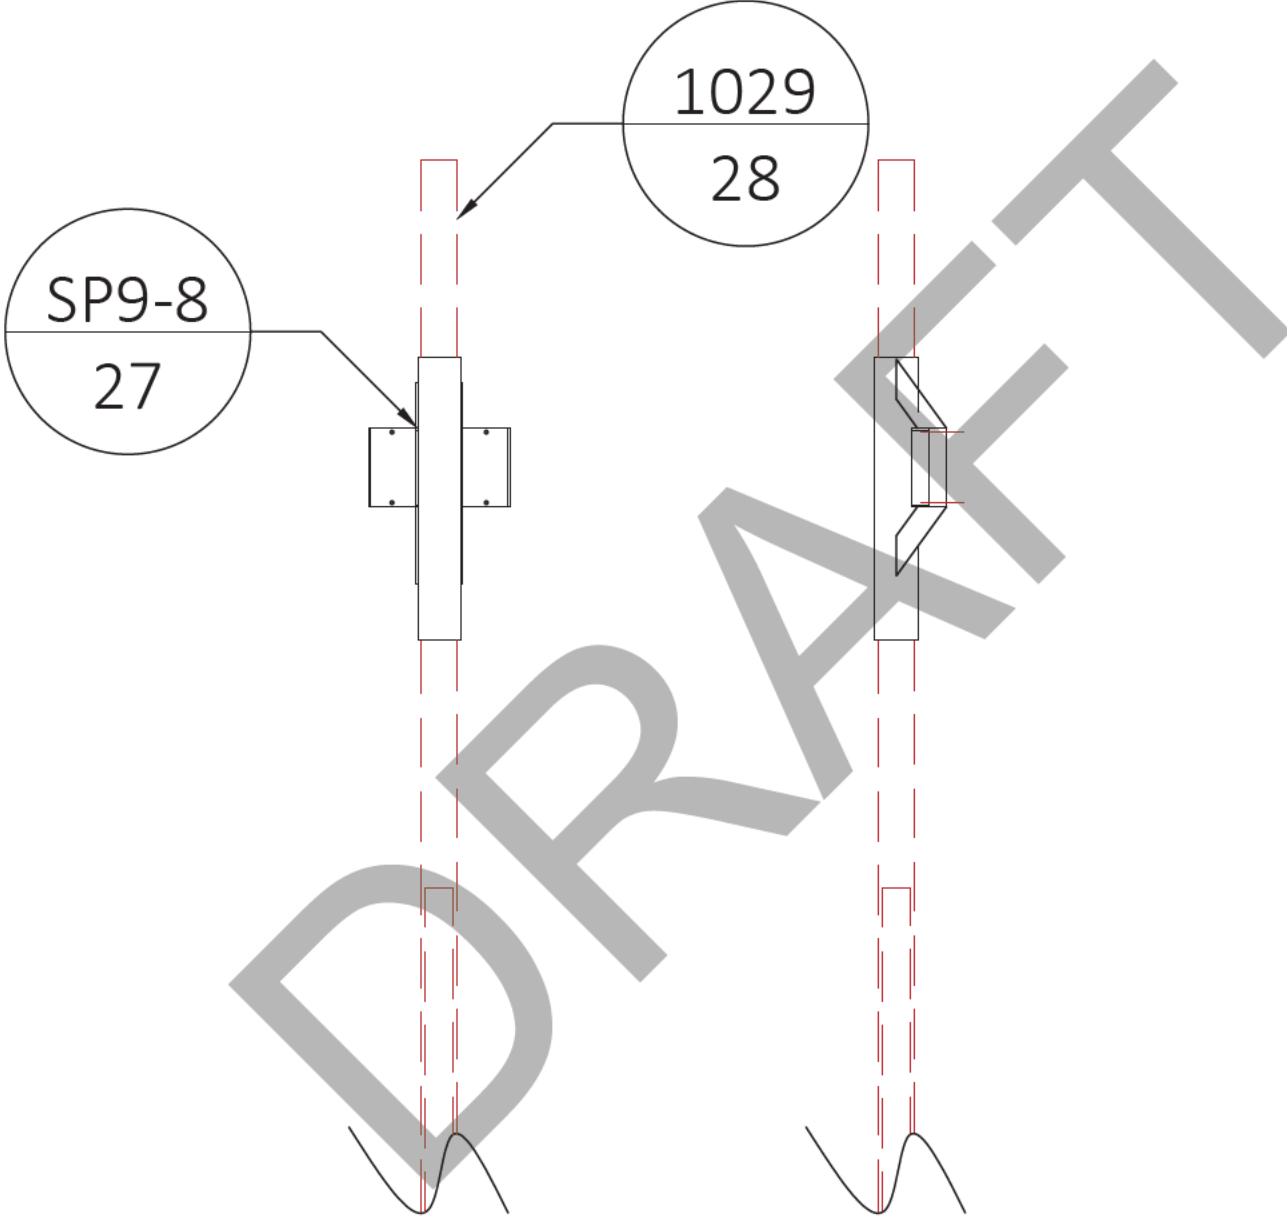

D:\Peninsula\LOGISTICS\LOCATION LOGS\BAY 26	-SHEET DETAIL-		SHORES AT THE PENINSULA.dwg				
	FILE NAME/CUSTOMER ➔						
	DRAWN: 6/1/2023		3' SPUD POLE COLLAR TOP AND SIDE VIEW				
	CHECKED:						
	MANAG.APPR:						
	ISSUED TO: MANUFACTURE						
	DESIGN DRAFTER: R.BAKER		SIZE B	SCALE 1:25	DWG TYPE/NO.		REV 0
	FABRICATOR:						SHEET 26 OF 42

CUT/STOCK LIST							
DIE NUMBER	ITEM	QTY.	DESCRIPTION	DEGREE	FT.	IN.	TOTAL FT.
FH-04827	A	2	5" SCH. 40 ALUM PIPE	0°-0°	3	0	6.00
FS08499	B	2	10" H.W.	0°-0°	1	5 1/2"	####
FS-04739	C	2	6" H.W.	0°-0°		9 1/2"	####
FS-01990	D	4	1/4" X 8" FLATPLATE	0°-0°		2 1/4"	####
FS-00678	E	4	1/4" X6" FLATPLATE	0°-0°		2 1/4"	####
FS-04457	F	8	3/8" X 2 1/4" FLATPLATE	L54°-L36°		10 7/8"	####

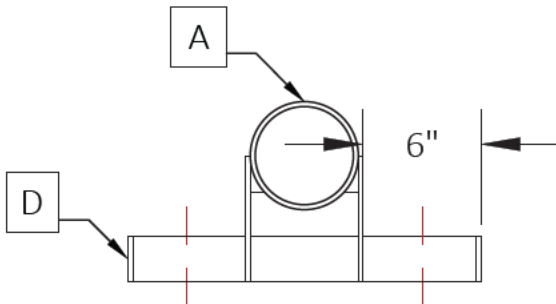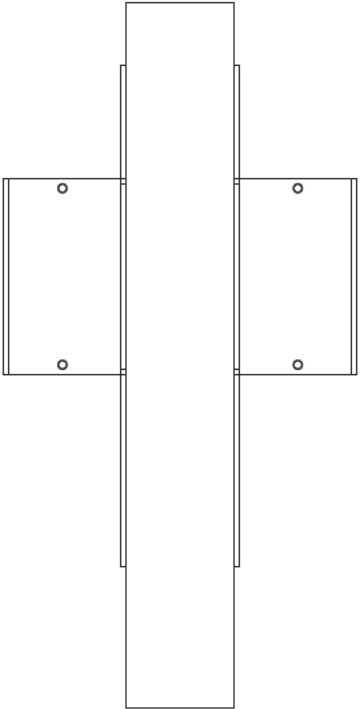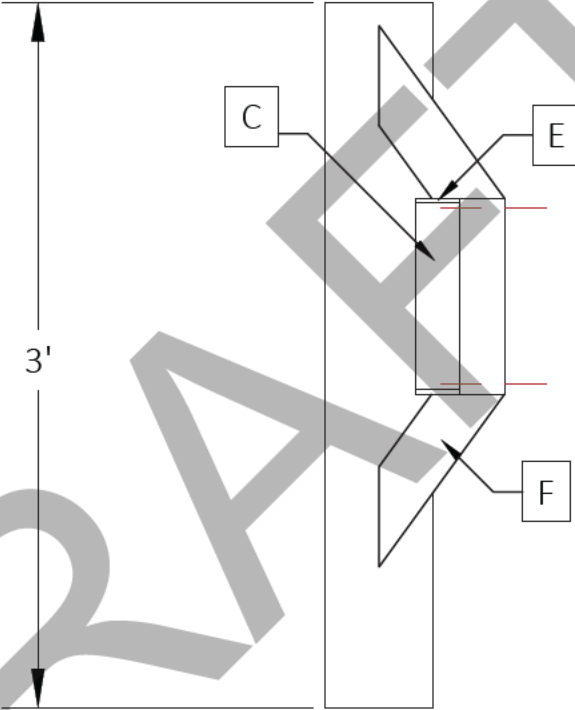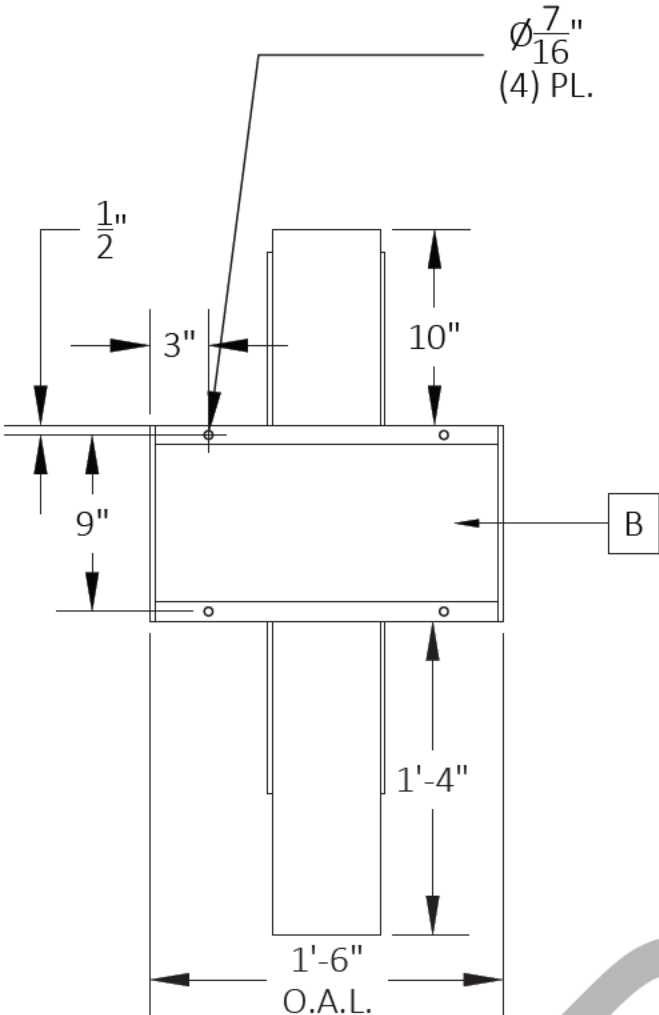

SP9-8

(2)REQUIRED

SHEET INFORMATION LOGO BLM .PS	-SHEET DETAIL-						
	FILE NAME/CUSTOMER ➔		SHORES AT THE PENINSULA.dwg				
	DRAWN: 6/1/2023		SP9-8				
	CHECKED:						
	MANAG.APPR:						
	ISSUED TO: MANUFACTURE						
	DESIGN DRAFTER: R.BAKER		SIZE B	SCALE 1:10	DWG TYPE/NO.		REV 0
	FABRICATOR:						SHEET 27 OF 42

CUT/STOCK LIST							
DIE NUMBER	ITEM	QTY.	DESCRIPTION	DEGREE	FT.	IN.	TOTAL FT.
	A	23	4" SCH 40 X 21' SPUD POLE		21	0	483.0000



1029

D:\Peninsula\LOGISTICS\LOCATION LOGS\BAY 1029.dwg

--SHEET DETAIL--			SHORES AT THE PENINSULA.dwg					
FILE NAME/CUSTOMER ➔								
DRAWN: 6/1/2023								
CHECKED:								
MANAG.APPR:								
ISSUED TO: MANUFACTURE			1029					
DESIGN DRAFTER: R.BAKER		SIZE B				SCALE 1:18	DWG TYPE/NO.	REV 0
FABRICATOR:							SHEET 28 OF 42	

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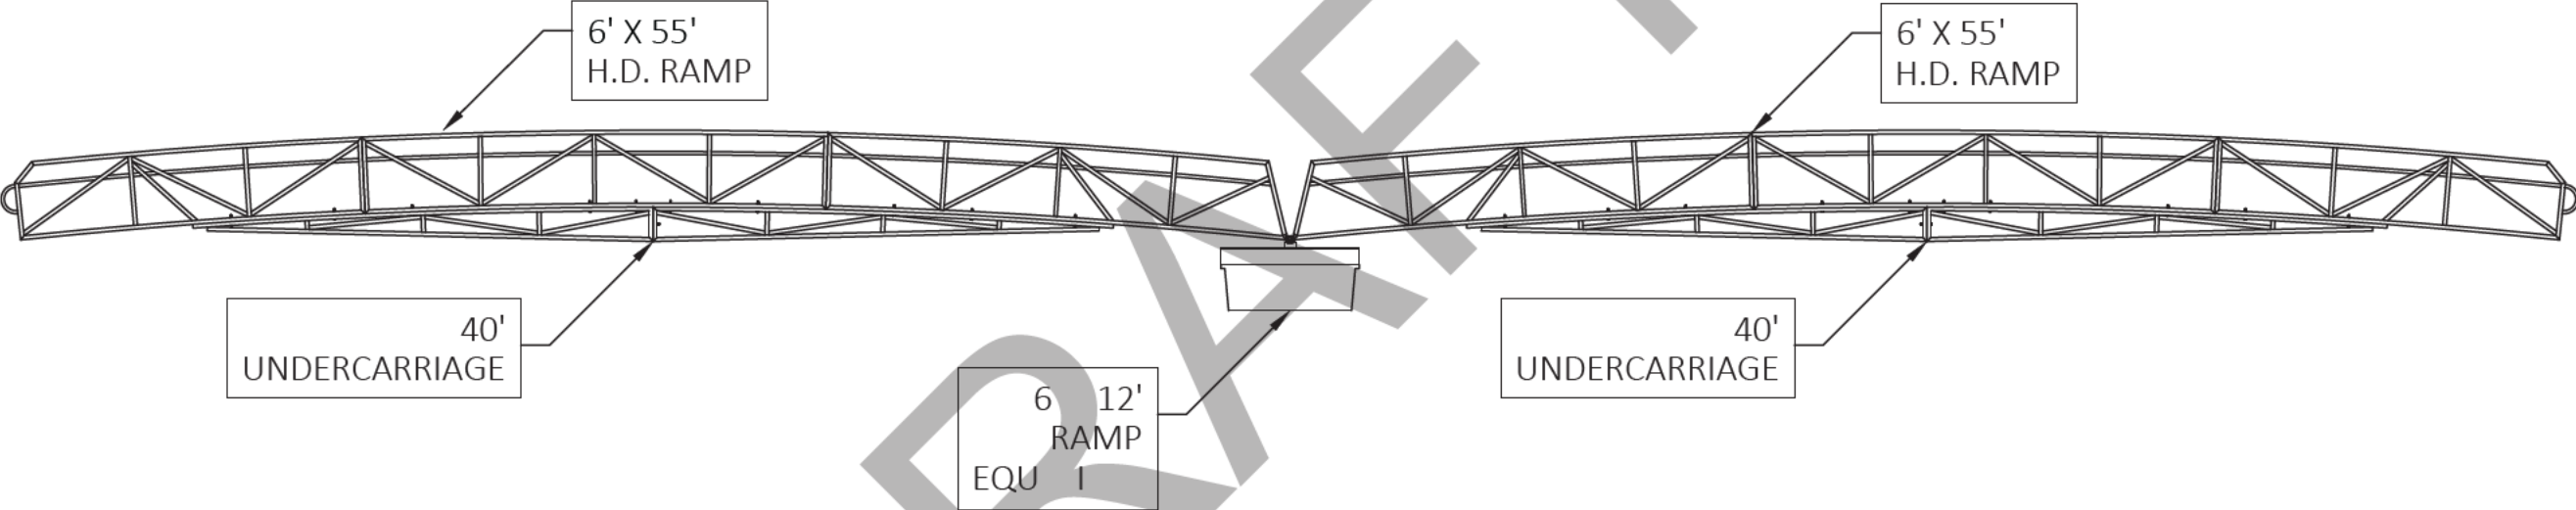
C

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S:\Peninsula\LOGISTICS\LOGISTICS\LOGS\BMP.DWG	-SHEET DETAIL-		SHORES AT THE PENINSULA.dwg			
	FILE NAME/CUSTOMER ➔					
	DRAWN: 6/1/2023		(2) 6' X 55' RAMPS W/ EQUALIZER SIDE VIEW			
	CHECKED:					
	MANAG.APPR:					
	ISSUED TO: MANUFACTURE					
	DESIGN DRAFTER: R.BAKER		SIZE B	SCALE 1:100	DWG TYPE/NO.	REV 0
	FABRICATOR:					SHEET 31 OF 42

D

D

C


C

B

B


A

A

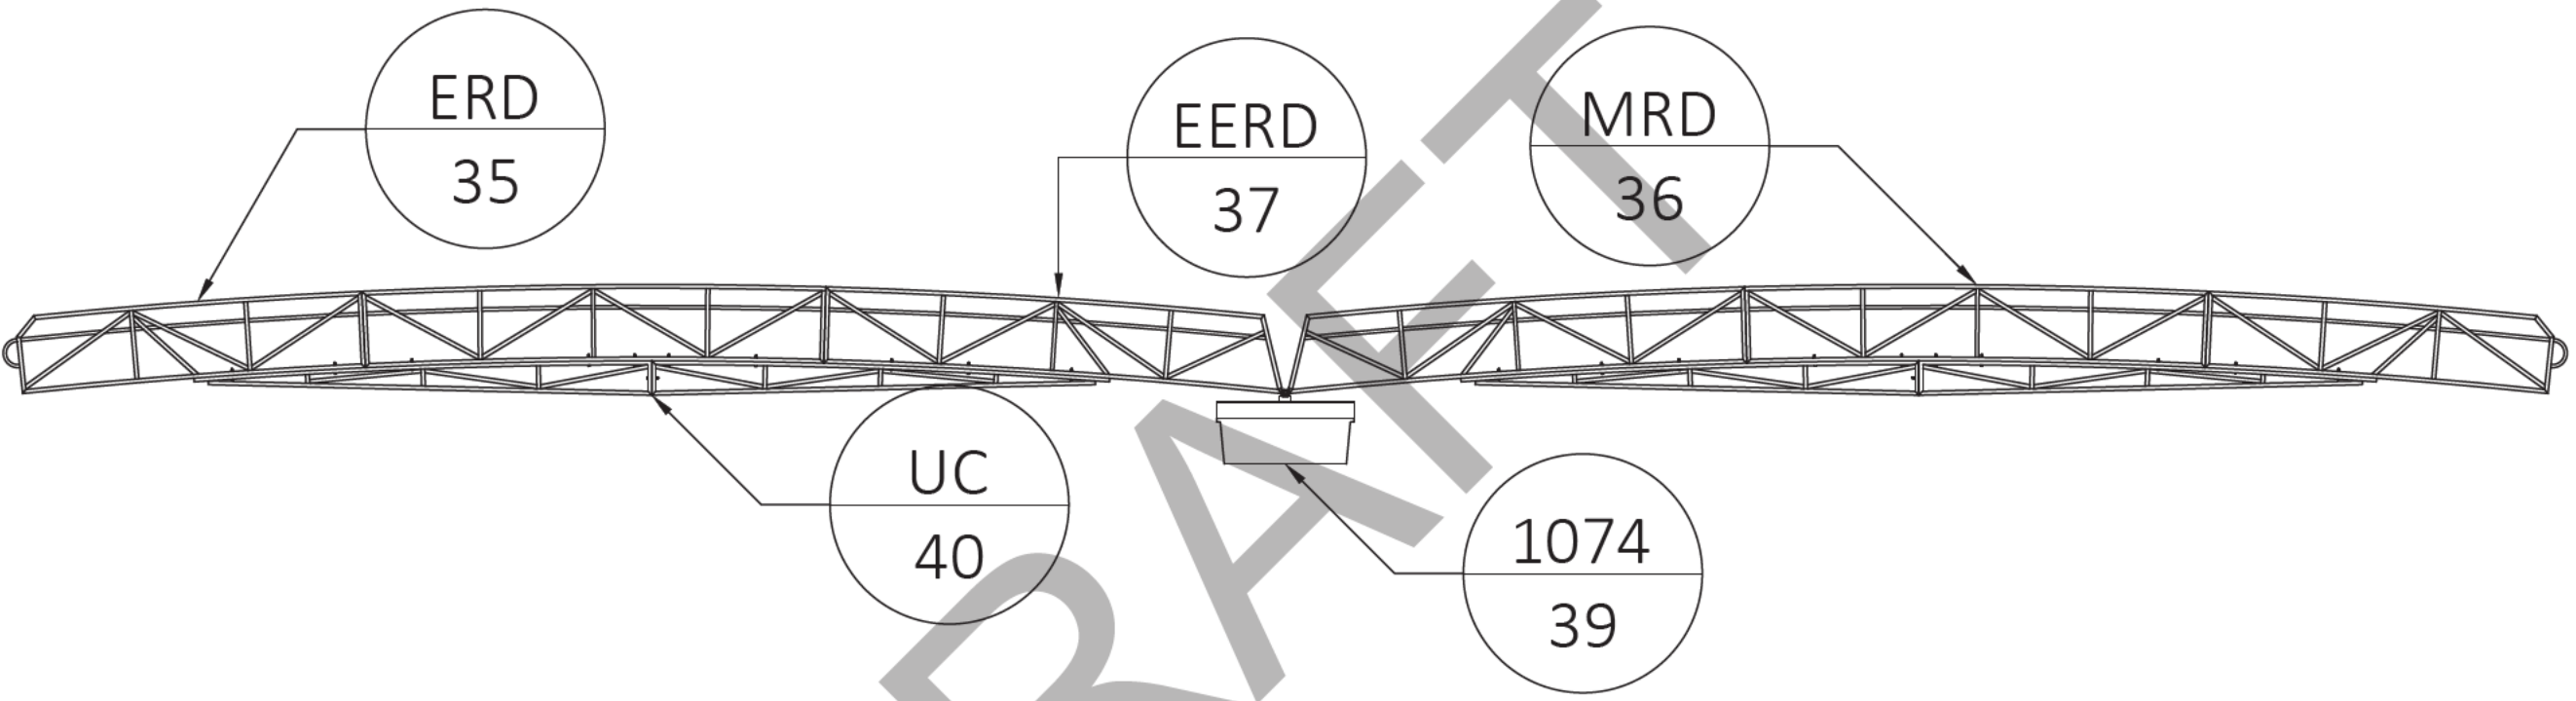

D:\Peninsula\LOGISTICS\LOCATION LOGISTICS\LOGS\BWP.DWG	--SHEET DETAIL--			SHORES AT THE PENINSULA.dwg			
	FILE NAME/CUSTOMER ➔						
	DRAWN: 6/1/2023			(2) 6' X 55' RAMPS W/ EQUALIZER SIDE VIEW			
	CHECKED:						
	MANAG.APPR:						
	ISSUED TO: MANUFACTURE						
	DESIGN DRAFTER: R.BAKER			SIZE B	SCALE 1:100	DWG TYPE/NO.	REV 0
	FABRICATOR:			SHEET 32 OF 42			

DECKING

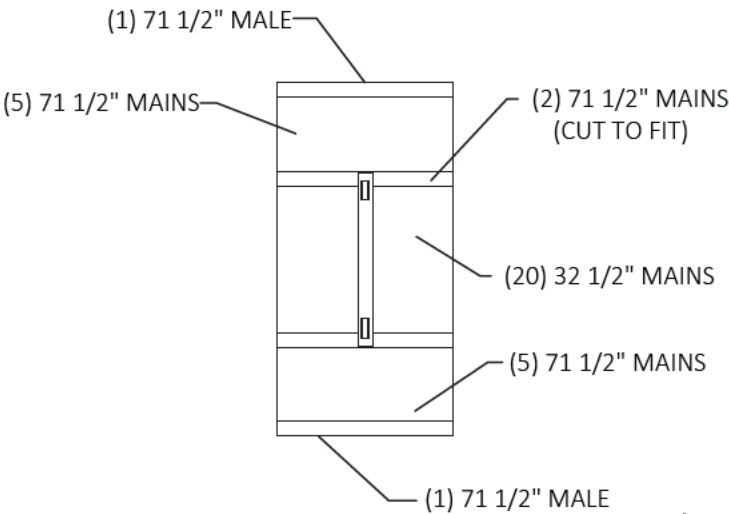

(1) 67" MALE

(109) 67" MAINS

(109) 67" MAINS

(1) 67" MALE

DECKING COLOR:

D:\Penins\LOGO ELEVATION LOGO\PS1 LOGO BW.JPG

-SHEET DETAIL-	
FILE NAME/CUSTOMER ➔	
DRAWN: 6/1/2023	
CHECKED:	
MANAG.APPR:	
ISSUED TO: MANUFACTURE	
DESIGN DRAFTER: R.BAKER	
FABRICATOR:	


SHORES AT THE PENINSULA.dwg	
(2) 6' X 55' RAMPS W/ EQUALIZER DECKING DIAGRAM	
SIZE	SCALE
B	1:80
DWG TYPE/NO.	
REV	
0	
SHEET 33 OF 42	

[illegible][illegible]

D:\General\LOGO\FUGATION\LOGO\FSI LOGO BW.JPG	-SHEET DETAIL-		SHORES AT THE PENINSULA.dwg			
	FILE NAME/CUSTOMER	➔				
	DRAWN: 6/1/2023	(2) 6' X 55' RAMPS W/ EQUALIZER DECKING CUT SHEET				
	CHECKED:					
	MANAG.APPR:					
	ISSUED TO: MANUFACTURE					
	DESIGN DRAFTER: R.BAKER	SIZE B	SCALE 1:80	DWG TYPE/NO.		REV 0
FABRICATOR:				SHEET 34 OF 42		

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D

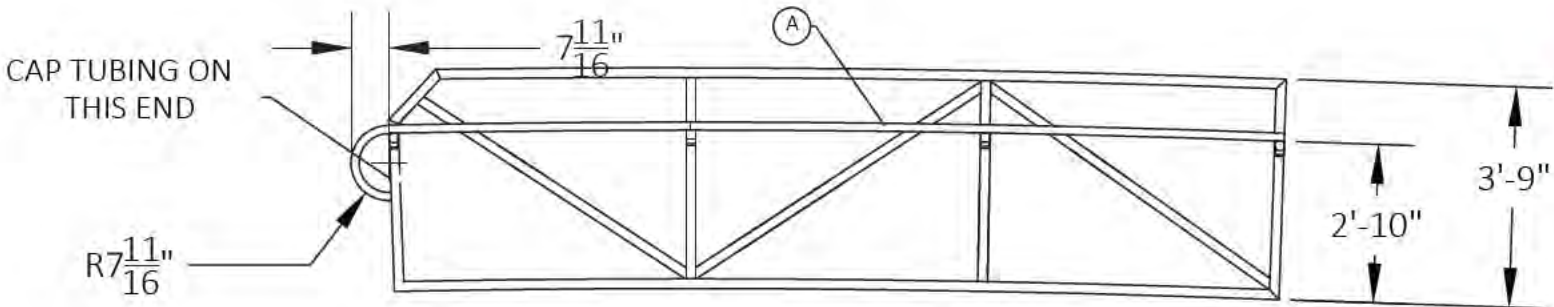


STOCK LIST			
DET. NO.	QTY.	DESCRIPTION	
A	2	1 1/4" SCH. 40 ALUM. PIPE 18' LG. **ROLLED ON ONE END** CUT TO FIT**	
B	8	GRAB BAR BRACKETS 1 3/4" LG.	
C	2	1" X 2" TUBING 15'-2" LG.	

END RAMP SECTION

C

C

SEE ATTACHMENT SHEET FOR THIS END OF THE RAMP

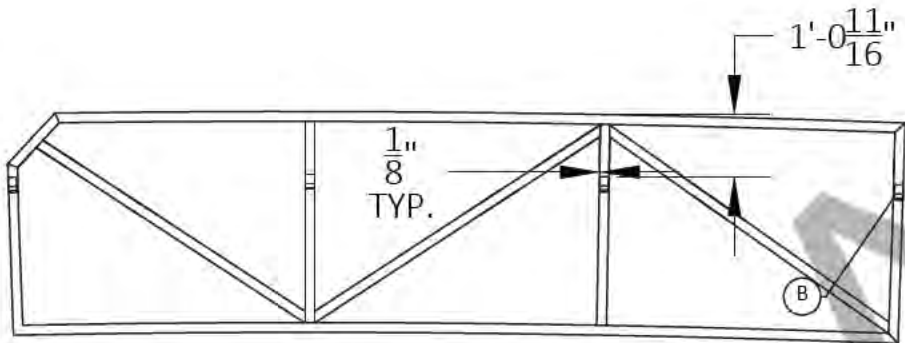


1'-0 11/16"
FROM THE TOP OF
THE RAMP TO THE
TOP OF THE GRAB RAIL
BRACKET

BOLT-UPS
ON THE THIS
END OF THE RAMP

B


B

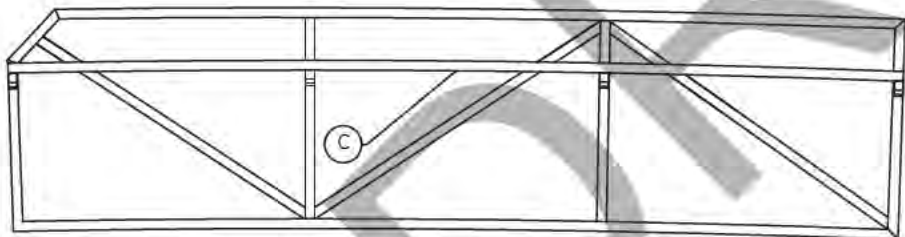


END RAMP SECTION

A

A

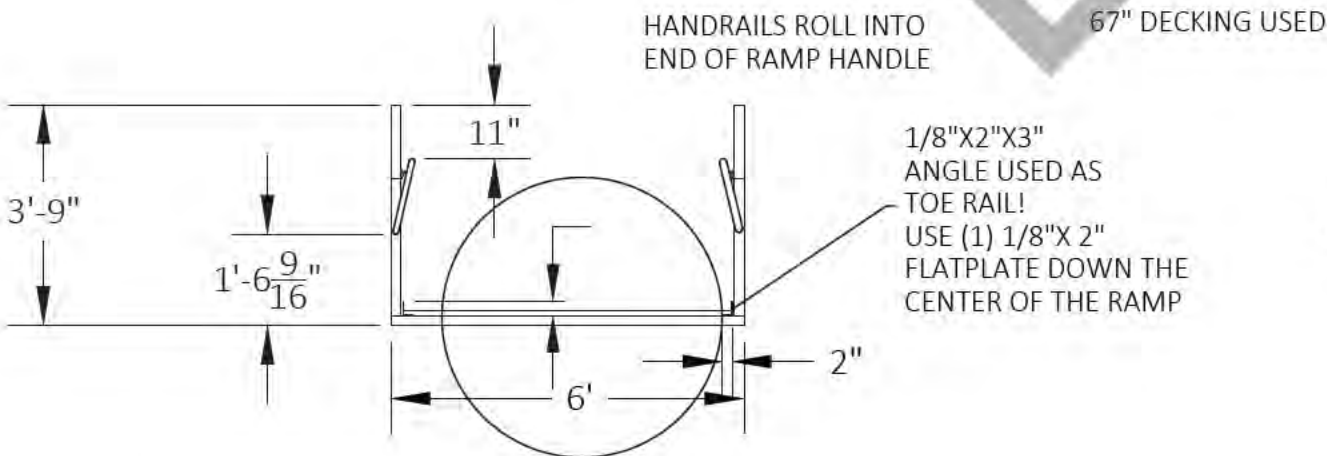


12 11/16"
FROM THE TOP OF
THE RAMP TO THE
TOP OF THE GRAB RAIL
BRACKET

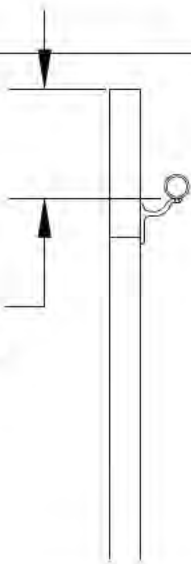

6 X 15' END
RAMP SECTION

-SHEET DETAIL-			
FILE NAME/CUSTOMER		SHORES AT THE PENINSULA.dwg	
DRAWN: 6/1/2023		(2) 6' X 55' RAMPS W/ EQUALIZER ERD	
CHECKED:			
MANAG.APPR:			
ISSUED TO: MANUFACTURE			
DESIGN DRAFTER: R.BAKER		SIZE B	SCALE 1:40
FABRICATOR:		DWG TYPE/NO.	REV 0
		SHEET 35 OF 42	


INSIDE VIEW

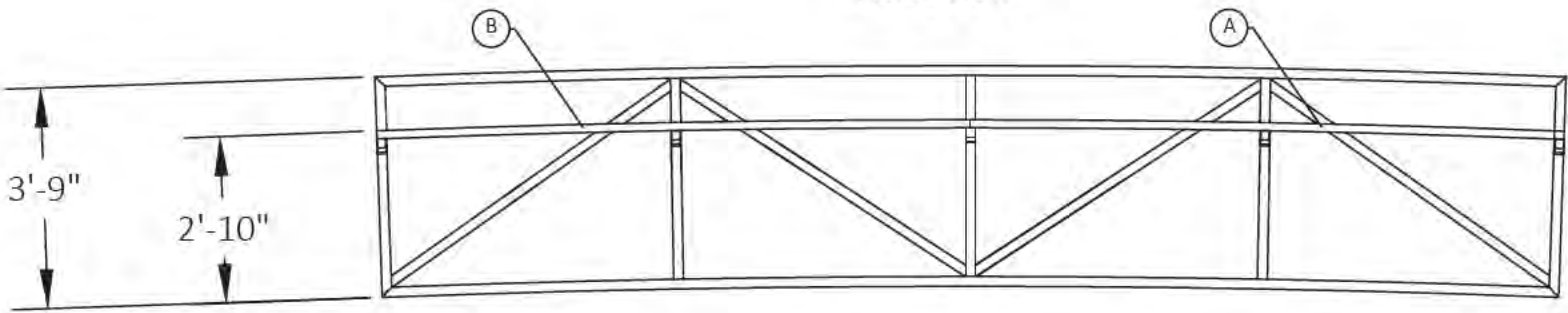

STOCK LIST		
DET. NO.	QTY.	DESCRIPTION
A	2	1 1/4" SCH. 40 ALUM. PIPE 20' LG. CUT TO FIT**
B	2	1 1/4" SCH. 40 ALUM PIPE 10'-1 5/16" LG.
C	10	GRAB BAR BRACKETS 1 3/4" LG.


MIDDLE RAMP SECTION

BOLT-UPS
ON THE THIS
END OF THE RAMP

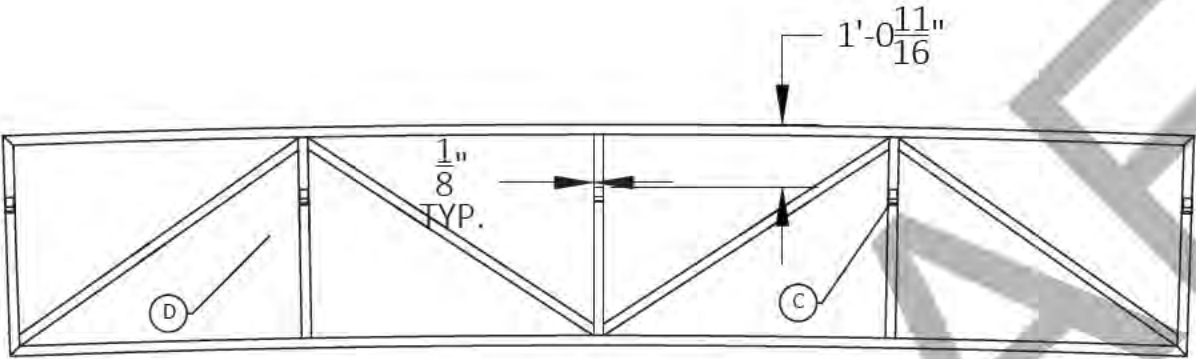


1'-0 11/16"
FROM THE TOP OF
THE RAMP TO THE
TOP OF THE GRAB RAIL
BRACKET

MIDDLE RAMP SECTION

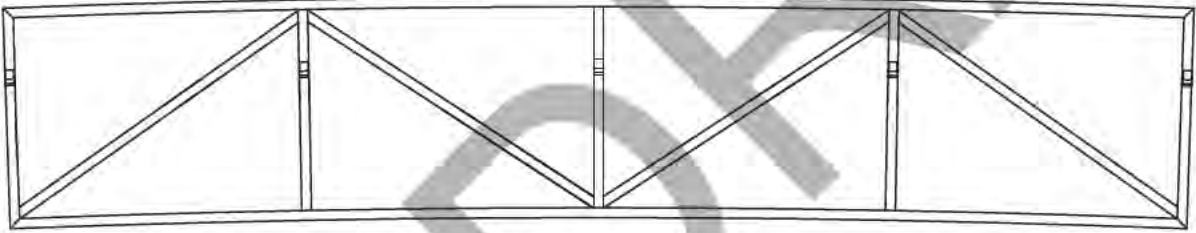

6' X 20' MIDDLE
RAMP SECTION

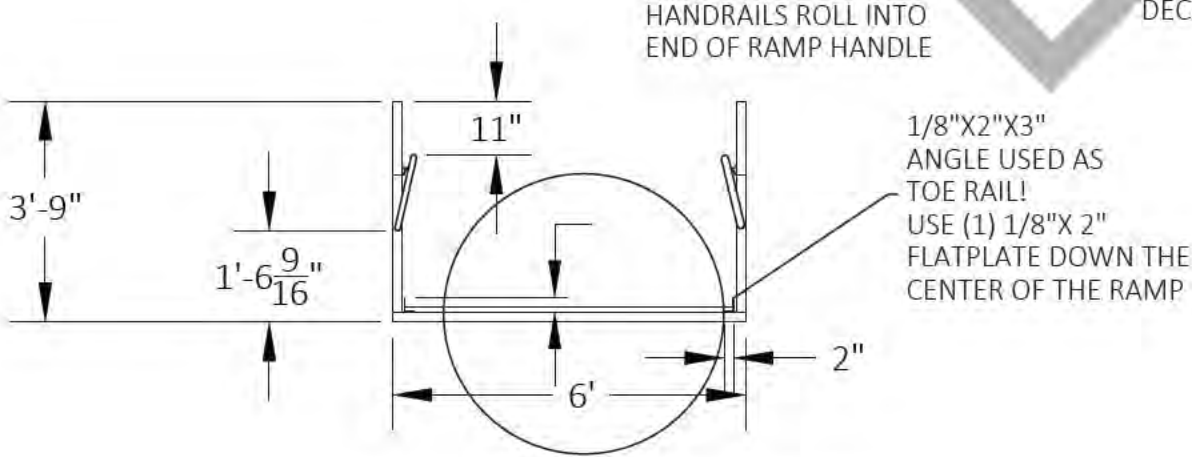


12 11/16"
FROM THE TOP OF
THE RAMP TO THE
TOP OF THE GRAB RAIL
BRACKET

-SHEET DETAIL-			
FILE NAME/CUSTOMER		SHORES AT THE PENINSULA.dwg	
DRAWN: 6/1/2023		(2) 6' X 55' RAMPS W/ EQUALIZER MRD	
CHECKED:			
MANAG. APPR:			
ISSUED TO: MANUFACTURE			
DESIGN DRAFTER: R. BAKER		SIZE B	SCALE 1:24
FABRICATOR:		DWG TYPE/NO.	REV 0
		SHEET 36 OF 42	


A	2	1 1/4" SCH. 40 ALUM. PIPE 13' LG. **ROLLED ON ONE END** CUT TO FIT**
B	2	1 1/4" SCH. 40 ALUM PIPE 10'-1 5/16" LG.
C	10	GRAB BAR BRACKETS 1 3/4" LG.

INSIDE VIEW

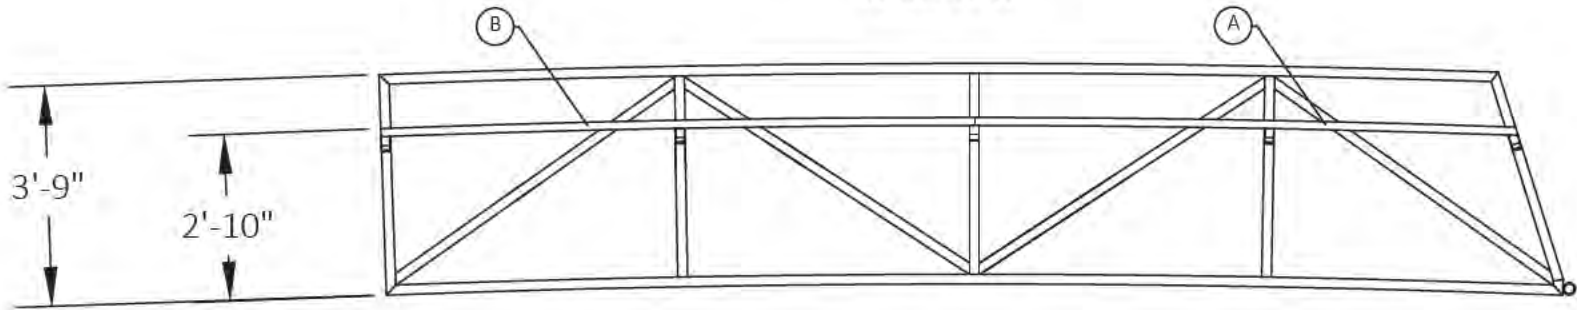


EQUALIZER END RAMP SECTION

BOLT-UPS
ON THE THIS
END OF THE RAMP

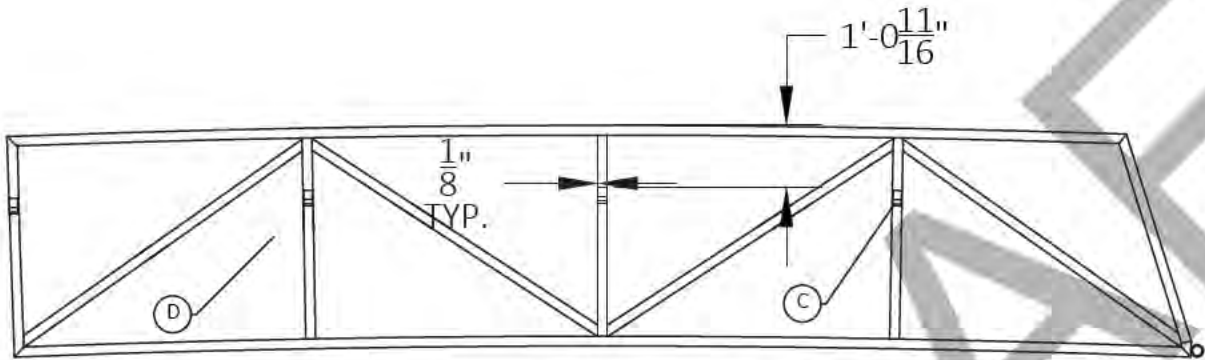


1'-0 11/16"
FROM THE TOP OF
THE RAMP TO THE
TOP OF THE GRAB RAIL
BRACKET

72" TRACK AND PIPE
ON THE THIS
END OF THE RAMP

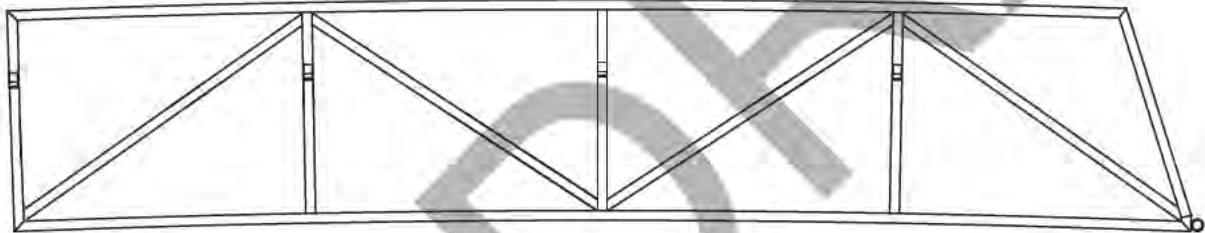

EQUALIZER END RAMP SECTION




6' X 20' EQUALIZER END
RAMP SECTION

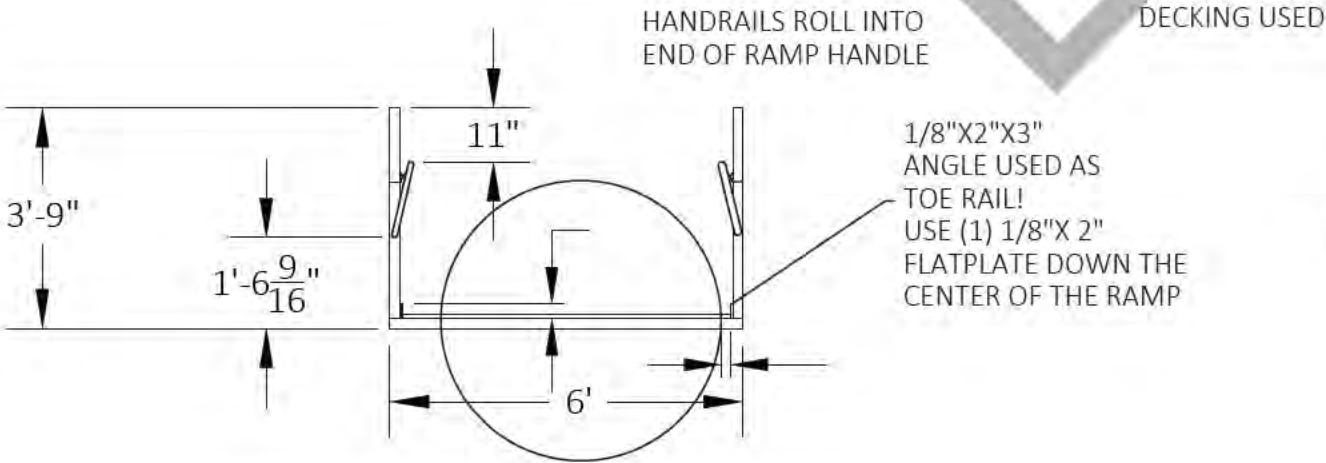



12 11/16"
FROM THE TOP OF
THE RAMP TO THE
TOP OF THE GRAB RAIL
BRACKET

-SHEET DETAIL-		SHORES AT THE PENINSULA.dwg	
FILE NAME/CUSTOMER	→	(2) 6' X 55' RAMPS W/ EQUALIZER EERD	
DRAWN:	6/1/2023		
CHECKED:			
MANAG. APPR:			
ISSUED TO:	MANUFACTURE		
DESIGN DRAFTER:	R. BAKER	SIZE	SCALE
FABRICATOR:		B	1:40
		DWG TYPE/NO.	REV
			0
		SHEET 37 OF 42	

CUT LIST							
DIE NUMBER	ITEM	QTY.	DESCRIPTION	DEGREE	FT	IN	TOTAL FT
FS-00431	A	2	8" H.W.	45°-45°	12	0"	24.00
FS-00431	B	2	8" H.W.	45°-45°	6	0"	12.00
FS-00431	C	5	8" H.W.	45°-45°	5	7 1/2"	#####
	D	1	6" H.W.	0°-0°	8	5/8"	8.05
FS-00431	E	8	8" H.W.	45°-45°	1	2"	9.33
FH-07812	F	2	RAMP PIPE	0°-0°		8"	1.33
FS-00678	G	2	3/4" X 6" FLATPLATE	0°-0°		2 1/4"	####
FS-00431	H	2	8" H.W.	0°-0°	2	9 3/16"	####
FS-07813	I	1	RAMP TRACK	0°-0°	8	0	8.00

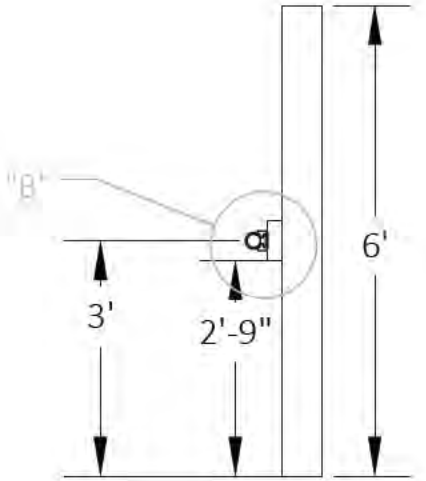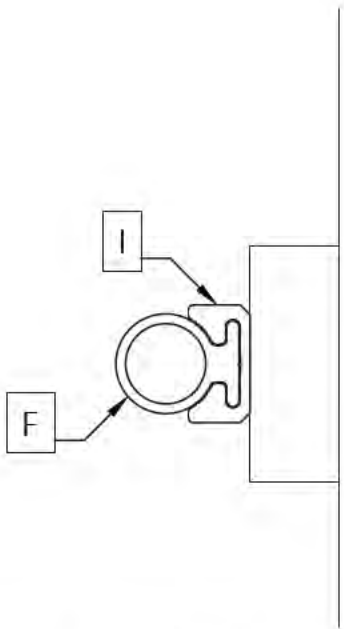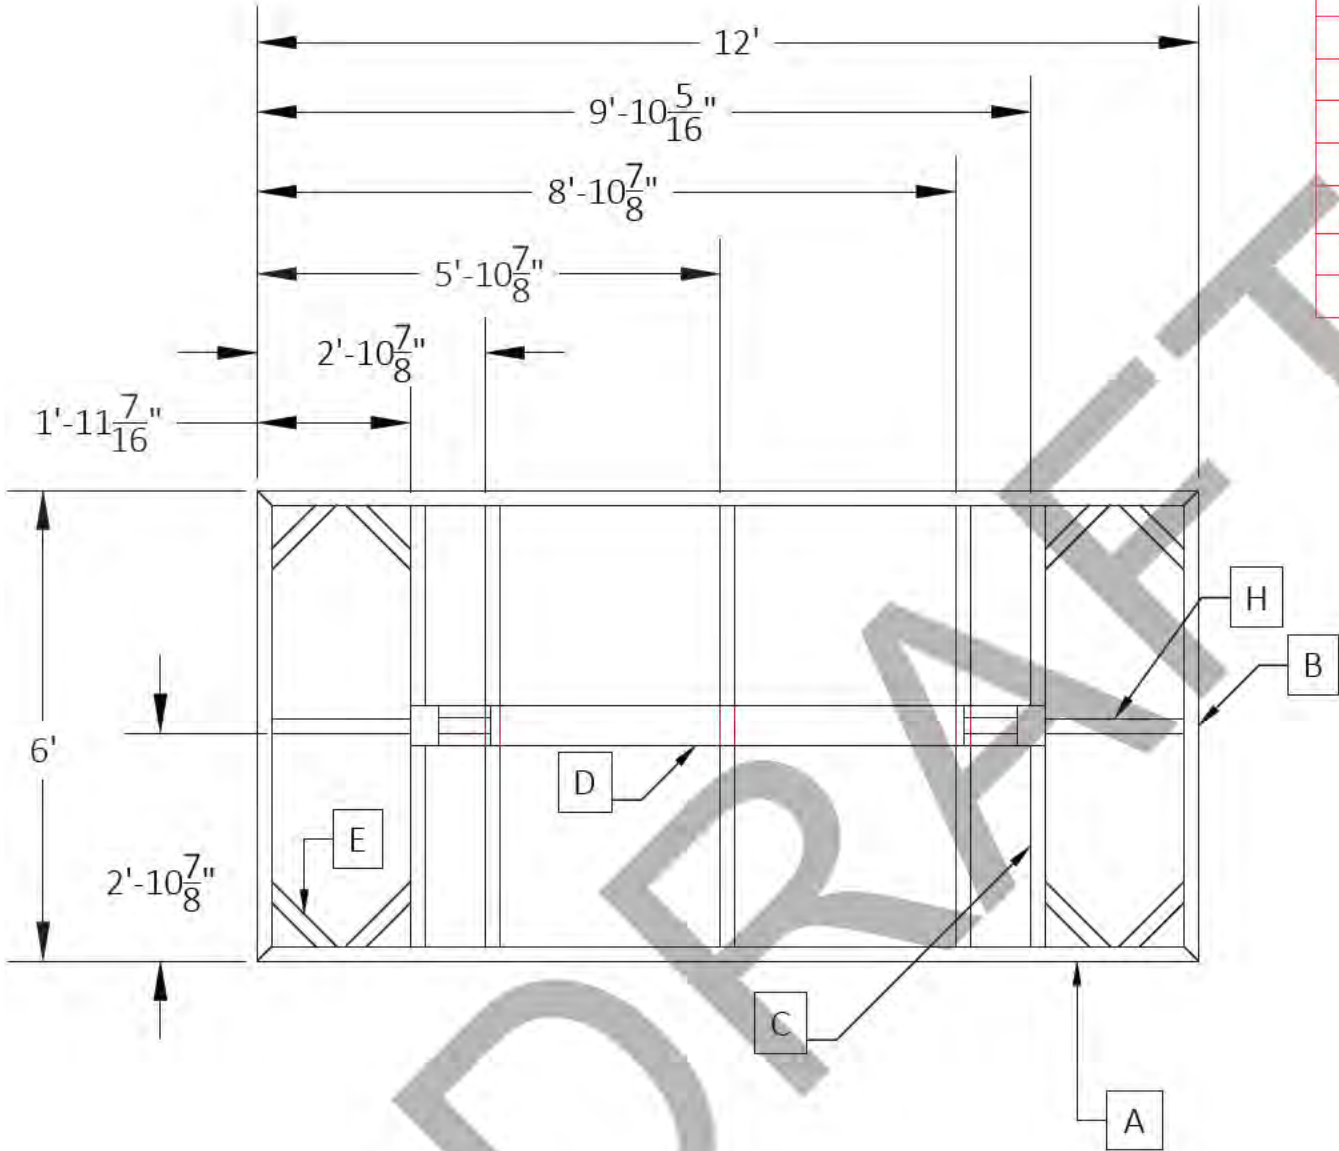

1074

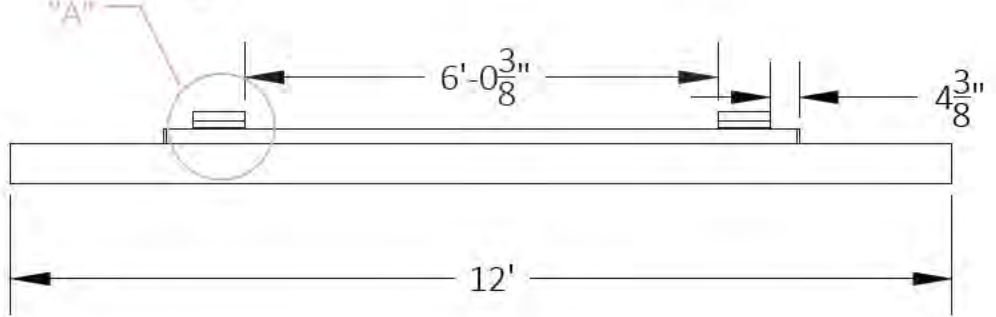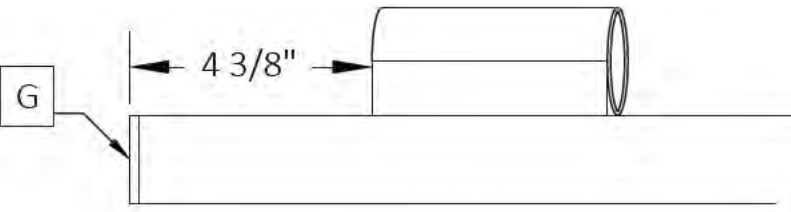

-SHEET DETAIL-			
FILE NAME/CUSTOMER		SHORES AT THE PENINSULA.dwg	
DRAWN: 6/1/2023		(2) 6' X 55' RAMPS W/ EQUALIZER	
CHECKED:		1074	
MANAG.APPR:			
ISSUED TO: MANUFACTURE			
DESIGN DRAFTER: R.BAKER		SIZE B	SCALE 1:30
FABRICATOR:		DWG TYPE/NO.	REV 0
		SHEET 39 OF 42	

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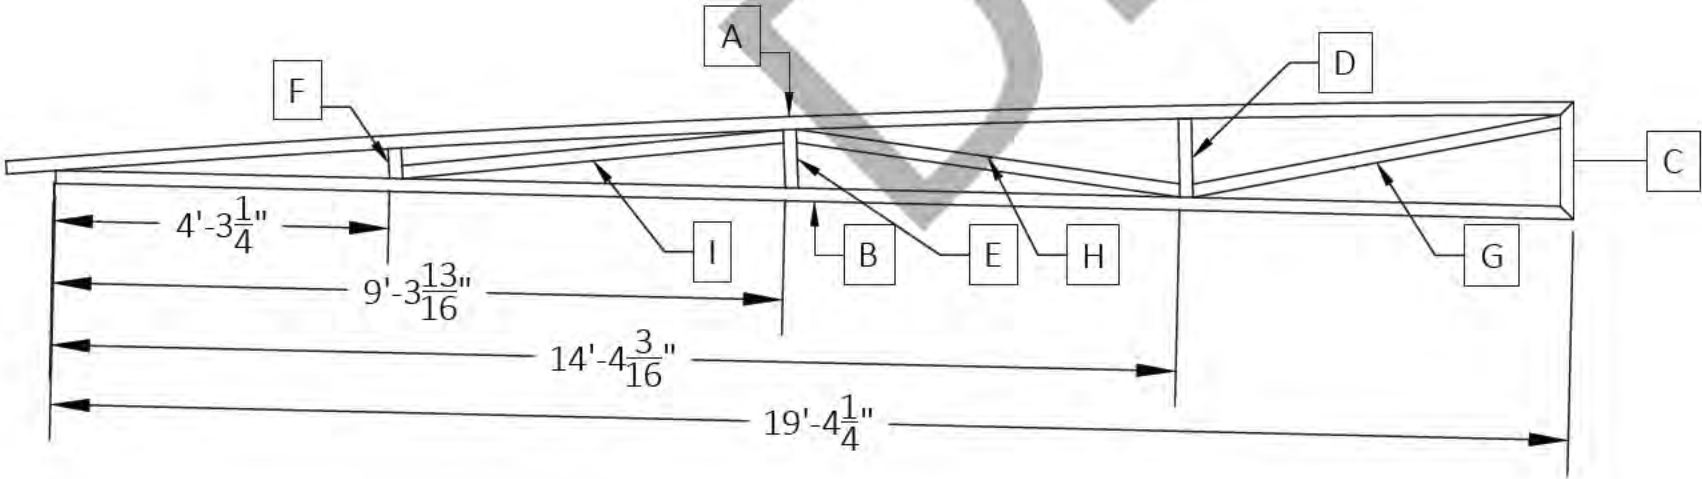
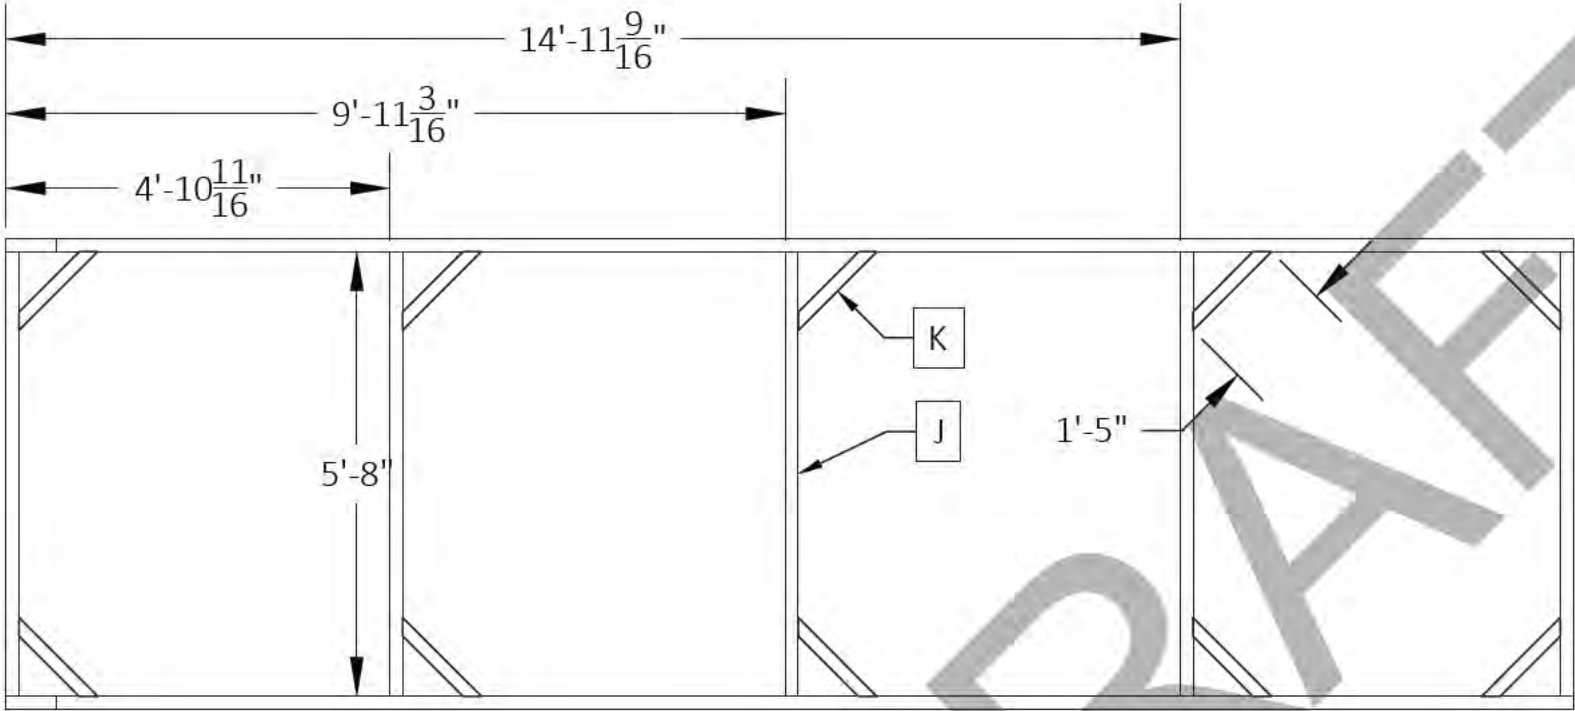
C

B

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A

A



(4)REQUIRED

CUT/STOCK LIST							
DIE NUMBER	ITEM	QTY.	DESCRIPTION	DEGREE	FT.	IN.	TOTAL FT.
FH-01356	A	2	1/8" X 2" X 2" TUBE	45°-0°	20	0"	40.00
FH-01356	B	2	1/8" X 2" X 2" TUBE	45°-45°	19	4 1/4"	#####
FH-01356	C	2	1/8" X 2" X 2" TUBE	45°-45°	1	6"	3.00
FH-01356	D	2	1/8" X 2" X 2" TUBE	0°-2°	1	1/16"	2.01
FH-01356	E	2	1/8" X 2" X 2" TUBE	0°-2°		8 15/16"	####
FH-01356	F	2	1/8" X 2" X 2" TUBE	0°-2°		4 11/16	0.78
FH-01356	G	2	1/8" X 2" X 2" TUBE	10°-11°	4	8 7/8	9.48
FH-01356	H	2	1/8" X 2" X 2" TUBE	9°-10°	4	11 1/4	9.88
FH-01356	I	2	1/8" X 2" X 2" TUBE	2°-3°	4	10 1/2	9.75
FH-01356	J	5	1/8" X 2" X 2" TUBE	0°-0°	5	8	28.33
FH-01356	K	10	1/8" X 2" X 2" TUBE	0°-2°	1	5	14.17

SHEET INFORMATION LOG	-SHEET DETAIL-			SHORES AT THE PENINSULA.dwg			
	FILE NAME/CUSTOMER ➔						
	DRAWN: 6/1/2023			(2) 6' X 55' RAMPS W/ EQUALIZER UC			
	CHECKED:						
	MANAG.APPR:						
	ISSUED TO: MANUFACTURE						
	DESIGN DRAFTER: R.BAKER			SIZE	SCALE	DWG TYPE/NO.	REV
	FABRICATOR:			B	1:30		0
					SHEET	40 OF 42	

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➔ ACCESSORIES ➔			
QTY.	DESCRIPTION	PC	COLOR
54	HORIZONTAL BUMPER		
24	CORNER BUMPER		
105	SUPER CUSHION		
2	DIAGONAL CABLES (RAMP)		
132	POST TRIM (2pc. - # of post)		
1	ROLLER GUIDE ASSEMBLY		
55	FLOAT PLUGS		
42	CLEATS		
51	20' STAIR NOSING (sti k)		
2	RAMP WEIGHT LIMIT TAG		
24	4" PVC CAPS		
24	SPUD POLE **SI ENCERS *		
24	4" GALVANIZED SPUD POLES		
2	DECKING TOUCH-UP		

SHEET INFORMATION LOGO BMP	-SHEET DETAIL-		SHORES AT THE PENINSULA.dwg				
	FILE NAME/CUSTOMER ➔						
	DRAWN: 6/1/2023		ACCESSORY SHEET				
	CHECKED:						
	MANAG.APPR:						
	ISSUED TO: MANUFACTURE						
	DESIGN DRAFTER: R.BAKER		SIZE B	SCALE 1:30	DWG TYPE/NO.		REV 0
	FABRICATOR:				SHEET 41 OF 42		

D:\Papers\LOGO VIGNATION\LOGOFSI LOGO BW.JPG

-SHEET DETAIL-		SHORES AT THE PENINSULA.dwg				
FILE NAME/CUSTOMER ➔						
DRAWN: 6/1/2023		LOAD LIST				
CHECKED:						
MANAG.APPR:						
ISSUED TO: MANUFACTURE						
DESIGN DRAFTER: R.BAKER		SIZE B	SCALE 1:30	DWG TYPE/NO.		REV 0
FABRICATOR:				SHEET 42 OF 42		

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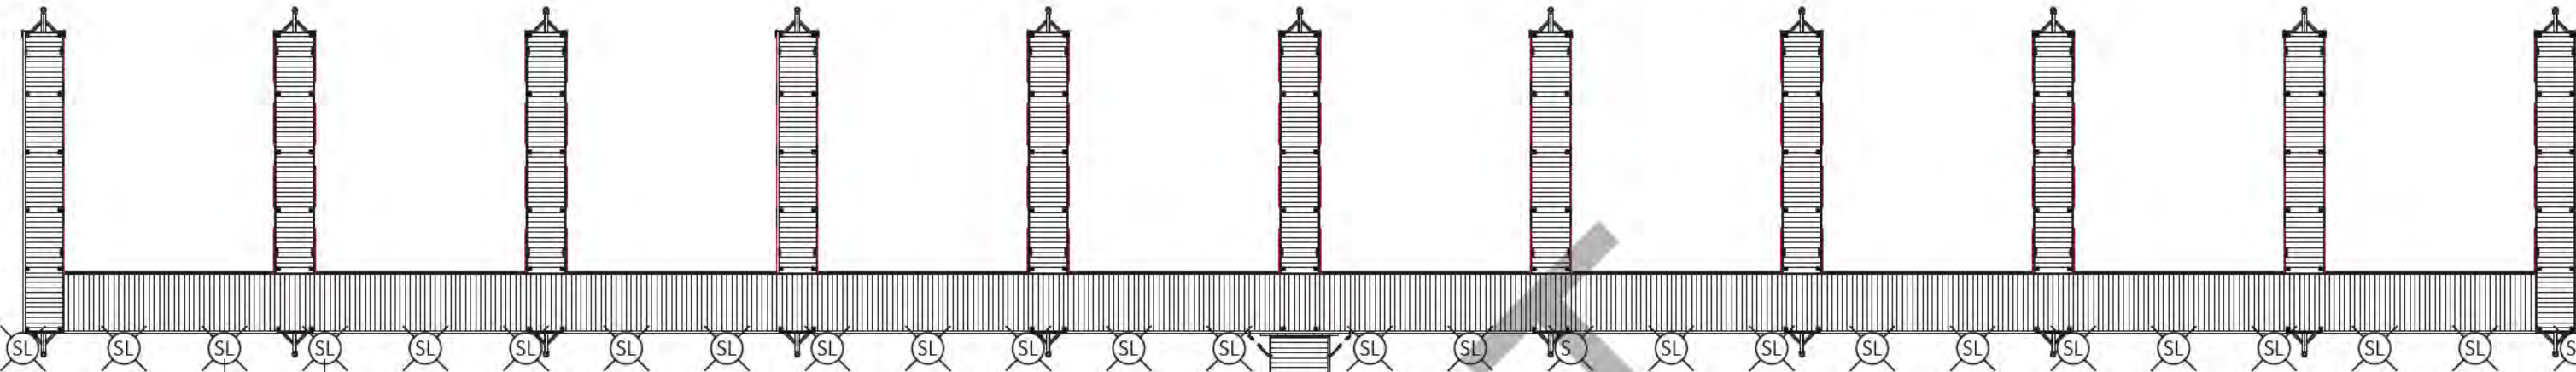
C

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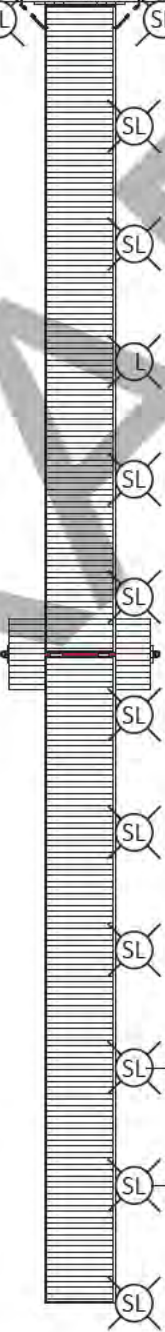
A



10'
TYP.




TECHNICAL DETAILS	
BRAND	JACKYLED
COLOR	WHITE
MATERIAL	ALUMINUM
STYLE	MODERN
LIGHT FIXTURE FORM	PATH
PRODUCT DIMENSIONS	4.37" W X 0.94" H
INDOOR/OUTDOOR USAGE	OUTDOOR
POWER SOURCE	SOLAR POWERED
SPECIAL FEATURE	IP68 WATERPROOF
CONTROL METHOD	REMOTE
LIGHT SOURCE TYPE	LED
SHADE MATERIAL	ALUMINUM ALLOY
NUMBER OF LIGHT SOURCES	6
VOLTAGE	2 VOLTS
LIGHT COLOR	WARM LIGHT
SHAPE	SQUARE
WARRANTY TYPE	1-YEAR WARRANTY
LIGHTING METHOD	DOWNLIGHT
ITEM WEIGHT	8.99 POUNDS
MOUNTING TYPE	DECK MOUNT
SHADE COLOR	WHITE
FIXTURE TYPE	NON REMOVABLE
MANUFACTURER	JACKYLED
COLLECTION	DOCK LIGHTS
PLUG FORMAT	A- US STYLE
COLOR TEMPERATURE	3000 KELVIN



10'
TYP.

SL SOLAR LIGHTS- SUPPLIED AND
INSTALLED BY: BD
ACQUISITIONS, LLC.

SHEET INFORMATION BLOCK (DO NOT REMOVE)	--SHEET DETAIL--		SHORES AT THE PENINSULA.dwg		
	FILE NAME/CUSTOMER ➔				
	DRAWN: 6/1/2023		PLAN VIEW LIGHT PLACEMENT		
	CHECKED:				
	MANAG.APPR:				
	ISSUED TO: MANUFACTURE				
	DESIGN DRAFTER: R.BAKER				
FABRICATOR:		SIZE B	SCALE 1:50	DWG TYPE/NO.	REV 0
				SHEET 9 OF 42	

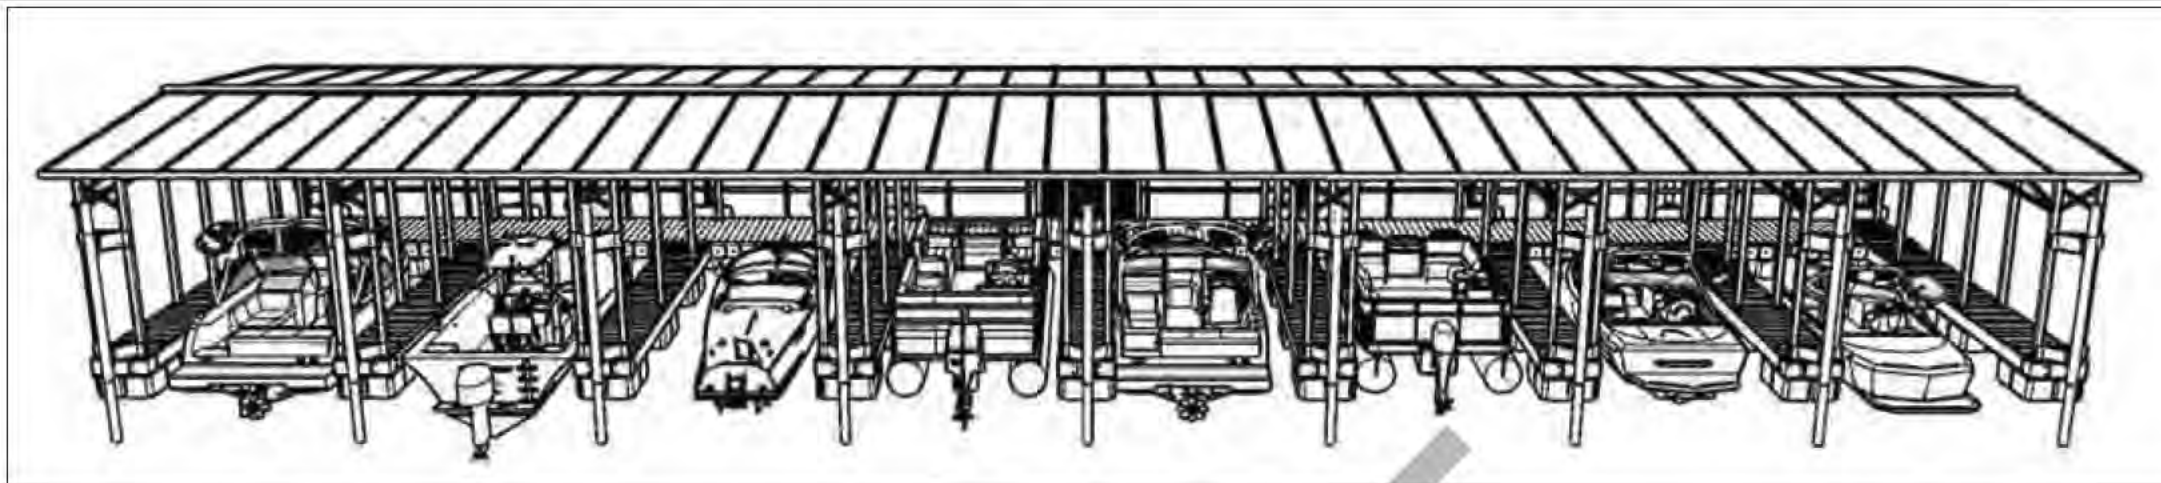

8 SLIP FOR THE PENINSULA LOTS 16-23

DRAWING LIST			
SHEET NUMBER	DESCRIPTION	SHEET NUMBER	DESCRIPTION
1	BANK VIEW	22	4IN STUB UP
2	LEFT VIEW	23	3' COLLAR VIEWS
3	ANGLE CUT SIDE	24	3' COLLAR
4	WATER VIEW	25	21' POLE
5	PLAN VIEW	26	SR1
6	FLOOR DIAGRAM	27	SR2
7	ROOF ASSEMBLY	28	RAMP SIDE VIEW
8	FRAME DIAGRAM	29	RAMP SIDE DIAGRAM
9	DECKING DIAGRAM	30	RAMP DECKING DIAGRAM
10	POST DIAGRAM	31	RAMP DECKING CUTLIST
11	BW627.5L	32	END RAMP DETAIL
12	BW626-L	33	MIDDLE RAMP DETAIL
13	ATTACHMENT SHEET	34	EQ END RAMP DETAIL
14	BW626-R	35	EQ END RAMP ATTACHMENT
15	ATTACHMENT SHEET	36	EQUALIZER
16	BW627.5R	37	UNDERCARRIAGE
17	F324	38	1068
18	8' COLLAR SIDE	39	1005
19	8' COLLAR FRONT	40	1033
20	8' COLLAR TOP	41	ACCESSORIES
21	8' COLLAR	42	LOAD SHEET

D

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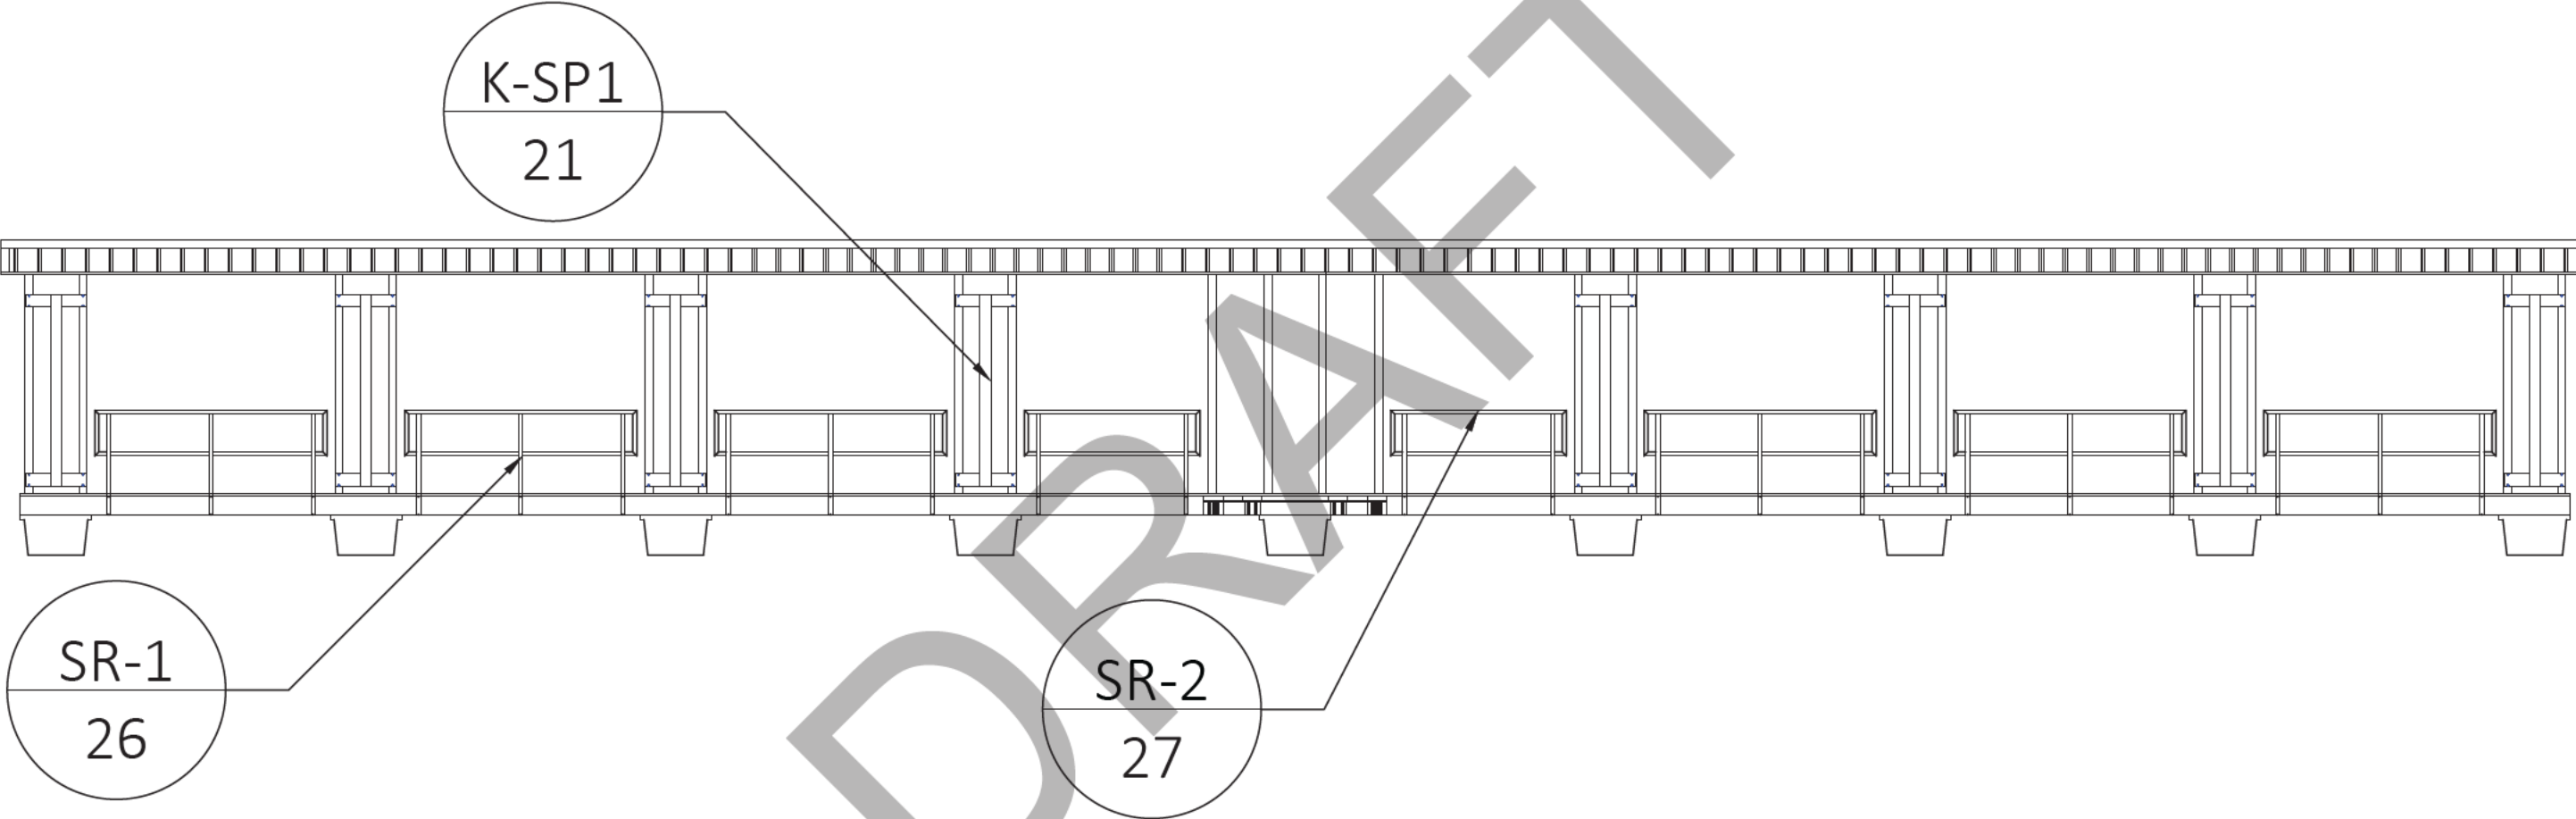
C

B

B

A



A



-SHEET DETAIL-		8 SLIP THE PENINSULA LOTS16-23.dwg			
FILE NAME/CUSTOMER ➔					
DRAWN: 9/19/2023		BANK VIEW			
CHECKED:					
MANAG.APPR:					
ISSUED TO: MANUFACTURE					
DESIGN DRAFTER: R.BAKER		SIZE B	SCALE 1:88	DWG TYPE/NO.	REV 0
FABRICATOR:					SHEET 1 OF 42

NOTE:
SEE POST DIAGRAM SH-15 FOR EXACT LOCATIONS
WHERE LATERAL BRACING IS REQUIRED. (G, H, I, J)

- (2) 3/8"X5 1/2" H.B.
- (4) 3/8"X7/8" WASHERS
- (2) 3/8" NYLOCK NUTS
PER POST

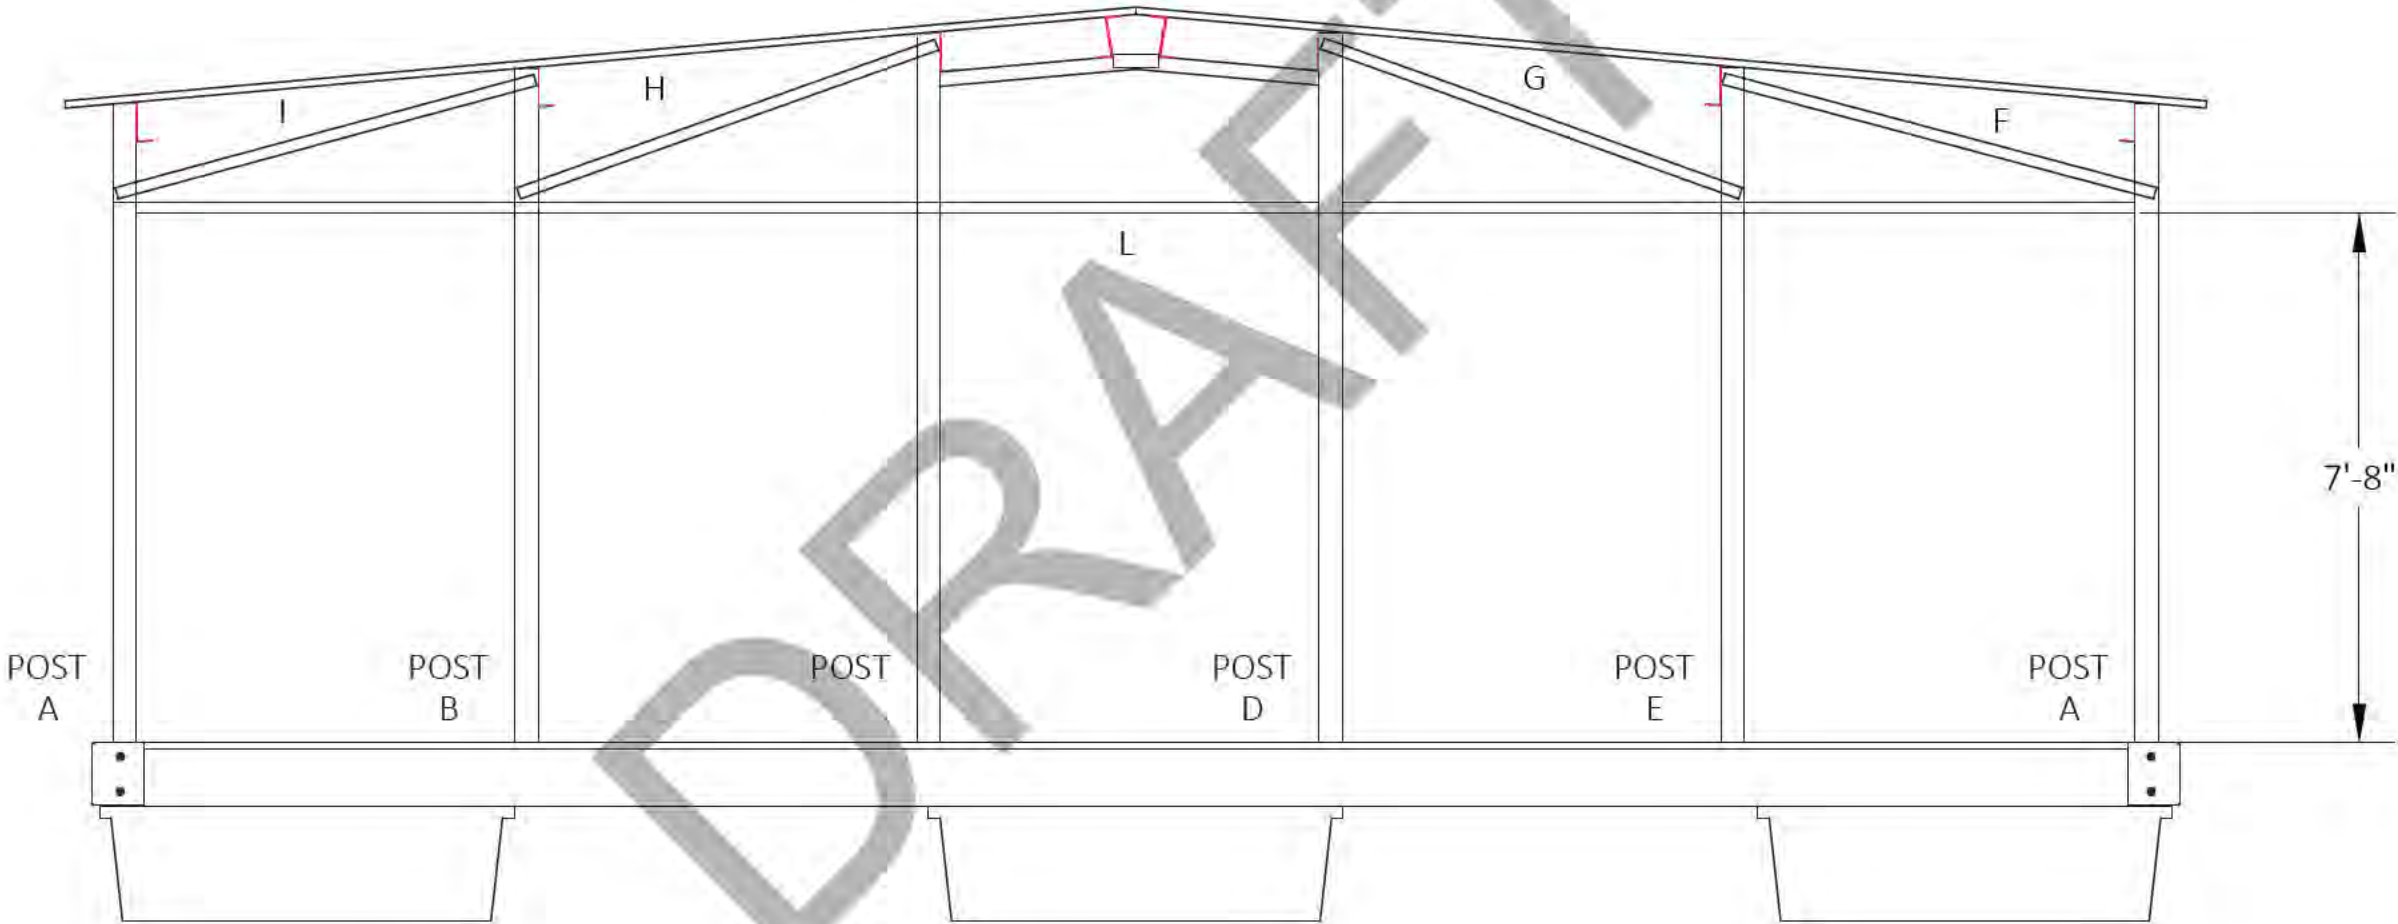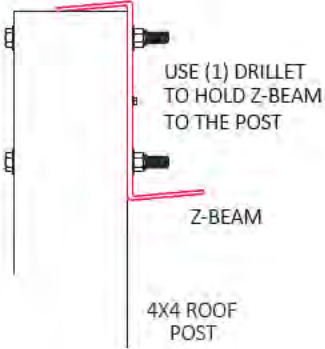

-SHEET DETAIL-					
FILE NAME/CUSTOMER ➔		8 SLIP THE PENINSULA LOTS16-23.dwg			
DRAWN: 9/19/2023		LEFT SIDE VIEW			
CHECKED:					
MANAG.APPR:					
ISSUED TO: MANUFACTURE					
DESIGN DRAFTER: R.BAKER		SIZE B	SCALE 1:34	DWG TYPE/NO.	REV 0
FABRICATOR:				SHEET	2 OF 42



ROOF MATERIAL CUT LIST

	QTY.	2" X 2" ANGLE BRACING
F	9	6'-5 1/12" LG.
G	9	6'-5 1/8" LG.
H	9	6'-5 1/16" LG.
I	9	6'-3 5/16"
J	18	4'-5 1/4"
K	36	5'-2 7/16
L	9	29'-7 1/8
	QTY.	Z-BEAM
N	16	30'
O	16	29'

-SHEET DETAIL-		8 SLIP THE PENINSULA LOTS16-23.dwg			
FILE NAME/CUSTOMER ➔					
DRAWN: 9/19/2023					
CHECKED:					
MANAG.APPR:		LEFT SIDE VIEW			
ISSUED TO: MANUFACTURE					
DESIGN DRAFTER: R.BAKER					
FABRICATOR:		SIZE B	SCALE 1:32	DWG TYPE/NO.	REV 0
				SHEET 3 OF 42	

D

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C


C

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-SHEET DETAIL-		8 SLIP THE PENINSULA LOTS16-23.dwg			
FILE NAME/CUSTOMER ➔					
DRAWN: 9/19/2023					
CHECKED:					
MANAG.APPR:		LEFT SIDE VIEW			
ISSUED TO: MANUFACTURE					
DESIGN DRAFTER: R.BAKER					
FABRICATOR:		SIZE B	SCALE 1:88	DWG TYPE/NO.	REV 0
				SHEET 4 OF 42	

D

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C


C
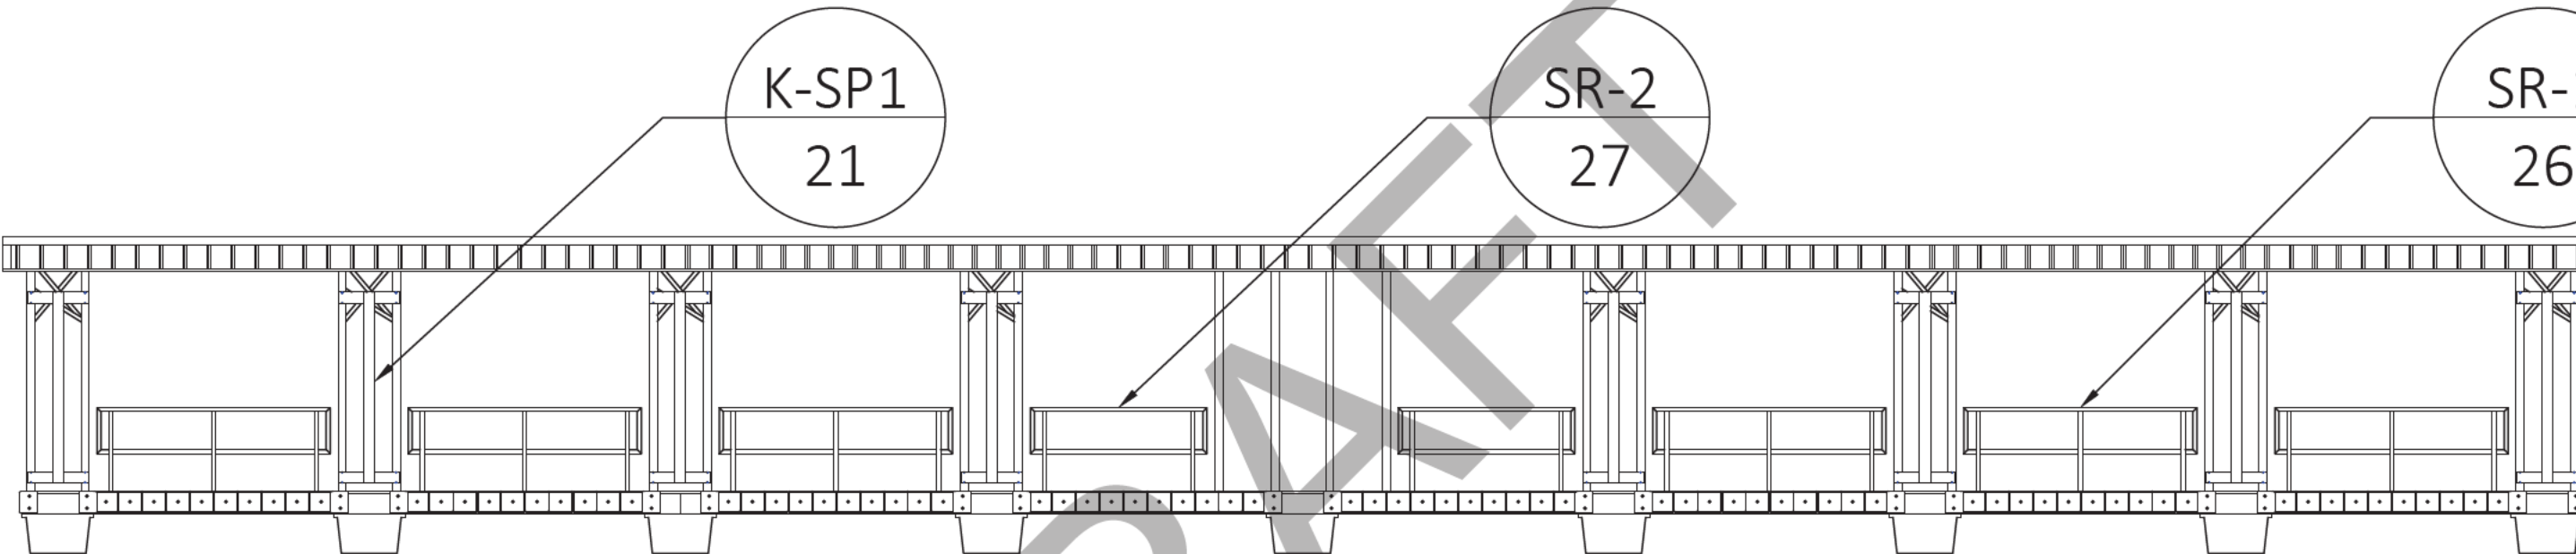
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-SHEET DETAIL-					
FILE NAME/CUSTOMER ➔		8 SLIP THE PENINSULA LOTS16-23.dwg			
DRAWN: 9/19/2023		LEFT SIDE VIEW			
CHECKED:					
MANAG. APPR:					
ISSUED TO: MANUFACTURE					
DESIGN DRAFTER: R. BAKER		SIZE B	SCALE 1:140	DWG. TYPE/NO.	REV 0
FABRICATOR:				SHEET 5 OF 42	

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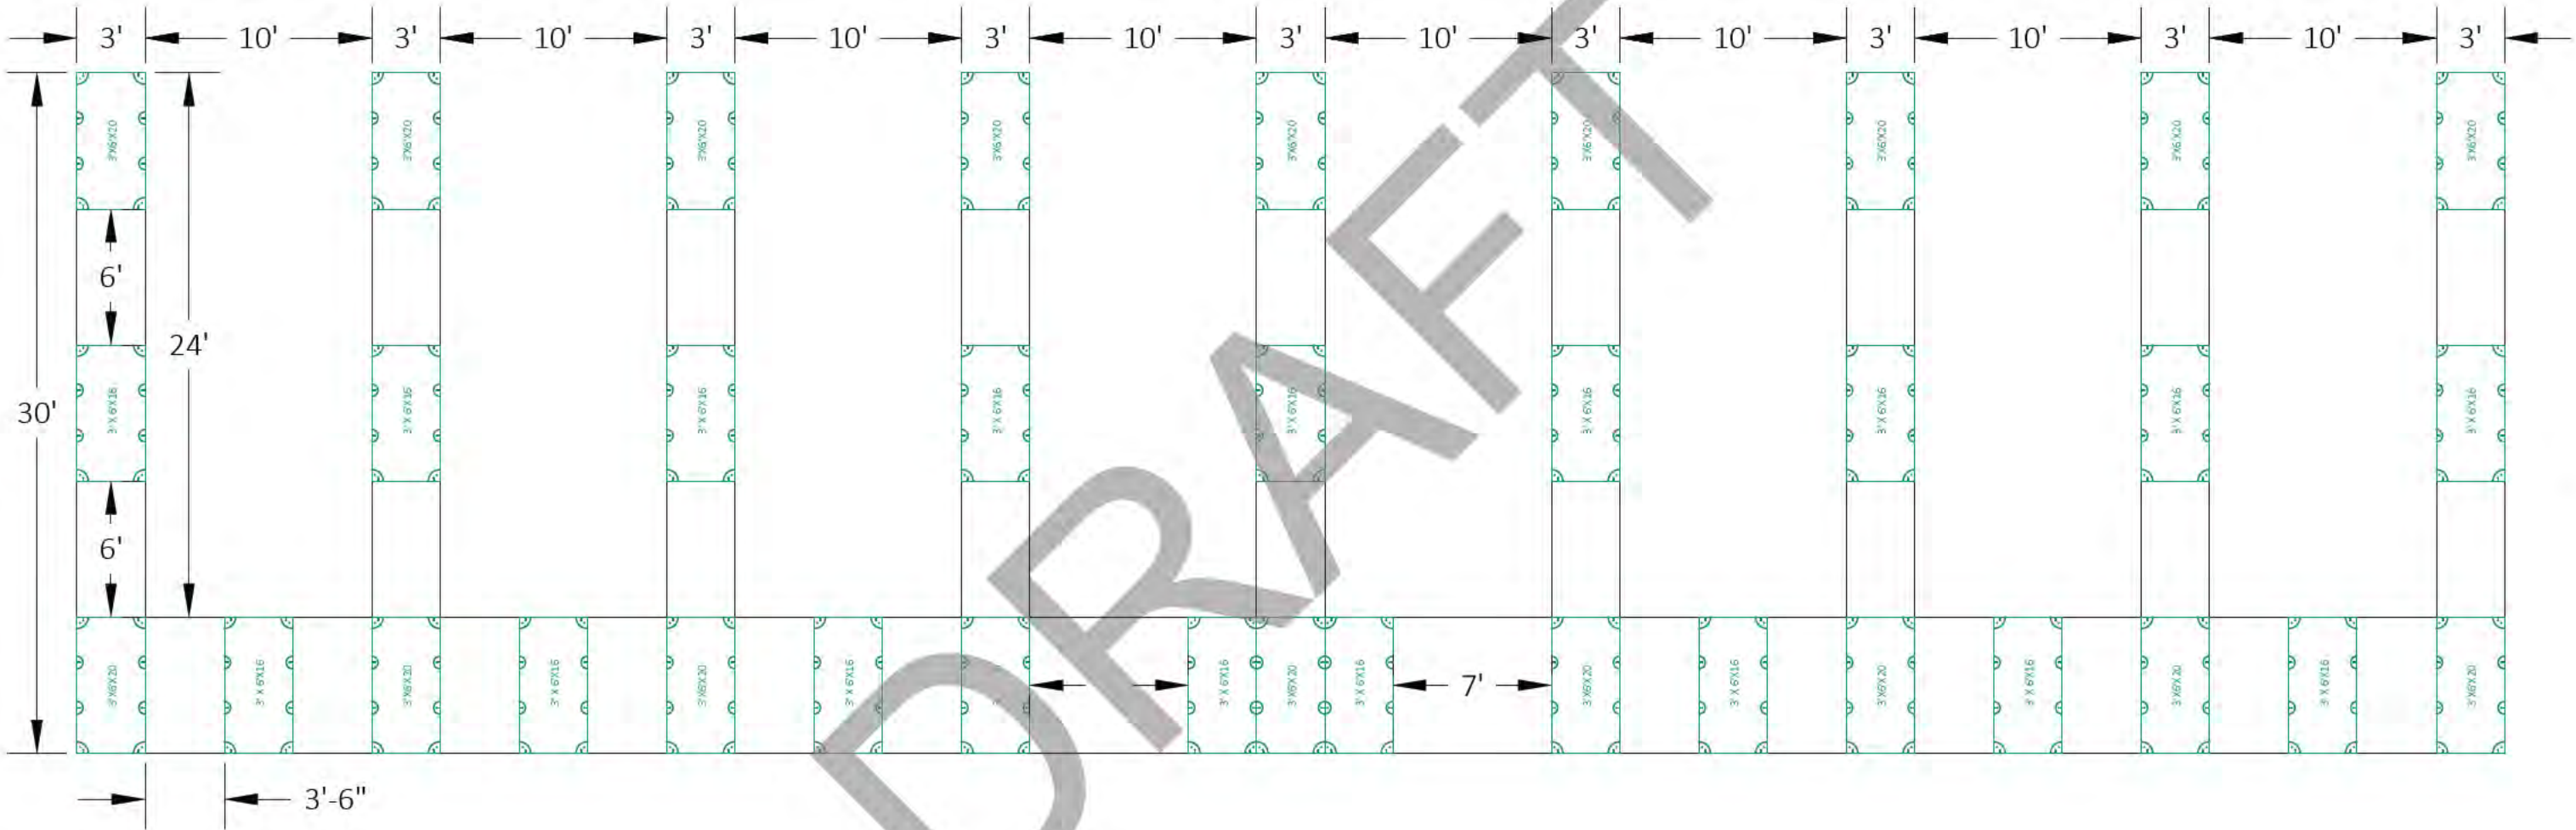
C

B

B

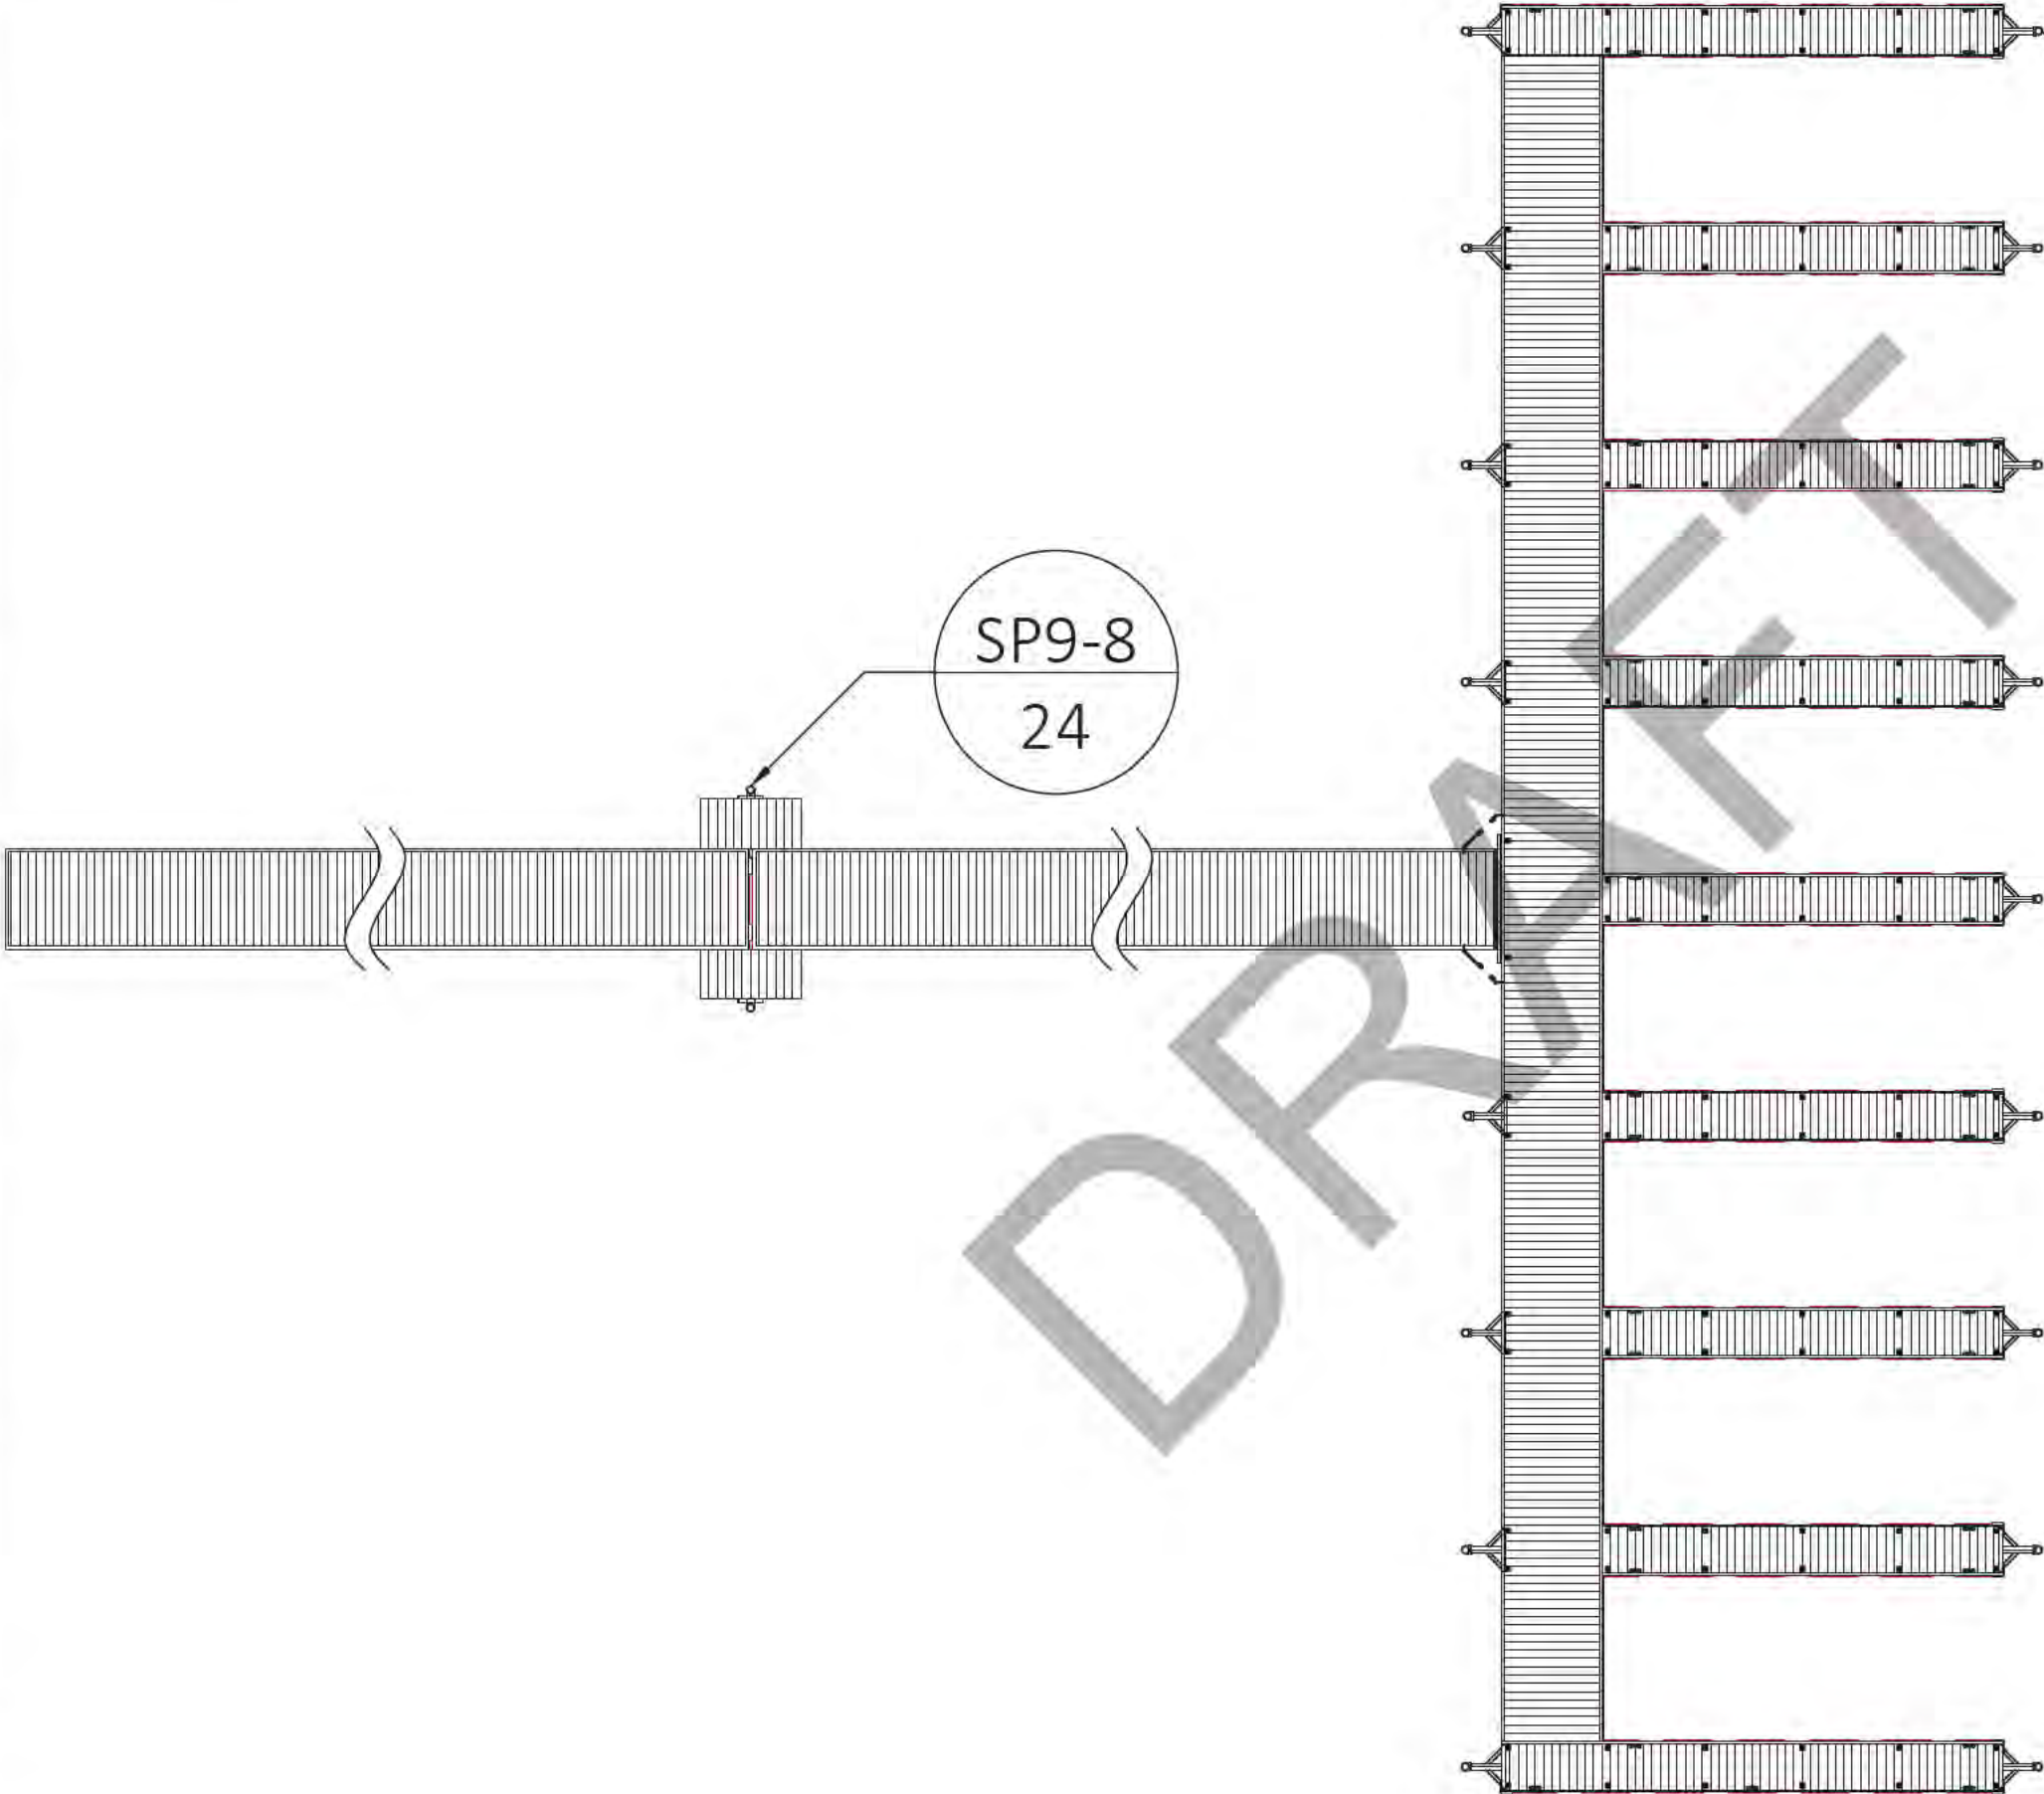
A

A



-SHEET DETAIL-		8 SLIP THE PENINSULA LOTS16-23.dwg FLOAT DIAGRAM			
FILE NAME/CUSTOMER ➔					
DRAWN: 9/19/2023					
CHECKED:					
MANAG.APPR:					
ISSUED TO: MANUFACTURE					
DESIGN DRAFTER: R.BAKER		SIZE B	SCALE 1:88	DWG TYPE/NO.	REV 0
FABRICATOR:					SHEET 6 OF 42

(2) 3/8"X5 1/2" H.B.
(4) 3/8"X7/8" WASHERS
(2) 3/8" NYLOCK NUTS
PER POST

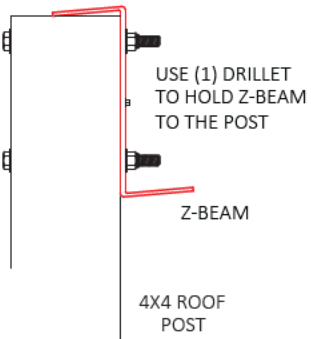

OVERHANG THE
ROOF POST 1'

Z-BEAM LAPS OVER
THE NEXT Z-BEAM 4'

30'

29'

-SHEET DETAIL-				
FILE NAME/CUSTOMER ➔		8 SLIP THE PENINSULA LOTS16-23.dwg		
DRAWN: 9/19/2023		FLOAT DIAGRAM		
CHECKED:				
MANAG.APPR:				
ISSUED TO: MANUFACTURE				
DESIGN DRAFTER: R.BAKER	SIZE B	SCALE 1:100	DWG TYPE/NO.	REV 0
FABRICATOR:				SHEET 7 OF 42

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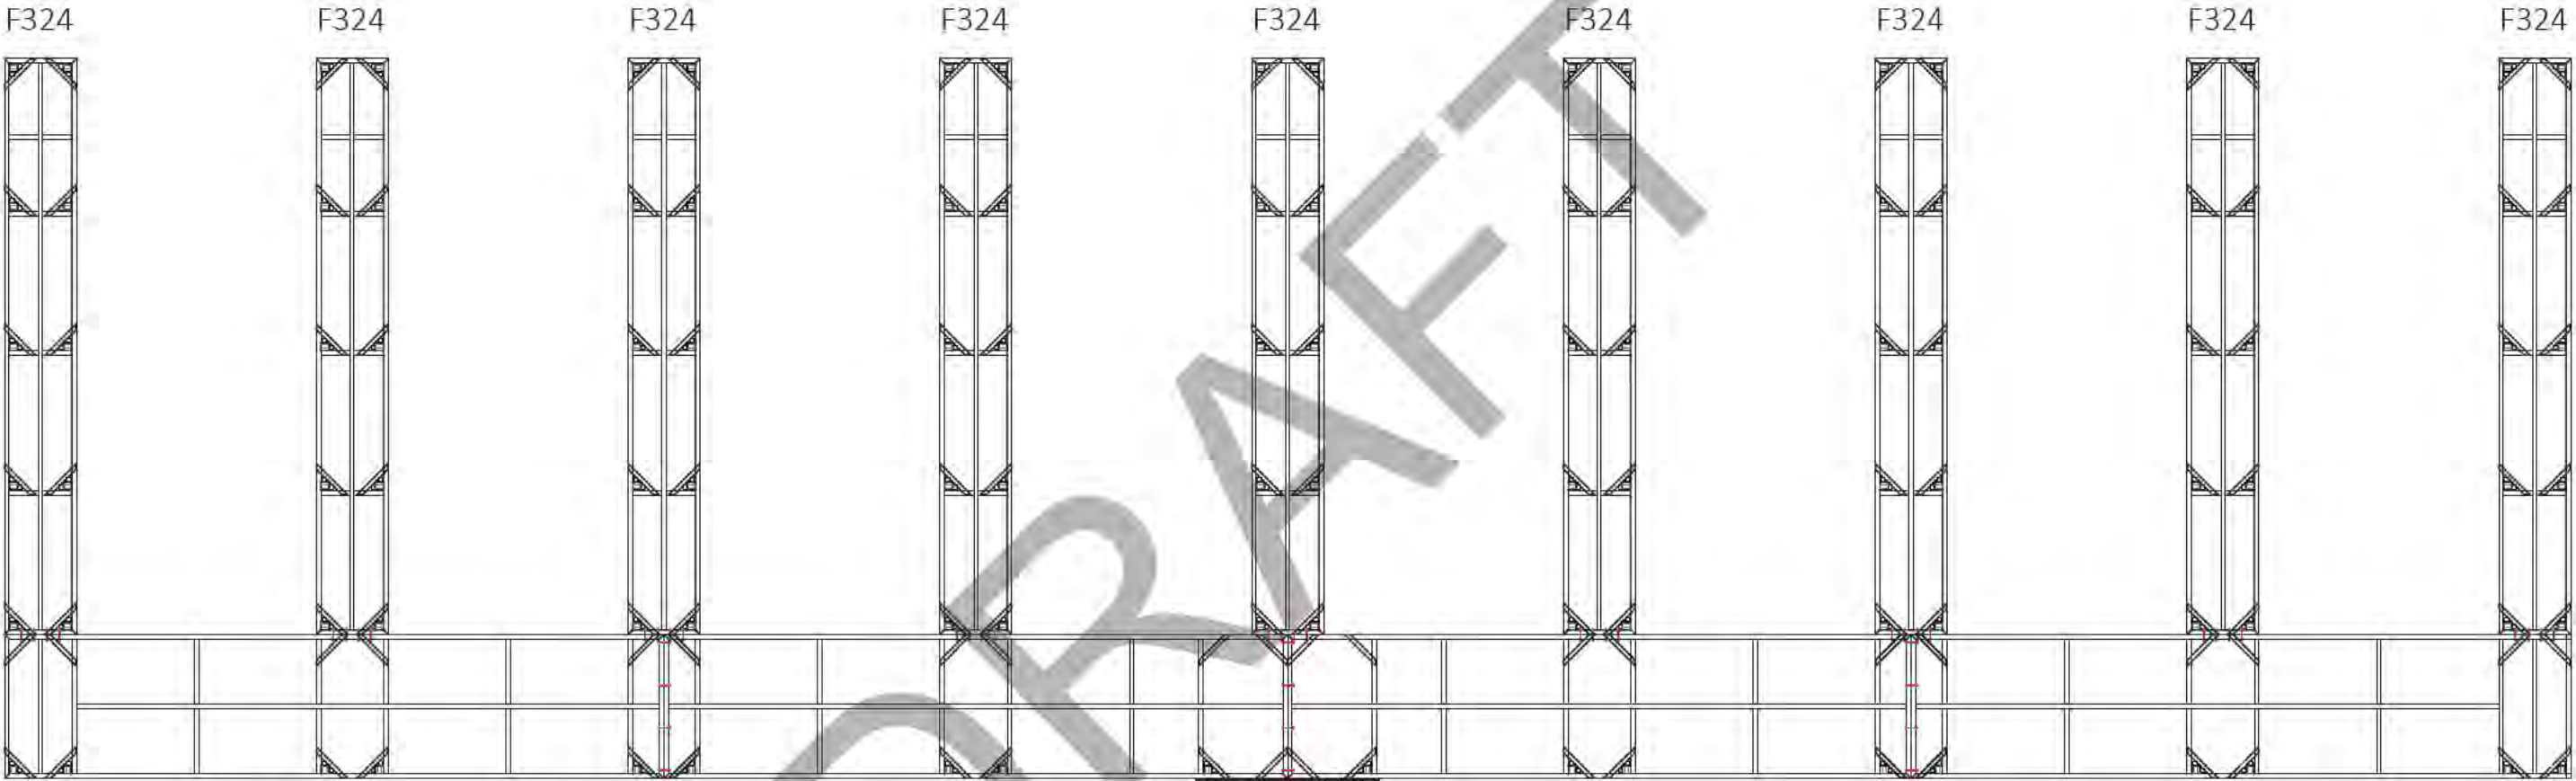
C

B

B

A

A



BW627.5-L

BW626

BW626-R

BW627.5-R

-SHEET DETAIL-					
FILE NAME/CUSTOMER ➔		8 SLIP THE PENINSULA LOTS16-23.dwg			
DRAWN: 9/19/2023		FLOAT DIAGRAM			
CHECKED:					
MANAG.APPR:					
ISSUED TO: MANUFACTURE					
DESIGN DRAFTER: R.BAKER		SIZE B	SCALE 1:88	DWG TYPE/NO.	REV 0
FABRICATOR:					SHEET 8 OF 42

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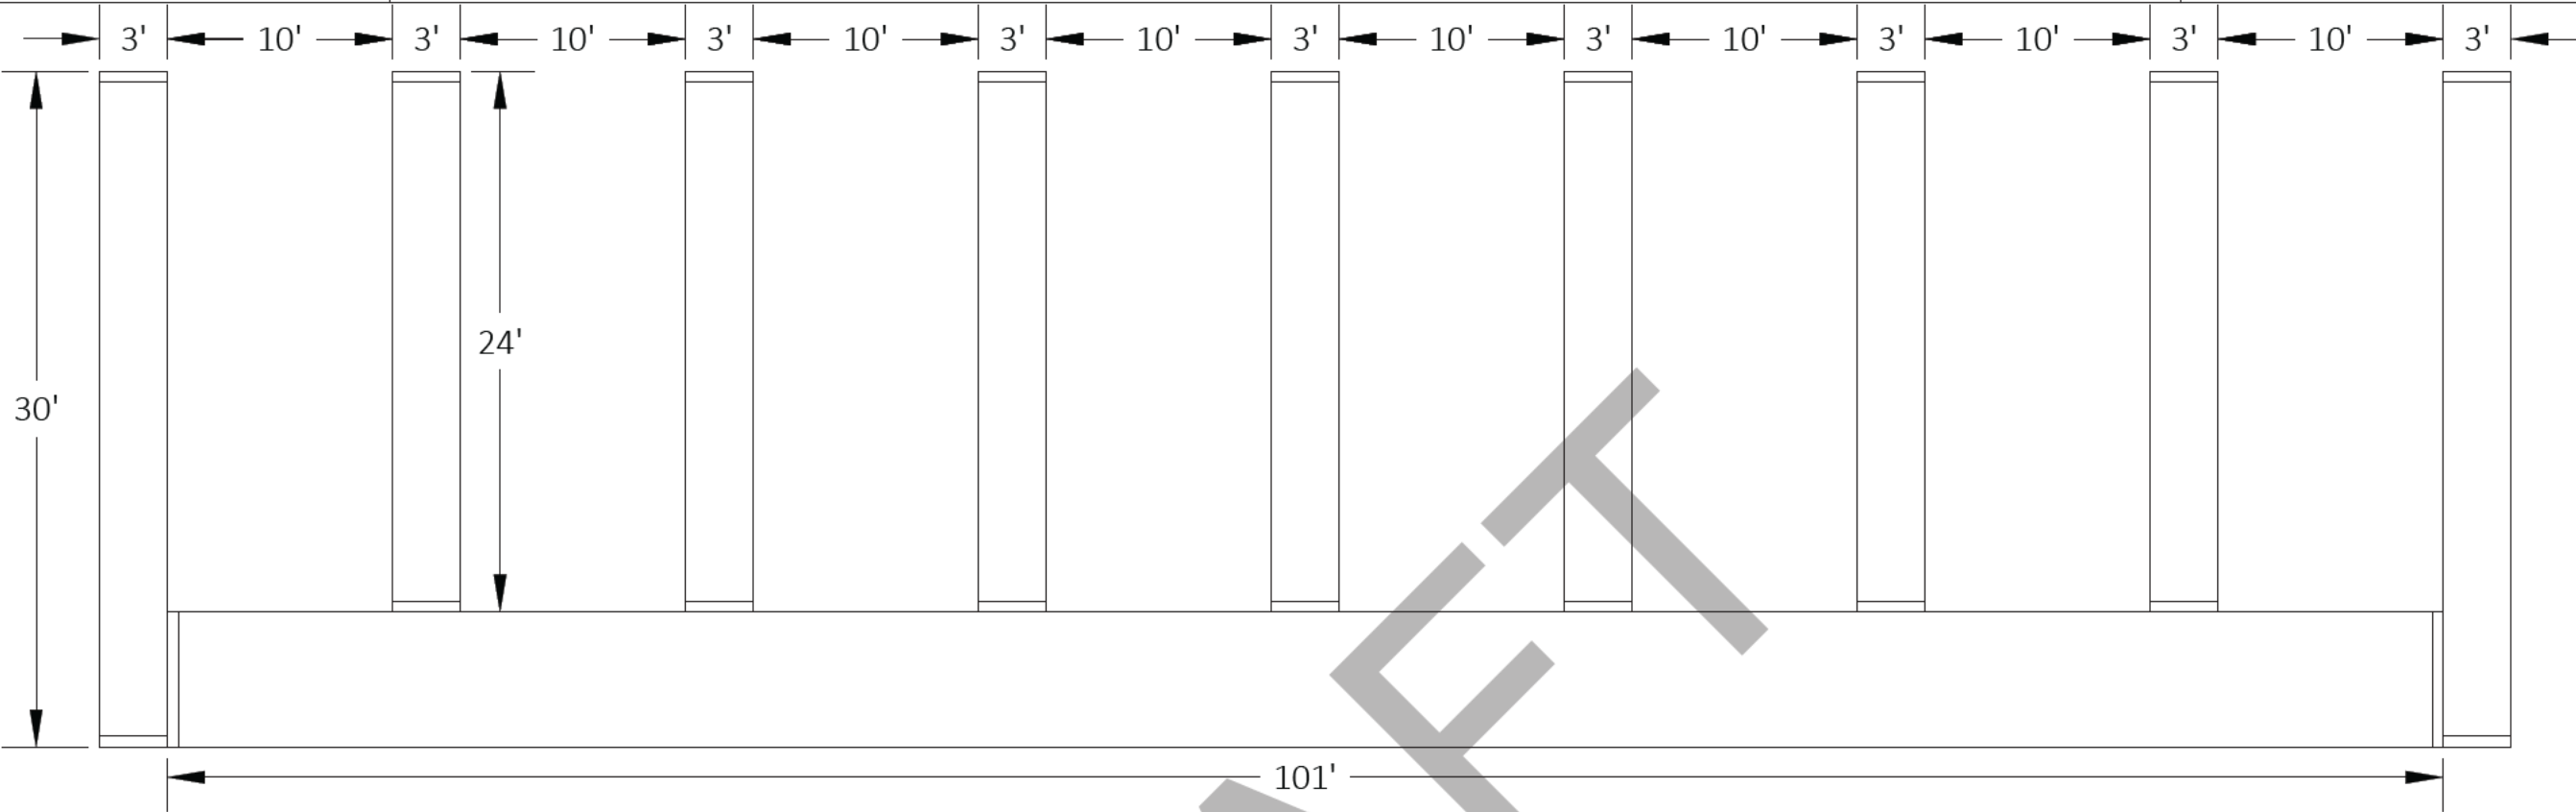
C

B

B

A


A



DECKING CUT LIST		
QTY.	DESCRIPTION	COLOR
438	35-1/2" LOCKDRY MAINS	
200	5' 11-1/2" LOCKDRY MAINS	
9	35-1/2" LOCKDRY STARTER	
1	5' 11-1/2" LOCKDRY STARTER	
9	35-1/2" LOCKDRY FINISHER	
1	5' 11-1/2" LOCKDRY FINISHER	

-SHEET DETAIL-		8 SLIP THE PENINSULA LOTS16-23.dwg			
FILE NAME/CUSTOMER ➔					
DRAWN: 9/19/2023					
CHECKED:					
MANAG.APPR:		FLOAT DIAGRAM			
ISSUED TO: MANUFACTURE					
DESIGN DRAFTER: R.BAKER		SIZE B	SCALE 1:100	DWG TYPE/NO.	REV 0
FABRICATOR:				SHEET 9 OF 42	



CUT/STOCK LIST						
DIE NUMBER	ITEM	QTY.	DESCRIPTION	FT.	IN.	TOTAL FT.
FH-07803	A	36	4"X4" POST	10	2	366.0000
FH-07803	B	18	4"X4" POST	10	8-1/16	192.0938
FH-07803	C	18	4"X4" POST	11	2-3/16	201.2813
FH-07803	D	18	4"X4" POST	11	2 3/8	201.5625
FH-07803	E	18	4"X4" POST	10	8 1/4	192.3750

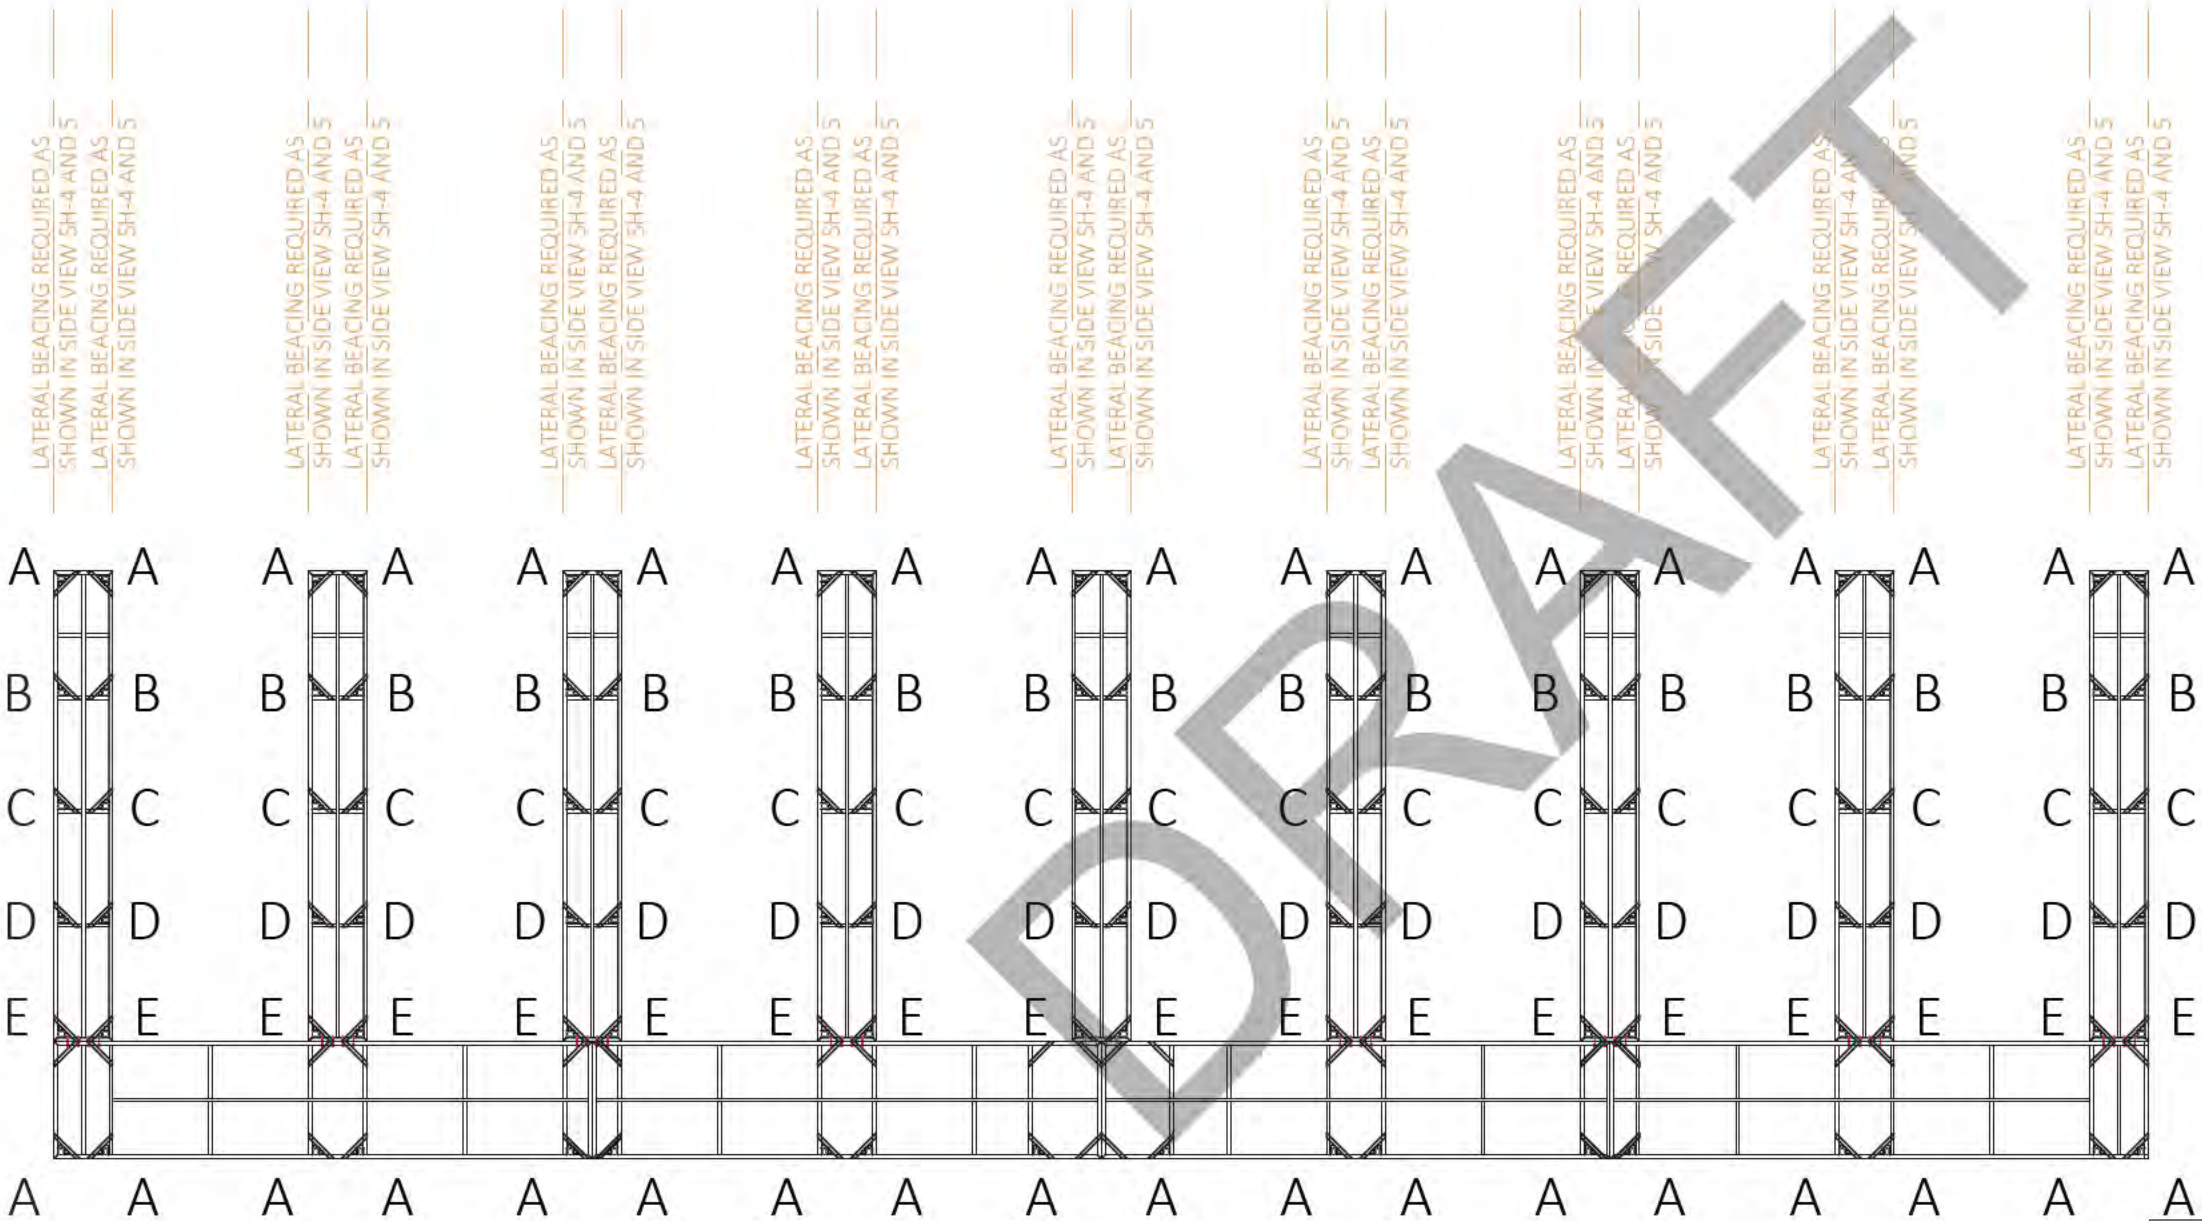

-SHEET DETAIL-		8 SLIP THE PENINSULA LOTS16-23.dwg			
FILE NAME/CUSTOMER ➔					
DRAWN: 9/19/2023					
CHECKED:					
MANAG.APPR:					
ISSUED TO: MANUFACTURE		POST DIAGRAM			
DESIGN DRAFTER: R.BAKER					
FABRICATOR:					
SIZE	SCALE	DWG TYPE/NO.		REV	
B	1:120			0	
				SHEET 10 OF 42	

CUT LIST							
DIE NUMBER	ITEM	QTY.	DESCRIPTION	DEGREE	FT	IN	TOTAL FT
FS-084499	A	2	10" H.W.	45°-45°	27	6"	55.000000
FS-084499	B	2	10" H.W.	45°-45°	6	0"	12.000000
FS-084499	C	1	10" H.W.	0°-0°	5	7 1/2"	#####
FS-04306	D	5	8" L.W.	0°-0°	5	7 1/2"	#####
FH-07805	E	5	CORNER SLEEVE	0°-0°		10"	4.166667
FH-00487	F	20	1"X2" GUSSET	45°-45°	1	9 13/16"	#####
FH-01356	G	1	1/8" X 2" X 2" TUBE	0°-0°	24	3 3/4"	#####
FH-01356	H	1	1/8" X 2" X 2" TUBE	0°-0°	5	7 1/2"	#####
F-04774	I	10	2" X 2" ANGLE	0°-0°		2"	1.666667



NOTE:
USE .375 WELD OF APPROPRIATE TYPE PER
SHOP STANDARD (TYP.) OR AS NOTED

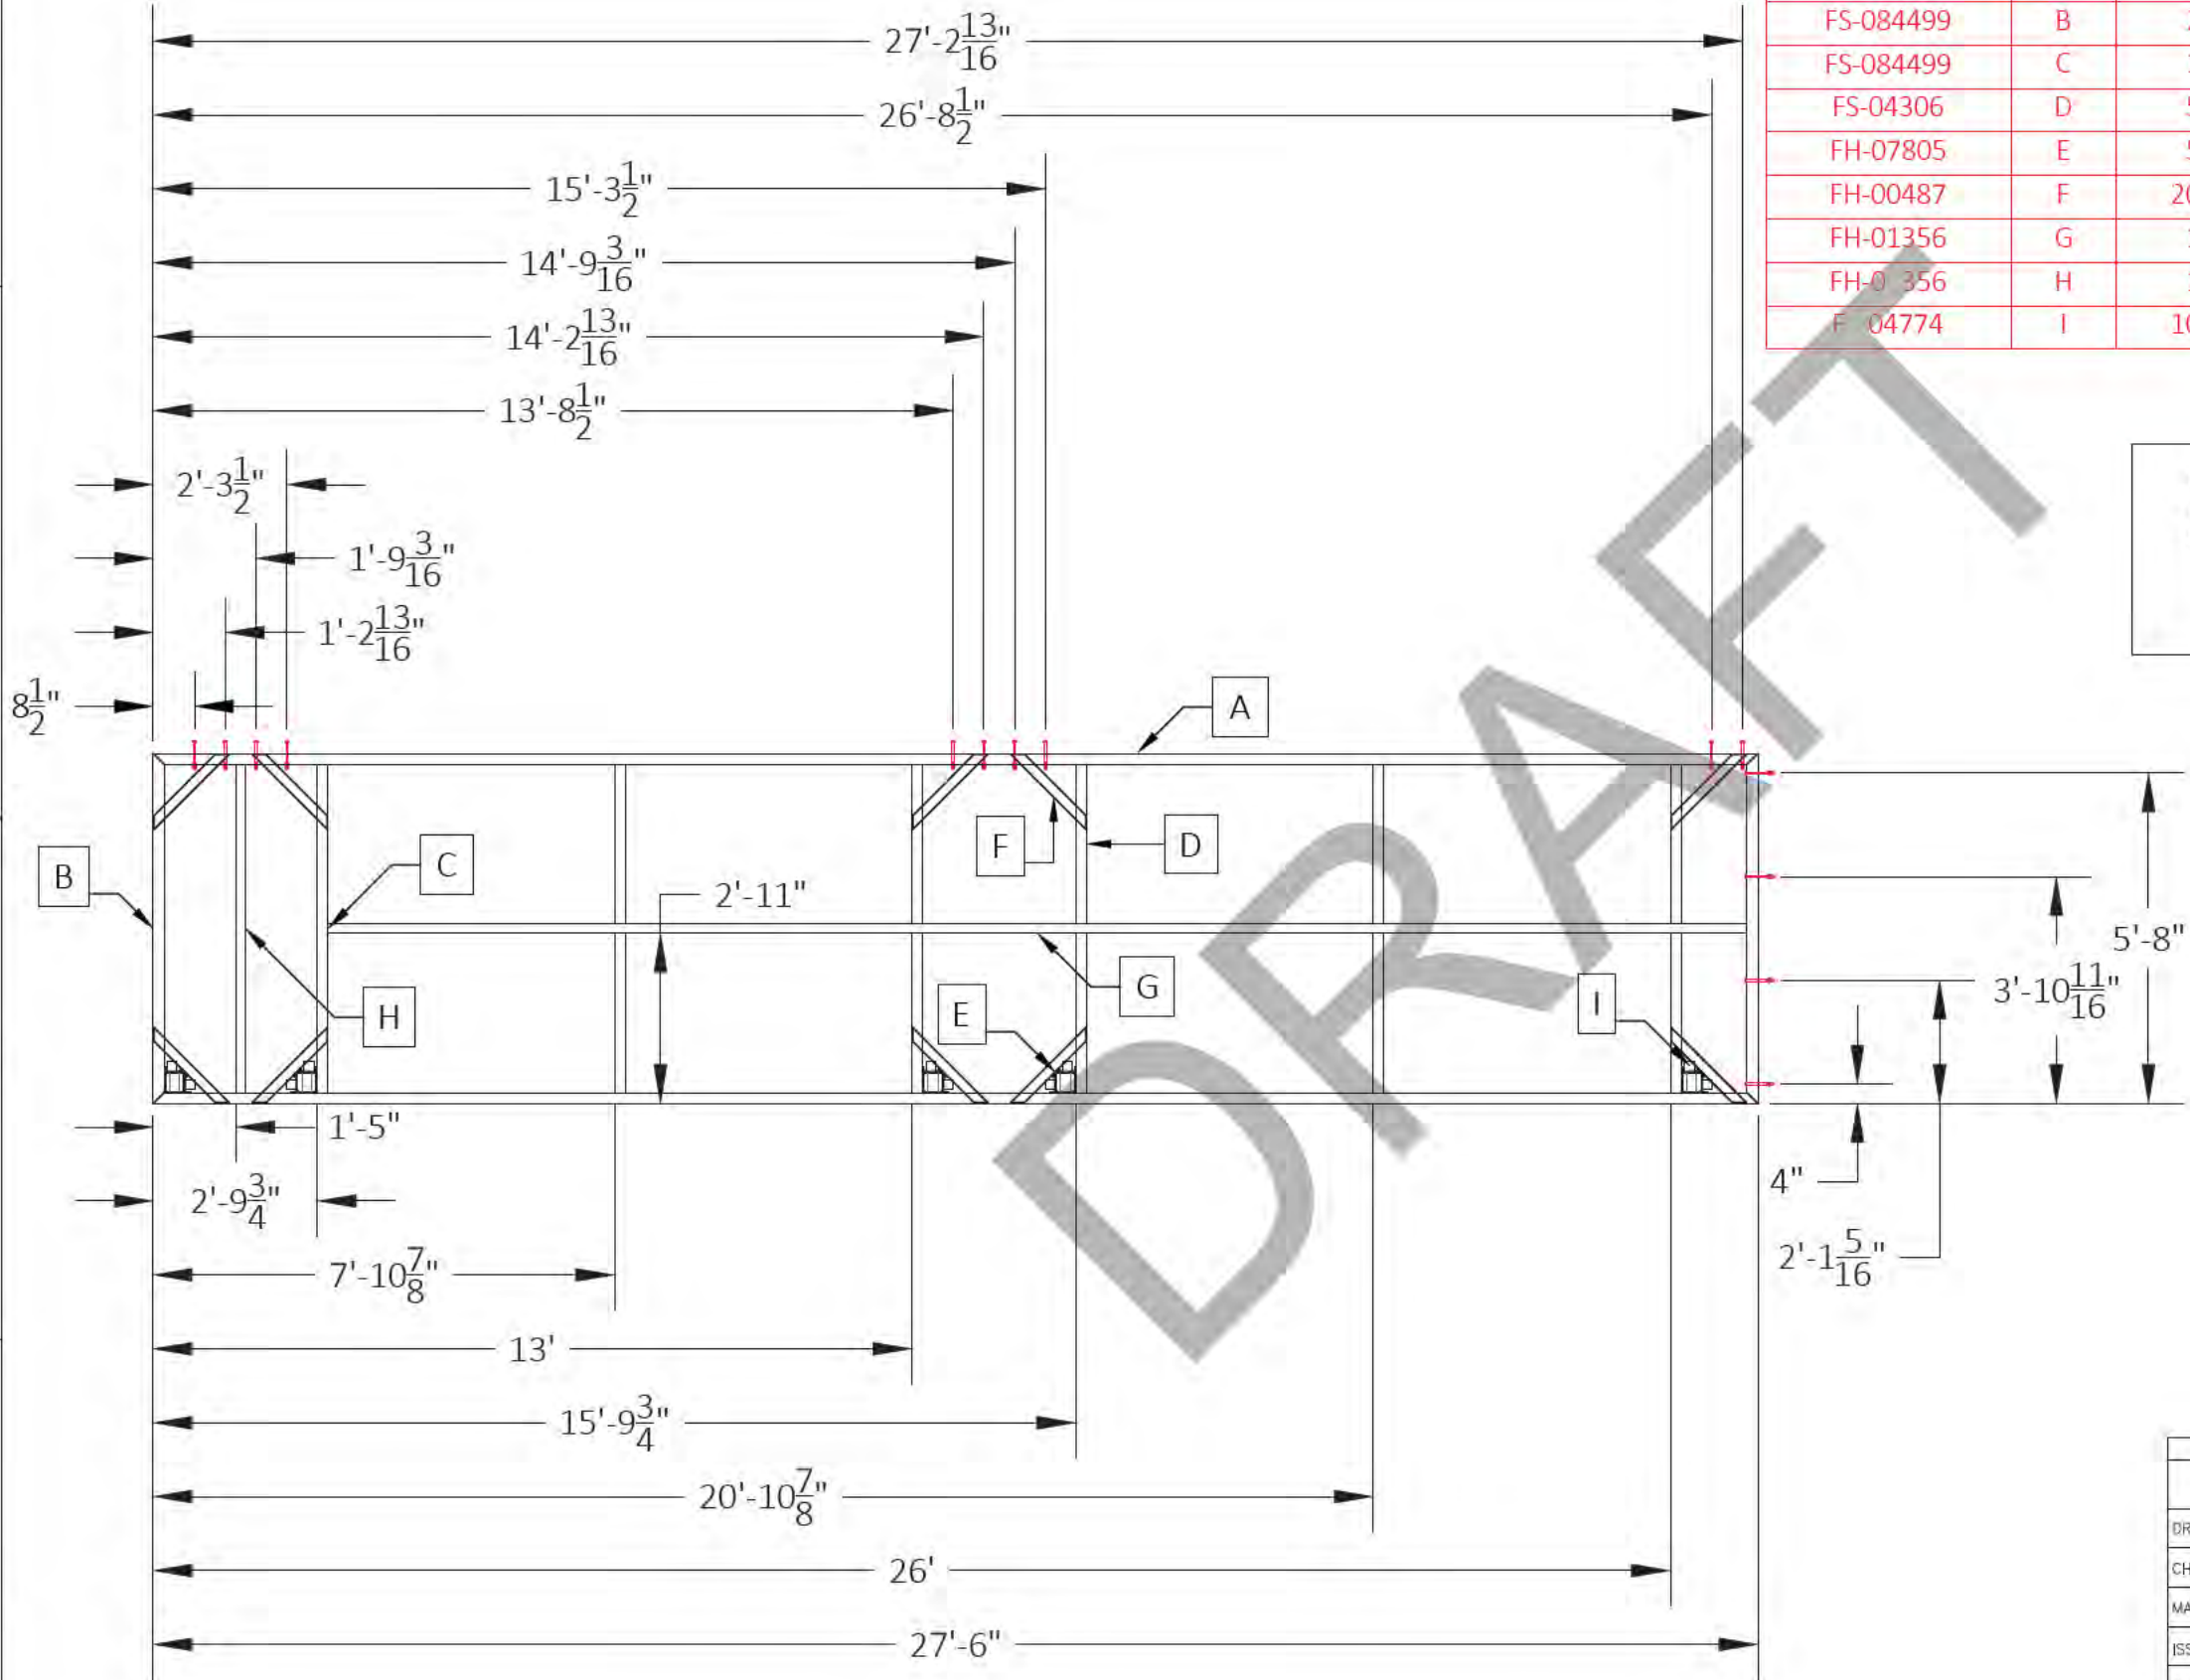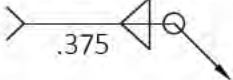

-SHEET DETAIL-					
FILE NAME/CUSTOMER ➔		8 SLIP THE PENINSULA LOTS16-23.dwg			
DRAWN: 9/19/2023		BW627.5-L			
CHECKED:					
MANAG. APPR:					
ISSUED TO: MANUFACTURE					
DESIGN DRAFTER: R. BAKER		SIZE B	SCALE 1:40	DWG TYPE/NO.	REV 0
FABRICATOR:					SHEET 11 OF 42

CUT LIST							
DIE NUMBER	ITEM	QTY.	DESCRIPTION	DEGREE	FT	IN	TOTAL FT
FS-084499	A	2	10" H.W.	45°-45°	26	0	52.000000
FS-084499	B	2	10" H.W.	45°-45°	6	0"	12.000000
FS-04306	C	6	8" L.W.	0°-0°	5	7 1/2"	#####
FH-07805	D	4	CORNER SLEEVE	0°-0°		10"	3.333333
FH-00487	E	20	1"X2" GUSSET	45°-45°	1	9 13/16"	#####
FH-01356	F	1	1/8" X 2" X 2" TUBE	0°-0°	25	7 1/2"	#####
FS-04774	G	16	2" X 2" ANGLE	0°-0°		2"	2.666667

NOTE:
USE .375 WELD OF APPROPRIATE TYPE PER
SHOP STANDARD (TYP.) OR AS NOTED

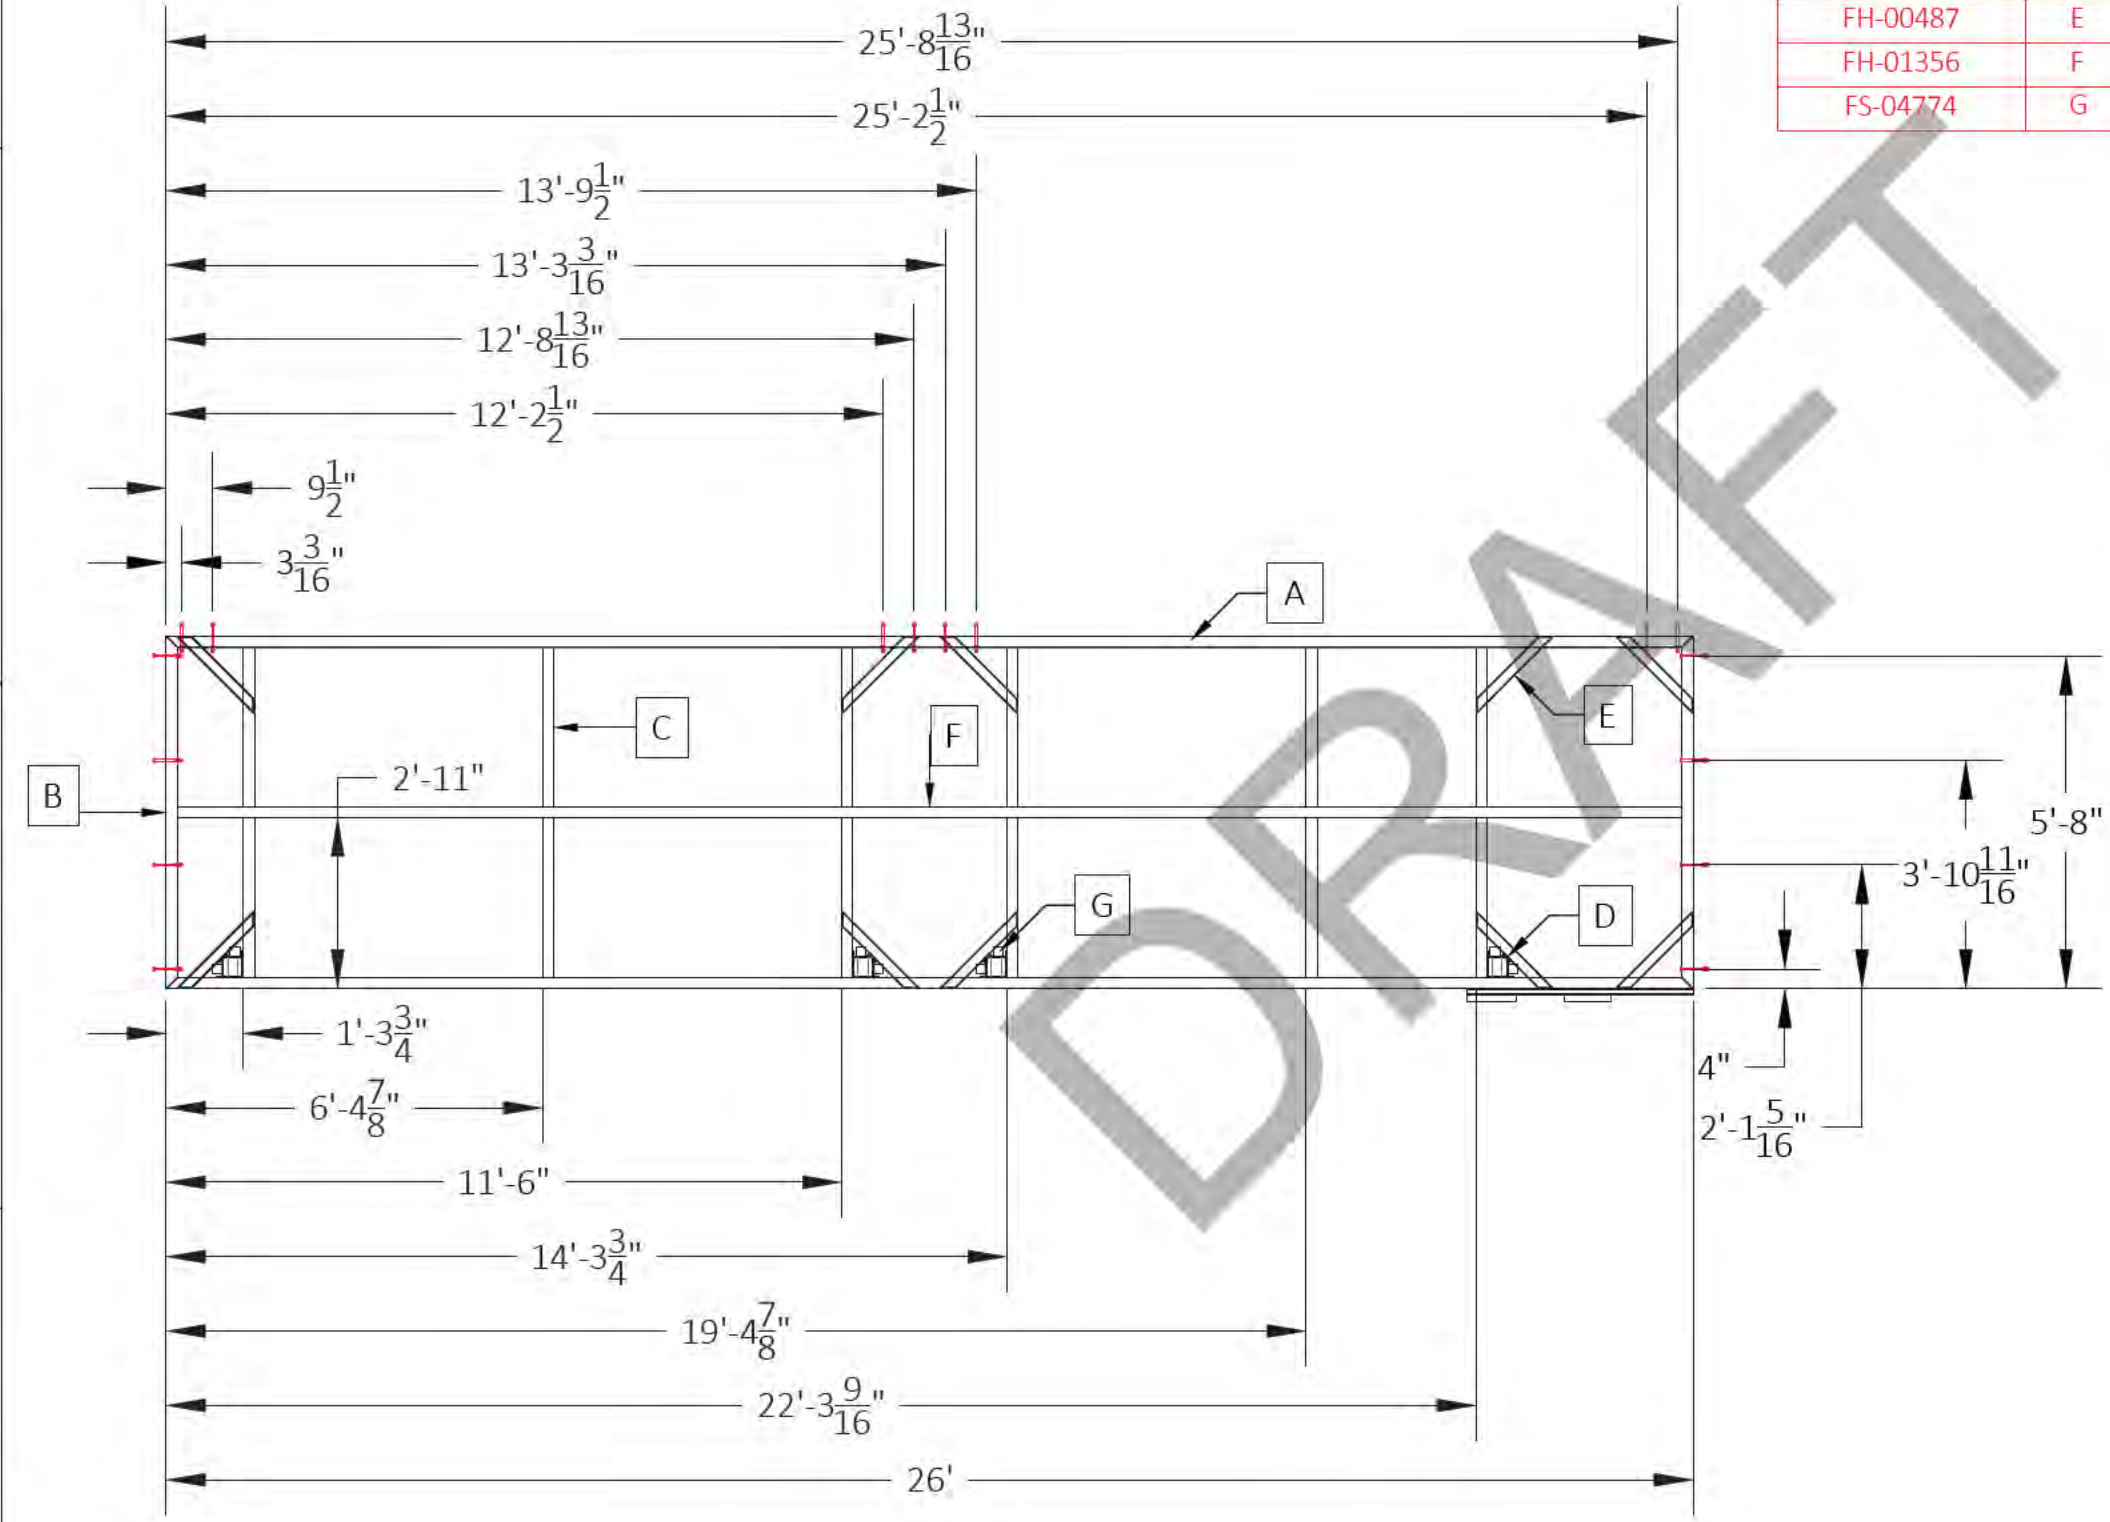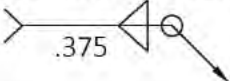




-SHEET DETAIL-					
FILE NAME/CUSTOMER ➔		8 SLIP THE PENINSULA LOTS16-23.dwg			
DRAWN: 9/19/2023		BW626-L			
CHECKED:					
MANAG.APPR:					
ISSUED TO: MANUFACTURE					
DESIGN DRAFTER: R.BAKER		SIZE B	SCALE 1:40	DWG TYPE/NO.	REV 0
FABRICATOR:					SHEET 12 OF 42

CUT LIST							
DIE NUMBER	ITEM	QTY.	DESCRIPTION	DEGREE	FT	IN	TOTAL FT
FH-07812	A	1	RAMP PIPE	0°-0°		10"	0.83
FH-07812	B	1	RAMP PIPE	0°-0°		9 9/16"	####
FS-07813	C	1	RAMP TRACK	0°-0°	3	10 1/8"	####
FS-08499	D	1	10" H.W.	0°-0°		7"	0.58
FS-00431	E	1	8" H.W.	0°-0°		7"	0.58

*MEASUREMENTS MUST BE EXACT!

WELD THE RAMP
TRACK TO THE FRAME!!

NOTE:
USE .375 WELD OF APPROPRIATE TYPE PER
SHOP STANDARD (TYP.) OR AS NOTED

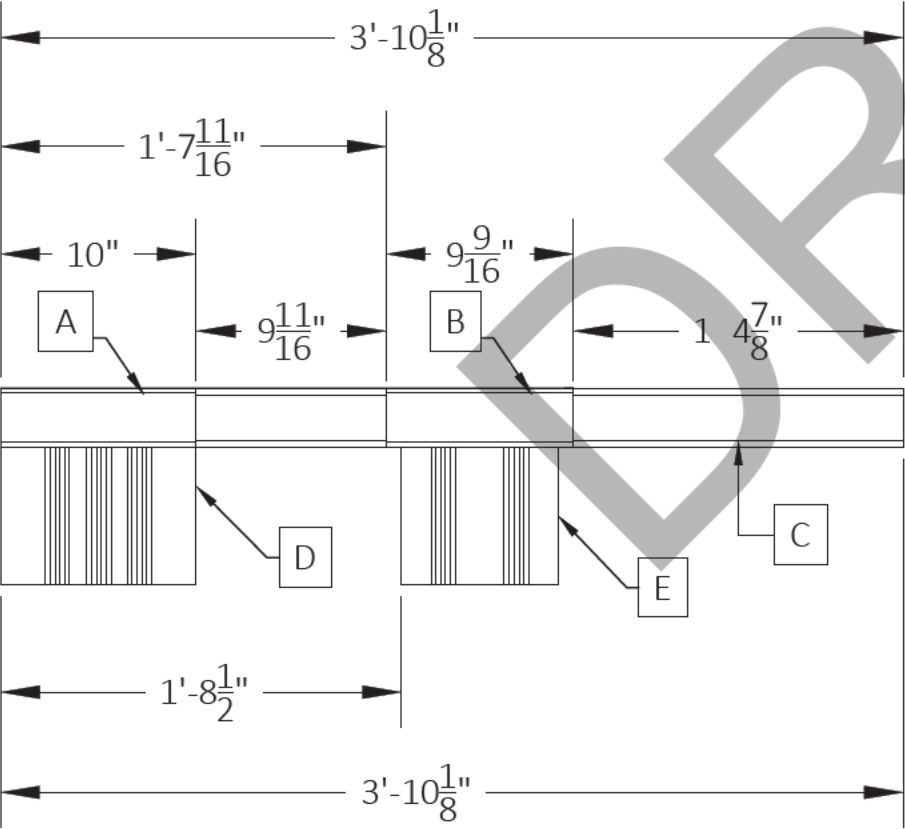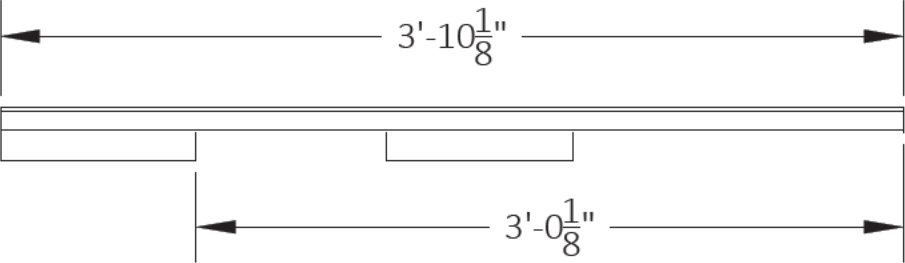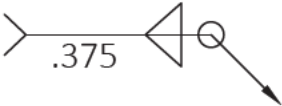

-SHEET DETAIL-					
FILE NAME/CUSTOMER ➔		8 SLIP THE PENINSULA LOTS16-23.dwg			
DRAWN: 9/19/2023		BW626-L ATTACHMENT SHEET			
CHECKED:					
MANAG.APPR:					
ISSUED TO: MANUFACTURE					
DESIGN DRAFTER: R.BAKER		SIZE B	SCALE 1:10	DWG TYPE/NO.	REV 0
FABRICATOR:				SHEET 13 OF 42	


CUT LIST							
DIE NUMBER	ITEM	QTY.	DESCRIPTION	DEGREE	FT	IN	TOTAL FT
FS-084499	A	2	10" H.W.	45°-45°	26	0	52.000000
FS-084499	B	2	10" H.W.	45°-45°	6	0"	12.000000
FS-04306	C	6	8" L.W.	0°-0°	5	7 1/2"	#####
FH-07805	D	4	CORNER SLEEVE	0°-0°		10"	3.333333
FH-00487	E	20	1"X2" GUSSET	45°-45°	1	9 13/16"	#####
FH-01356	F	1	1/8" X 2" X 2" TUBE	0°-0°	25	7 1/2"	#####
FS-01174	G	16	2" X 2" ANGLE	0°-0°		2"	2.666667

NOTE:
USE .375 WELD OF APPROPRIATE TYPE PER
SHOP STANDARD (TYP.) OR AS NOTED

>

.375

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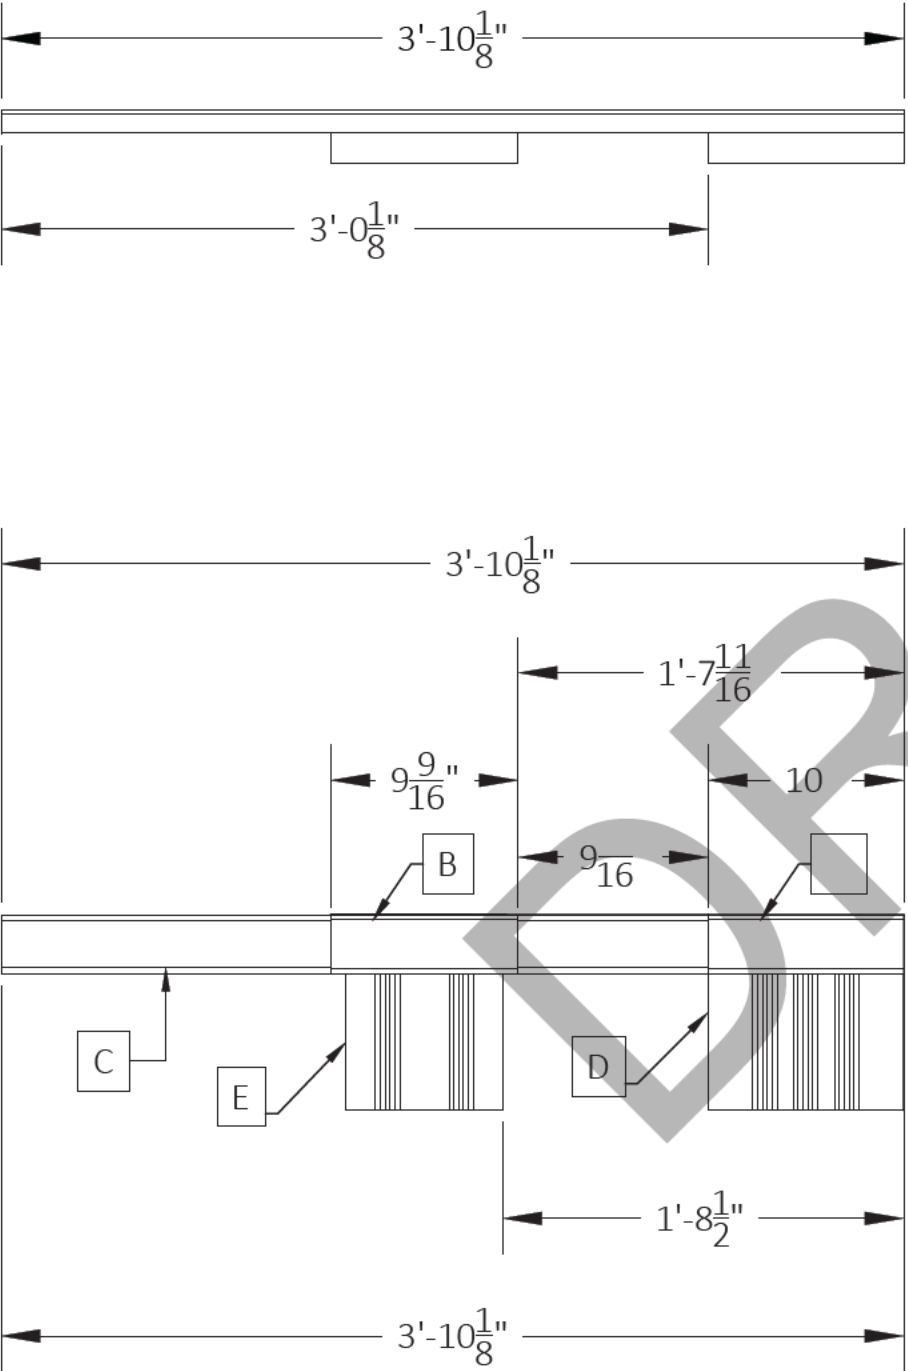
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FILE NAME/CUSTOMER ➔		8 SLIP THE PENINSULA LOTS16-23.dwg			
DRAWN: 9/19/2023		BW626-R			
CHECKED:					
MANAG.APPR:					
ISSUED TO: MANUFACTURE					
DESIGN DRAFTER: R.BAKER		SIZE B	SCALE 1:40	DWG TYPE/NO.	REV 0
FABRICATOR:					SHEET 14 OF 42

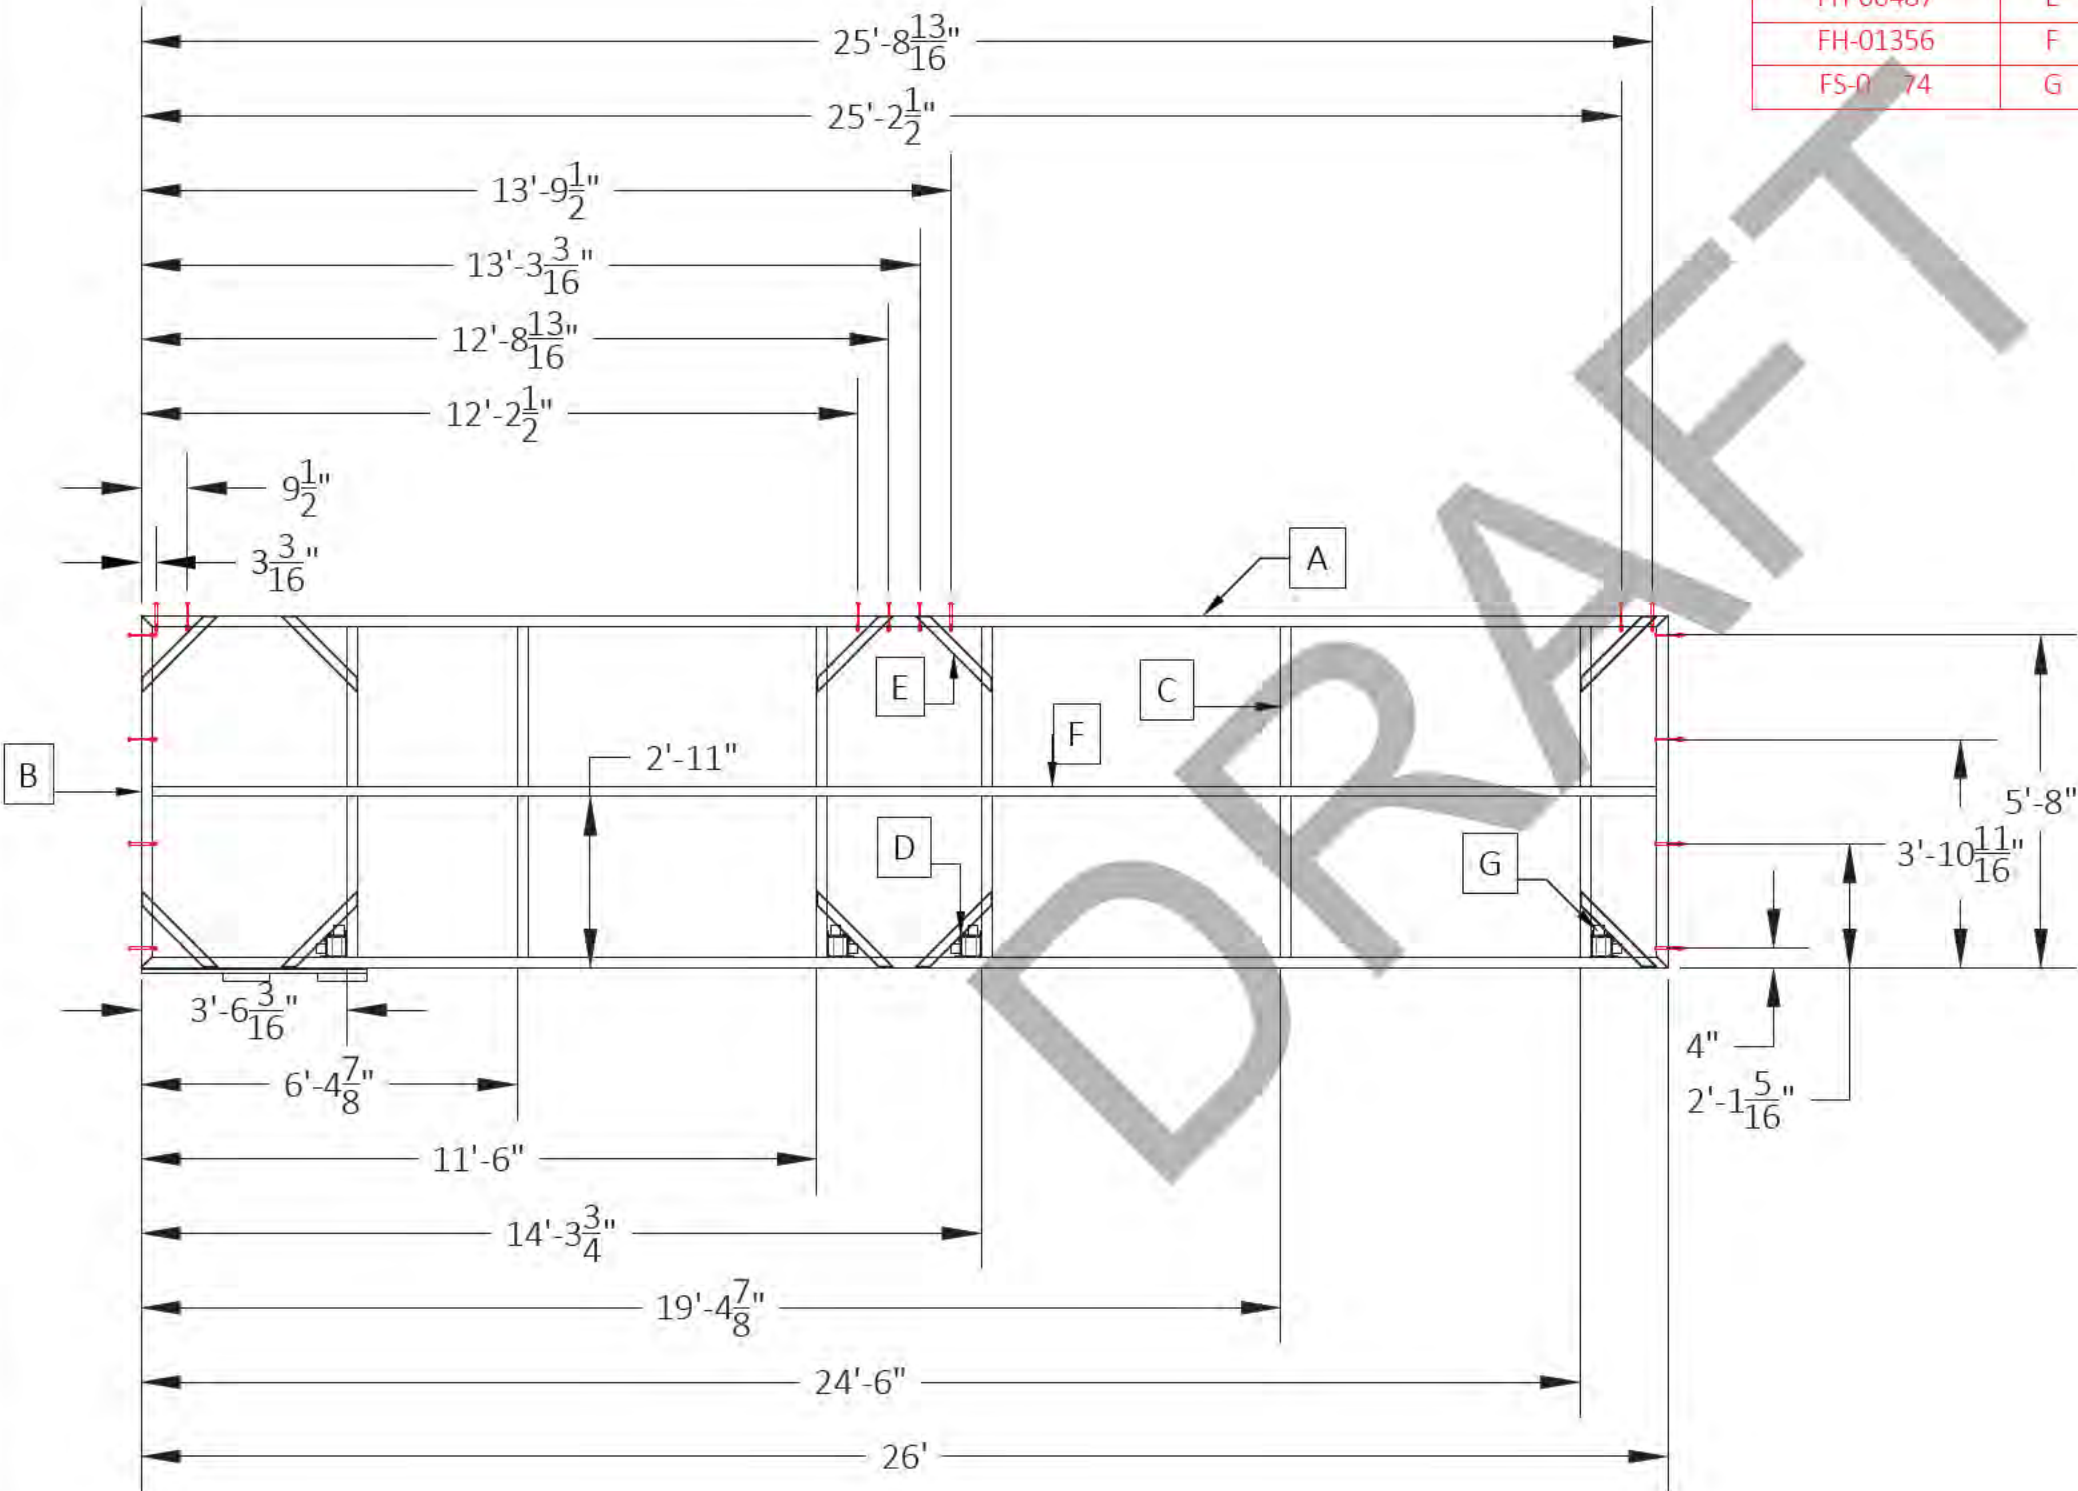CUT LIST							
DIE NUMBER	ITEM	QTY.	DESCRIPTION	DEGREE	FT	IN	TOTAL FT
FH-07812	A	1	RAMP PIPE	0°-0°		10"	0.83
FH-07812	B	1	RAMP PIPE	0°-0°		9 9/16"	####
FS-07813	C	1	RAMP TRACK	0°-0°	3	10 1/8"	####
FS-08499	D	1	10" H.W.	0°-0°		7"	0.58
FS-00431	E	1	8" H.W.	0°-0°		7"	0.58

*MEASUREMENTS MUST BE EXACT!

WELD THE RAMP
TRACK TO THE FRAME!!



NOTE:
USE .375 WELD OF APPROPRIATE TYPE PER
SHOP STANDARD (TYP.) OR AS NOTED



-SHEET DETAIL-					
FILE NAME/CUSTOMER ➔		8 SLIP THE PENINSULA LOTS16-23.dwg			
DRAWN: 9/19/2023		BW626-R ATTACHMENT SHEET			
CHECKED:					
MANAG.APPR:					
ISSUED TO: MANUFACTURE					
DESIGN DRAFTER: R.BAKER		SIZE B	SCALE 1:10	DWG TYPE/NO.	REV 0
FABRICATOR:					SHEET 15 OF 42


CUT LIST							
DIE NUMBER	ITEM	QTY.	DESCRIPTION	DEGREE	FT	IN	TOTAL FT
FS-084499	A	2	10" H.W.	45°-45°	27	6"	55.000000
FS-084499	B	2	10" H.W.	45°-45°	6	0"	12.000000
FS-084499	C	1	10" H.W.	0°-0°	5	7 1/2"	#####
FS-04306	D	5	8" L.W.	0°-0°	5	7 1/2"	#####
FH-07805	E	5	CORNER SLEEVE	0°-0°		10"	4.166667
FH-00487	F	20	1"X2" GUSSET	45°-45°	1	9 13/16"	#####
FH-01356	G	1	1/8" X 2" X 2" TUBE	0°-0°	24	3 3/4"	#####
FH-01356	H	1	1/8" X 2" X 2" TUBE	0°-0°	5	7 1/2"	#####
FS-04774	I	10	2" X 2" ANGLE	0°-0°		2"	1.666667

NOTE:
USE .375 WELD OF APPROPRIATE TYPE PER
SHOP STANDARD (TYP.) OR AS NOTED

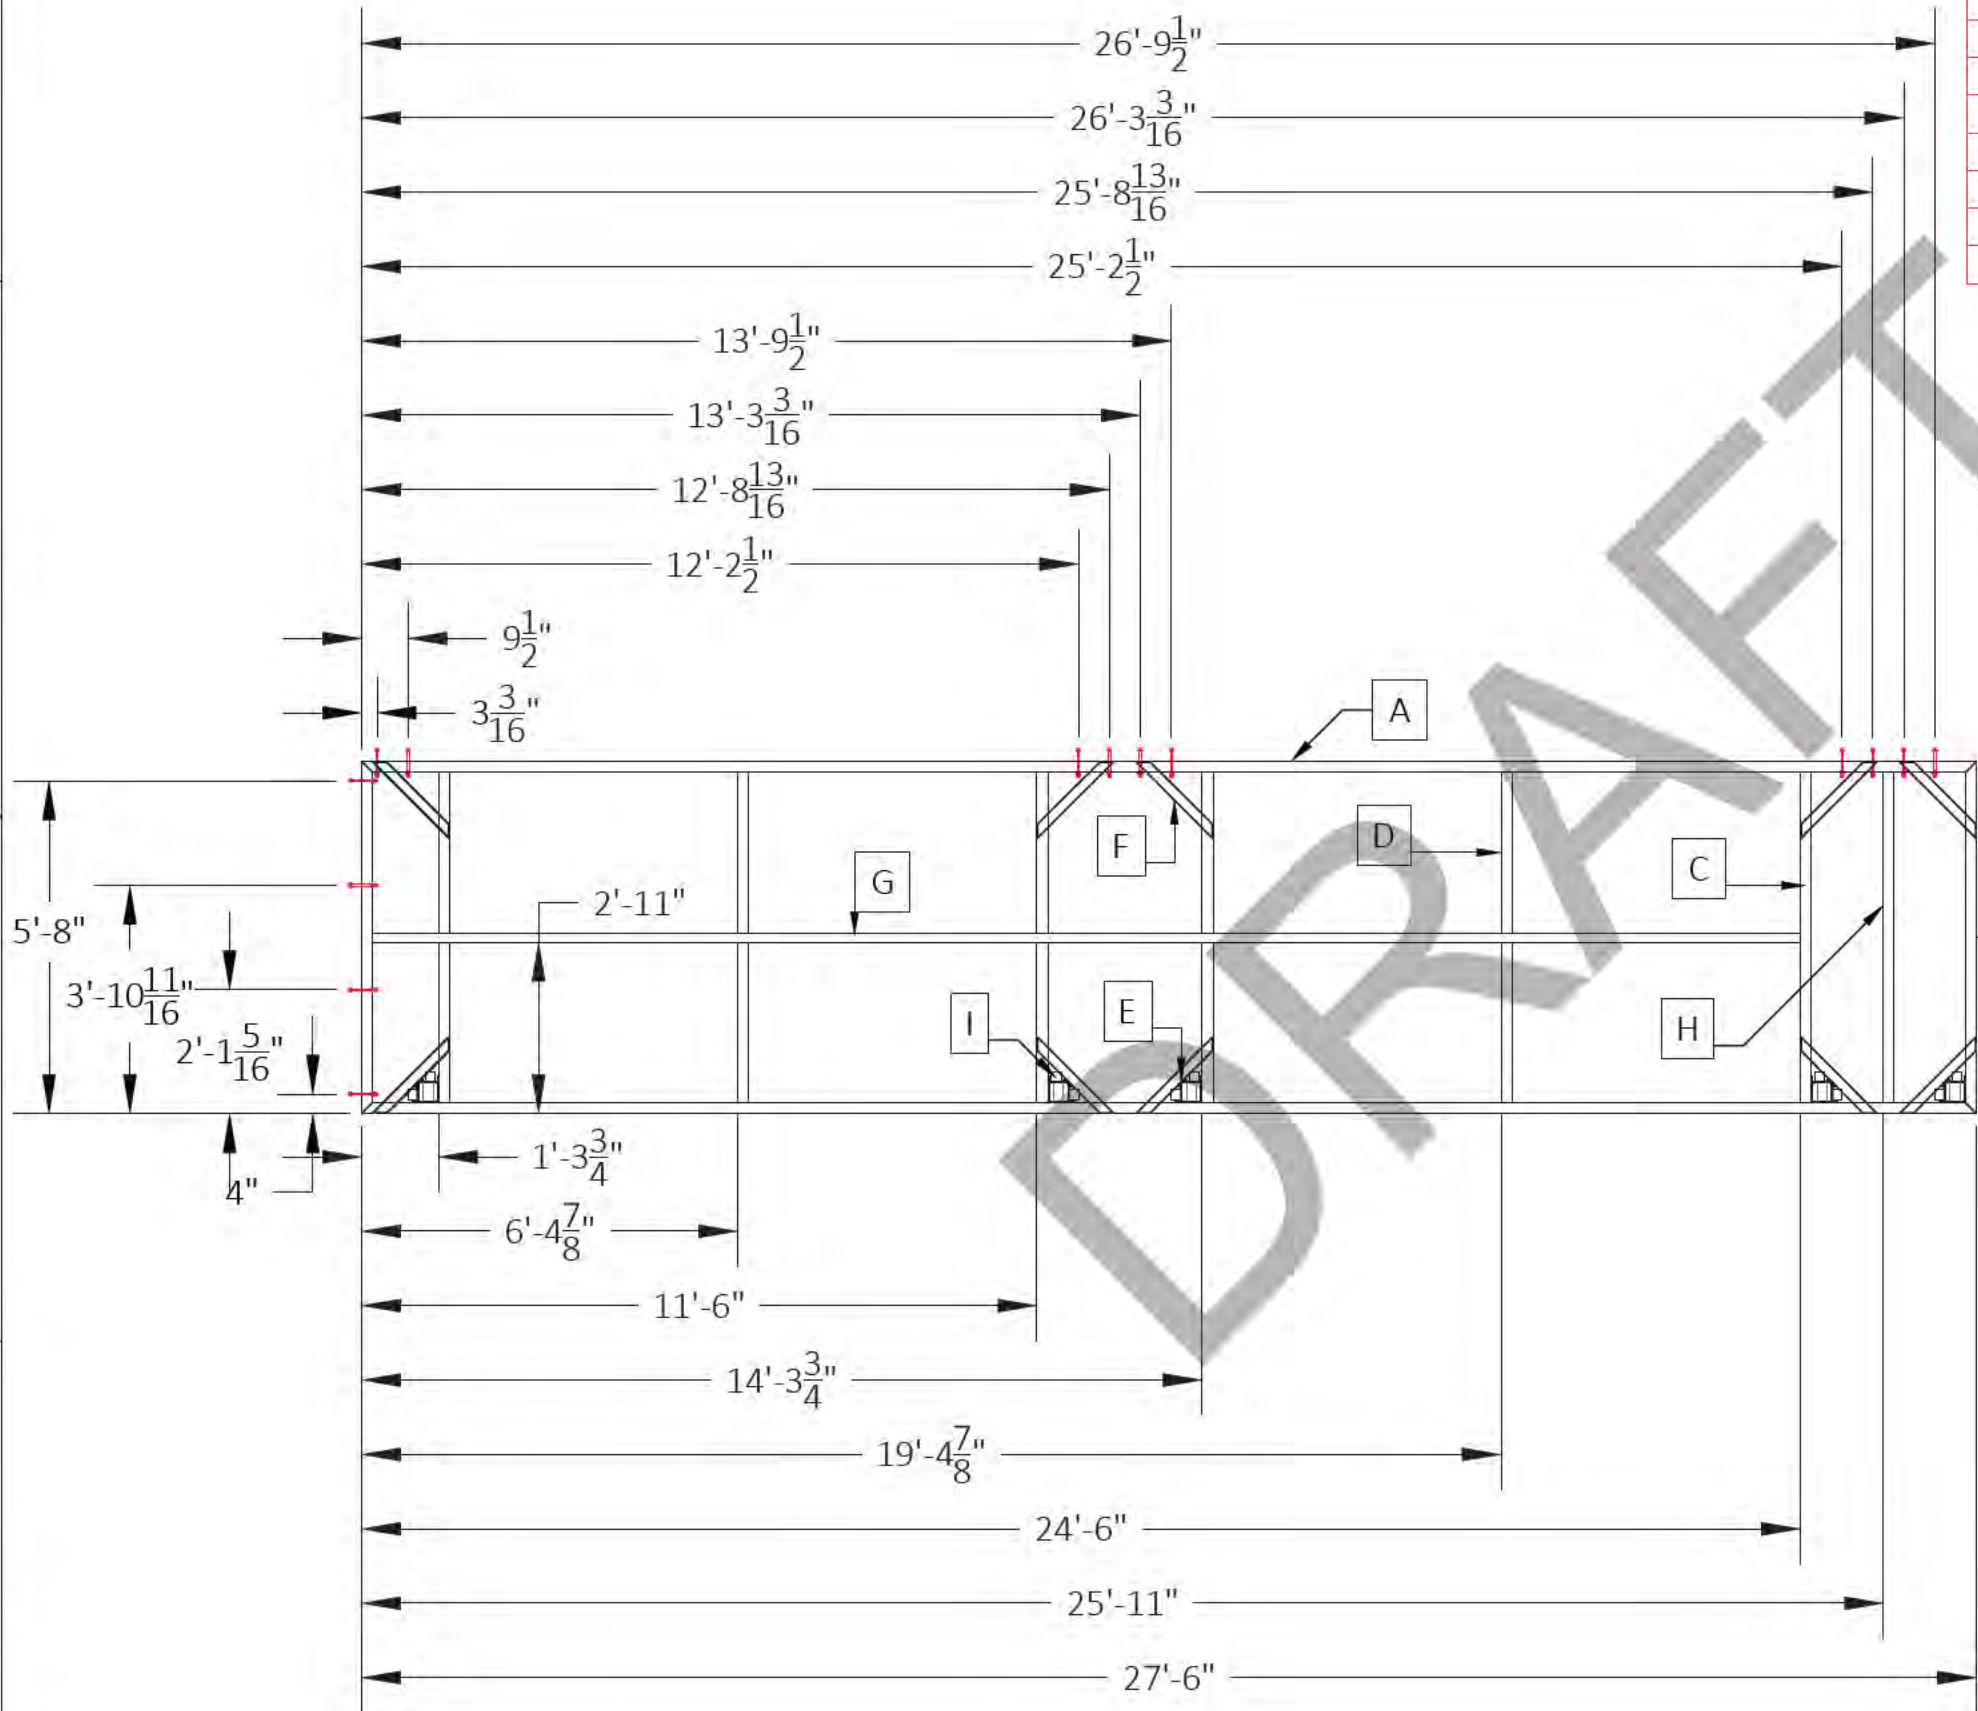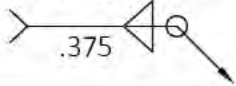

-SHEET DETAIL-					
FILE NAME/CUSTOMER ➔		8 SLIP THE PENINSULA LOTS16-23.dwg			
DRAWN: 9/19/2023		BW627.5-R			
CHECKED:					
MANAG.APPR:					
ISSUED TO: MANUFACTURE					
DESIGN DRAFTER: R.BAKER		SIZE B	SCALE 1:40	DWG TYPE/NO.	REV 0
FABRICATOR:					SHEET 16 OF 42

CUT/STOCK LIST							
DIE NUMBER	ITEM	QTY.	DESCRIPTION	DEGREE	FT.	IN.	TOTAL FT.
FS-084499	A	18	10" H.W.	45°-45°	24	0"	432.00
FS-084499	B	18	10" H.W.	45°-45°	3	0"	54.00
FS-04306	C	36	8" L.W.	0°-0°	2	7 1/2"	#####
FH-07805	D	90	CORNER SLEEVE	0°-0°		10"	75.00
FH-00487	E	180	1"X2" GUSSET	45°-45°	1	9 13/16"	#####
FH-01356	F	9	1/8" X 2" X 2" TUBE	0°-0°	23	7 1/2"	#####
S-04774	G	108	2" X 2" ANGLE	0°-0°		2"	18.00

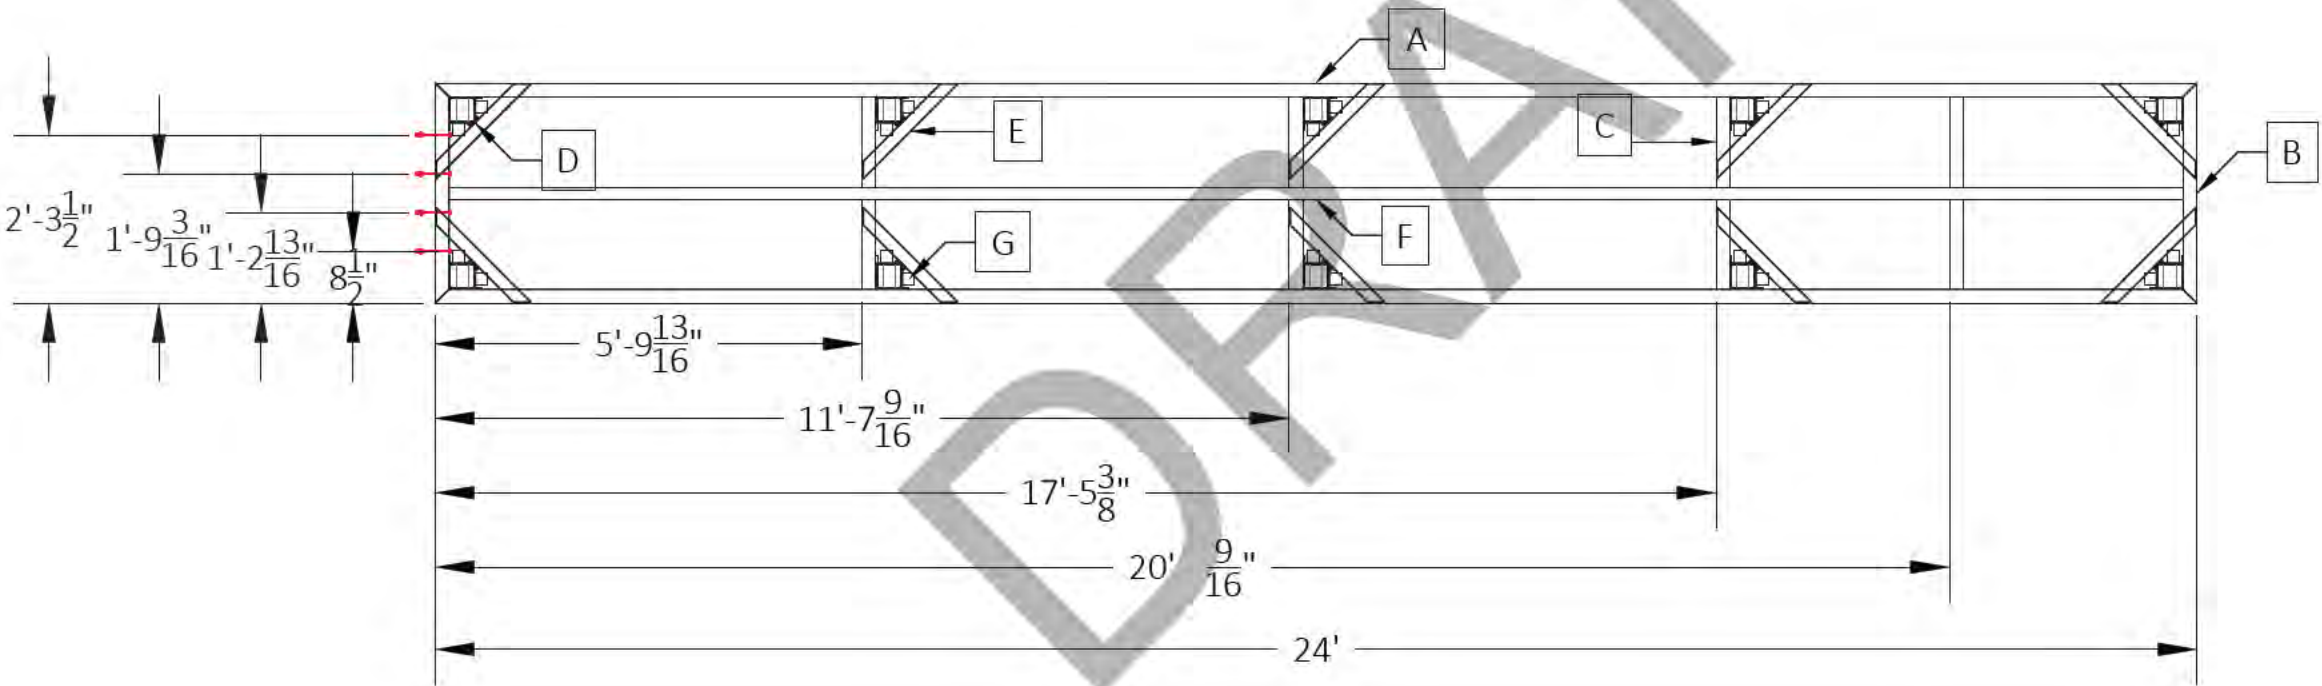

-SHEET DETAIL-					
FILE NAME/CUSTOMER ➔		8 SLIP THE PENINSULA LOTS16-23.dwg			
DRAWN: 9/19/2023		F324 9 (REQ)			
CHECKED:					
MANAG.APPR:					
ISSUED TO: MANUFACTURE					
DESIGN DRAFTER: R.BAKER		SIZE B	SCALE 1:32	DWG TYPE/NO.	REV 0
FABRICATOR:				SHEET	17 OF 42

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K-SP1
SH-7

K-1002
SH-10

INSERT STUB-UP MATERIAL AS SHOWN
IN POST TO WHICH SPUD POLE
SLEEVES ATTACH. FASTEN USING
A DRILLET TO HOLD IN PLACE
DURING INSTALLATION.
SEE SH-3C FOR SLEEVE LOCATION

DRILLET LOCATION

FLUSH WITH THE
BOTTOM OF THE POST

K-SP1 ASSEMBLIES ARE TO BE BOLTED
TO THE FRAMES AND POST AT THE
SPECIFICALLY MARKED PLACES.

-SHEET DETAIL-		8 SLIP THE PENINSULA LOTS16-23.dwg			
FILE NAME/CUSTOMER ➔					
DRAWN: 9/19/2023		8' COLLAR SIDE VIEW			
CHECKED:					
MANAG.APPR:					
ISSUED TO: MANUFACTURE					
DESIGN DRAFTER: R.BAKER		SIZE B	SCALE 1:36	DWG TYPE/NO.	REV 0
FABRICATOR:					SHEET 18 OF 42

D

D

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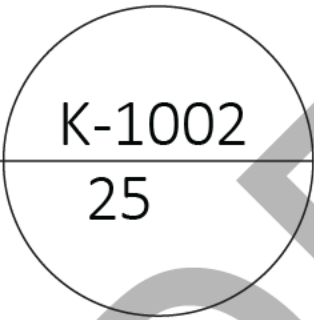
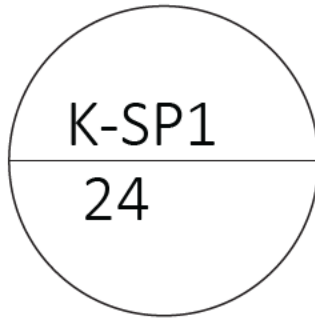
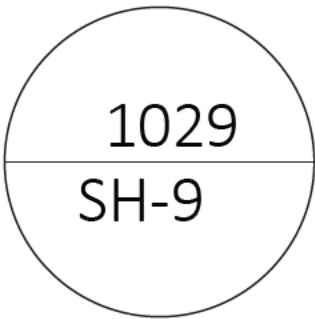
C

B


B

A

A



INSERT STUB-UP MATERIAL AS SHOWN
IN POST TO WHICH SPUD POLE
SLEEVES ATTACH. FASTEN USING
A DRILLET TO HOLD IN PLACE
DURING INSTALLATION.
SEE SH-3C FOR SLEEVE LOCATION

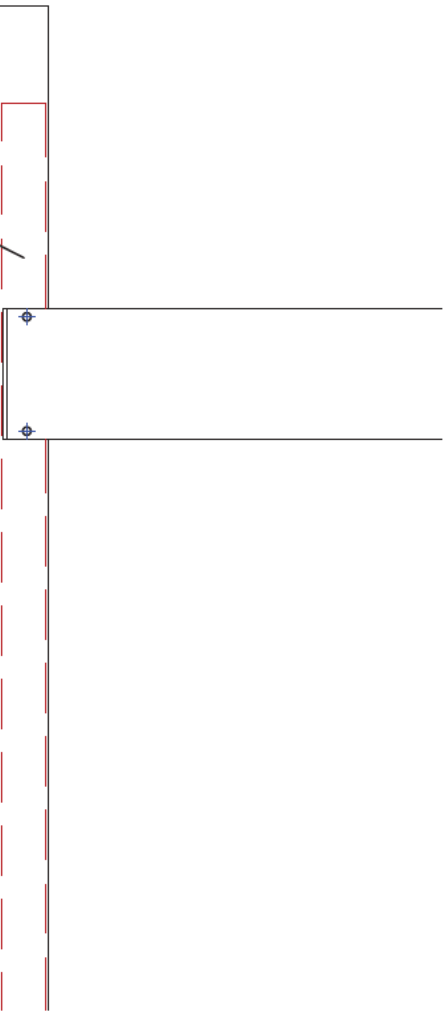

FLUSH WITH THE
BOTTOM OF THE POST

K-SP1 ASSEMBLIES ARE TO BE BOLTED
TO THE FRAMES AND POST AT THE
SPECIFICALLY MARKED PLACES.

-SHEET DETAIL-					
FILE NAME/CUSTOMER ➔		8 SLIP THE PENINSULA LOTS16-23.dwg			
DRAWN: 9/19/2023		8' COLLAR SIDE VIEW			
CHECKED:					
MANAG.APPR:					
ISSUED TO: MANUFACTURE					
DESIGN DRAFTER: R.BAKER		SIZE B	SCALE 1:36	DWG TYPE/NO.	REV 0
FABRICATOR:				SHEET 19 OF 42	

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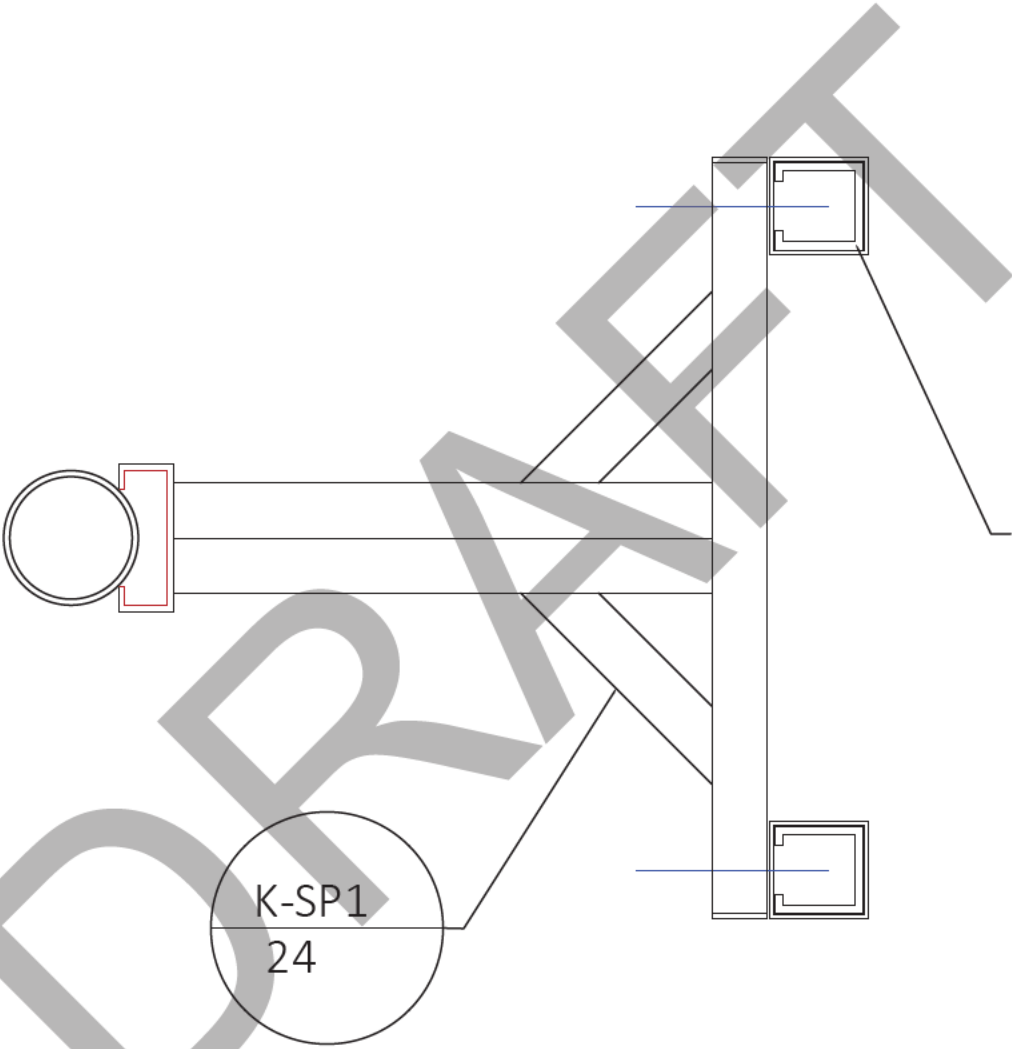
B

B

A

A




K-SP1 ASSEMBLIES ARE TO BE BOLTED TO THE FRAMES AND POST AT THE SPECIFICALLY MARKED PLACES.



INSERT STUB-UP MATERIAL AS SHOWN IN POST TO WHICH SPUD POLE SLEEVES ATTACH. FASTEN USING A DRILLET TO HOLD IN PLACE DURING INSTALLATION. SEE SH-10 FOR SLEEVE LOCATION

-SHEET DETAIL-					
FILE NAME/CUSTOMER ➔		8 SLIP THE PENINSULA LOTS16-23.dwg			
DRAWN: 9/19/2023		8' COLLAR SIDE VIEW			
CHECKED:					
MANAG.APPR:					
ISSUED TO: MANUFACTURE					
DESIGN DRAFTER: R.BAKER		SIZE B	SCALE 1:8	DWG TYPE/NO.	REV 0
FABRICATOR:				SHEET 20 OF 42	

SIDE VIEW

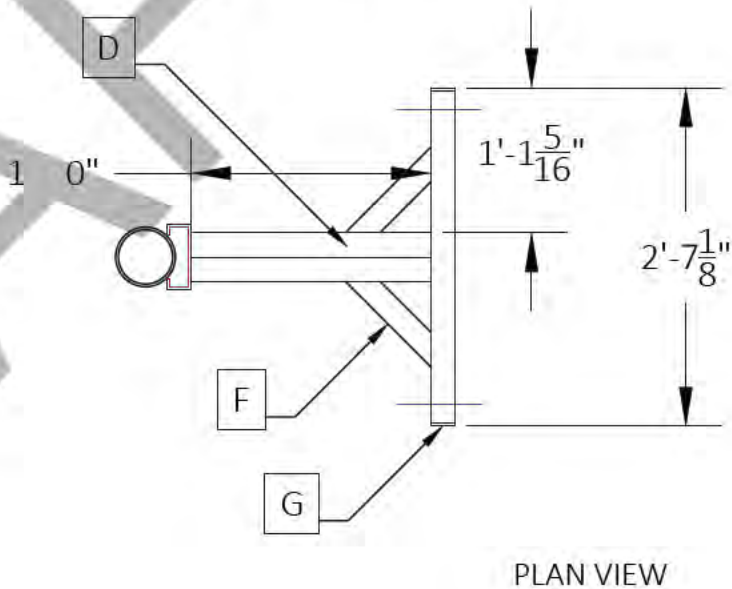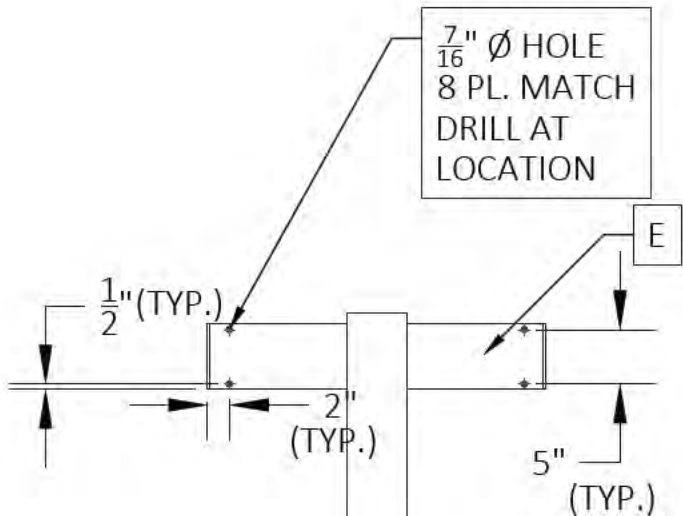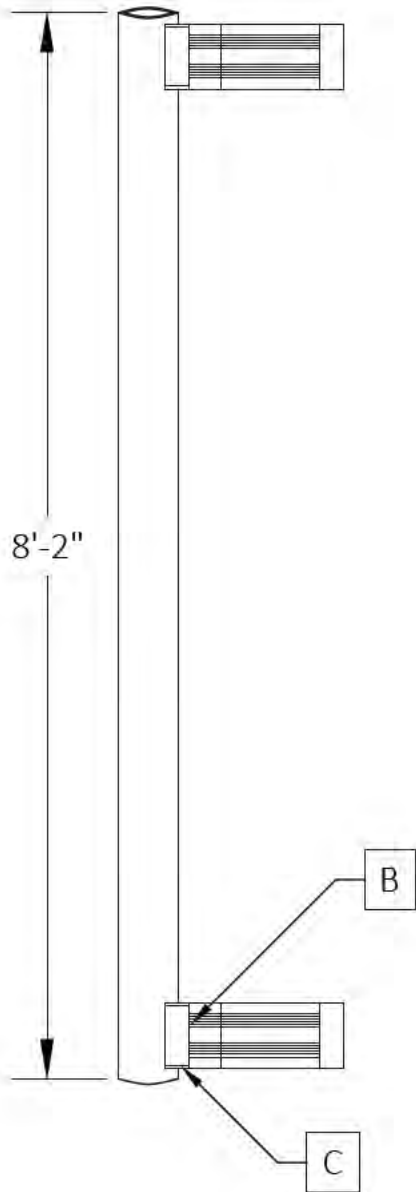

CUT/STOCK LIST							
DIE NUMBER	ITEM	QTY.	DESCRIPTION	DEGREE	FT.	IN.	TOTAL FT.
FH-04827	A	1	5" SCH. 40 ALUM PIPE	0°-0°	8	2"	8.17
FS-04739	B	2	6" H.W.	0°-0°		5 1/2"	####
FS-00490	C	4	1/4" X 2 1/4" PRE-CUT PLATE	0°-0°		6"	2.00
FS-04739	D	4	6" H.W.	0°-0°	1	10"	7.33
FS-04739	E	2	6" H.W.	0°-0°	2	6 5/8"	####
FS-04739	F	4	6" H.W.	45°-45°		11 1/16"	####
FS-00678	G	4	1/4" X 6" FLAT PLATE	0°-0°		2 1/4"	####

K-SP1

(17)REQUIRED



K-SP1 ASSEMBLIES ARE TO BE BOLTED TO THE FRAMES AND POST AT THE SPECIFICALLY MARKED PLACES.

-SHEET DETAIL-					
FILE NAME/CUSTOMER ➔		8 SLIP THE PENINSULA LOTS16-23.dwg			
DRAWN: 9/19/2023		8' COLLAR SIDE VIEW			
CHECKED:					
MANAG.APPR:					
ISSUED TO: MANUFACTURE					
DESIGN DRAFTER: R.BAKER		SIZE B	SCALE 1:18	DWG TYPE/NO.	REV 0
FABRICATOR:					SHEET 21 OF 42



CUT/STOCK LIST

DIE NUMBER	ITEM	QTY.	DESCRIPTION	DEGREE	FT.	IN.	TOTAL FT.
FH-07908	A	36	4" STUP UP	0°-0°	9	4	336.0000

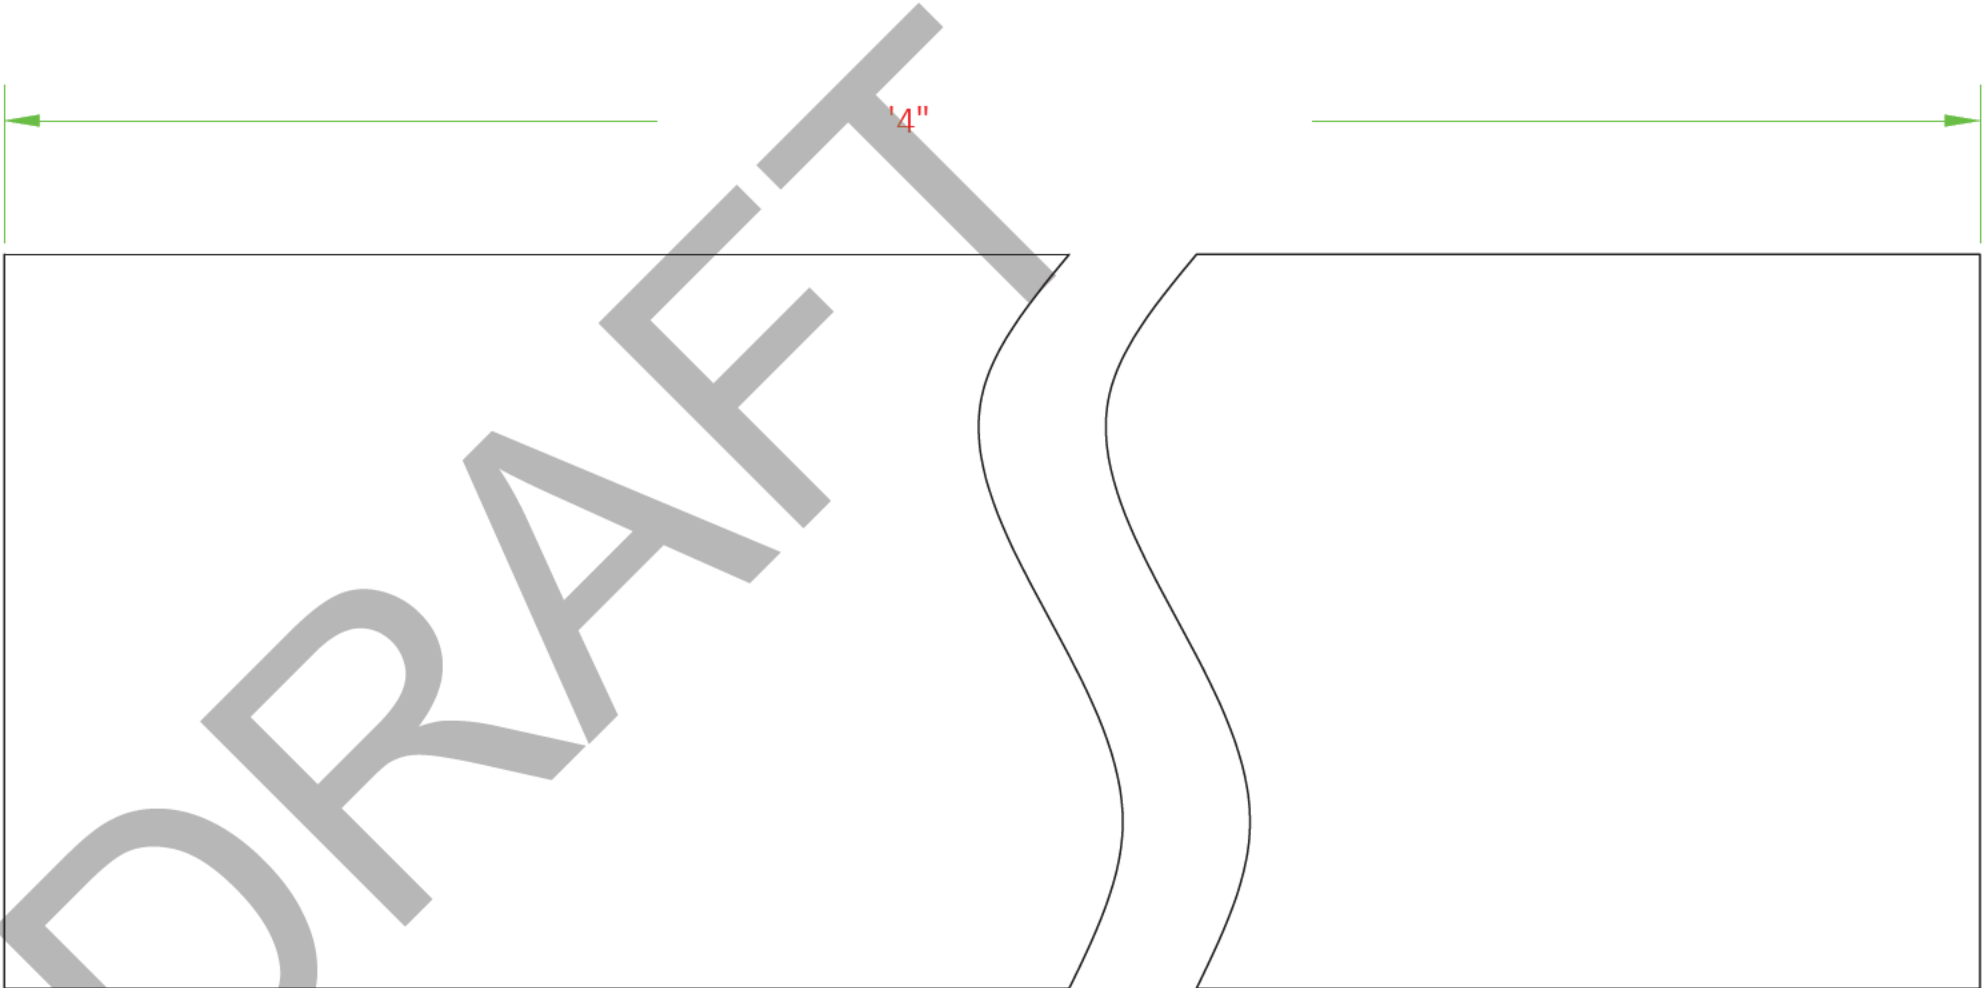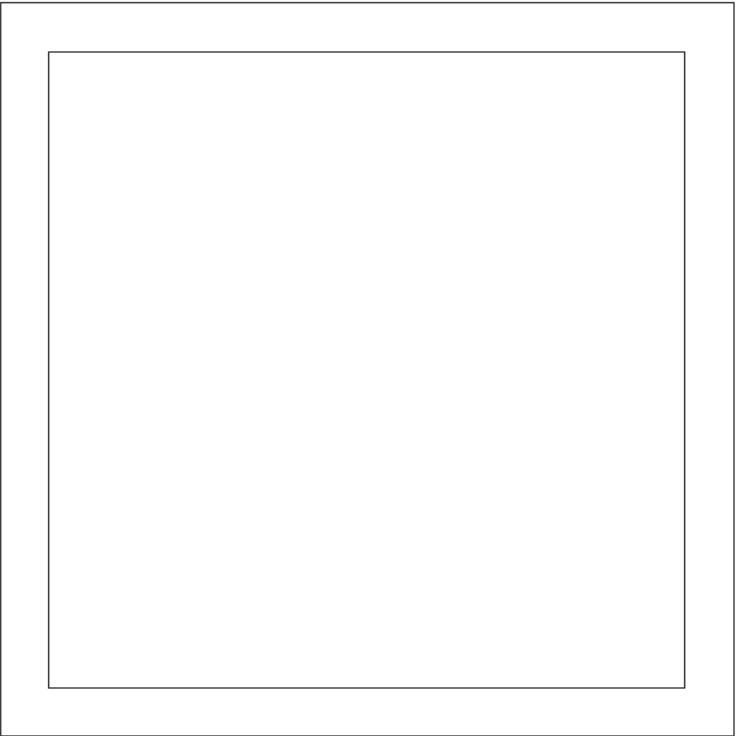

K-1002

-SHEET DETAIL-					
FILE NAME/CUSTOMER ➔		8 SLIP THE PENINSULA LOTS16-23.dwg			
DRAWN: 9/19/2023		8' COLLAR SIDE VIEW			
CHECKED:					
MANAG.APPR:					
ISSUED TO: MANUFACTURE					
DESIGN DRAFTER: R.BAKER		SIZE B	SCALE 1:1	DWG TYPE/NO.	REV 0
FABRICATOR:				SHEET 22 OF 42	



D

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C


C

B




B

A

A

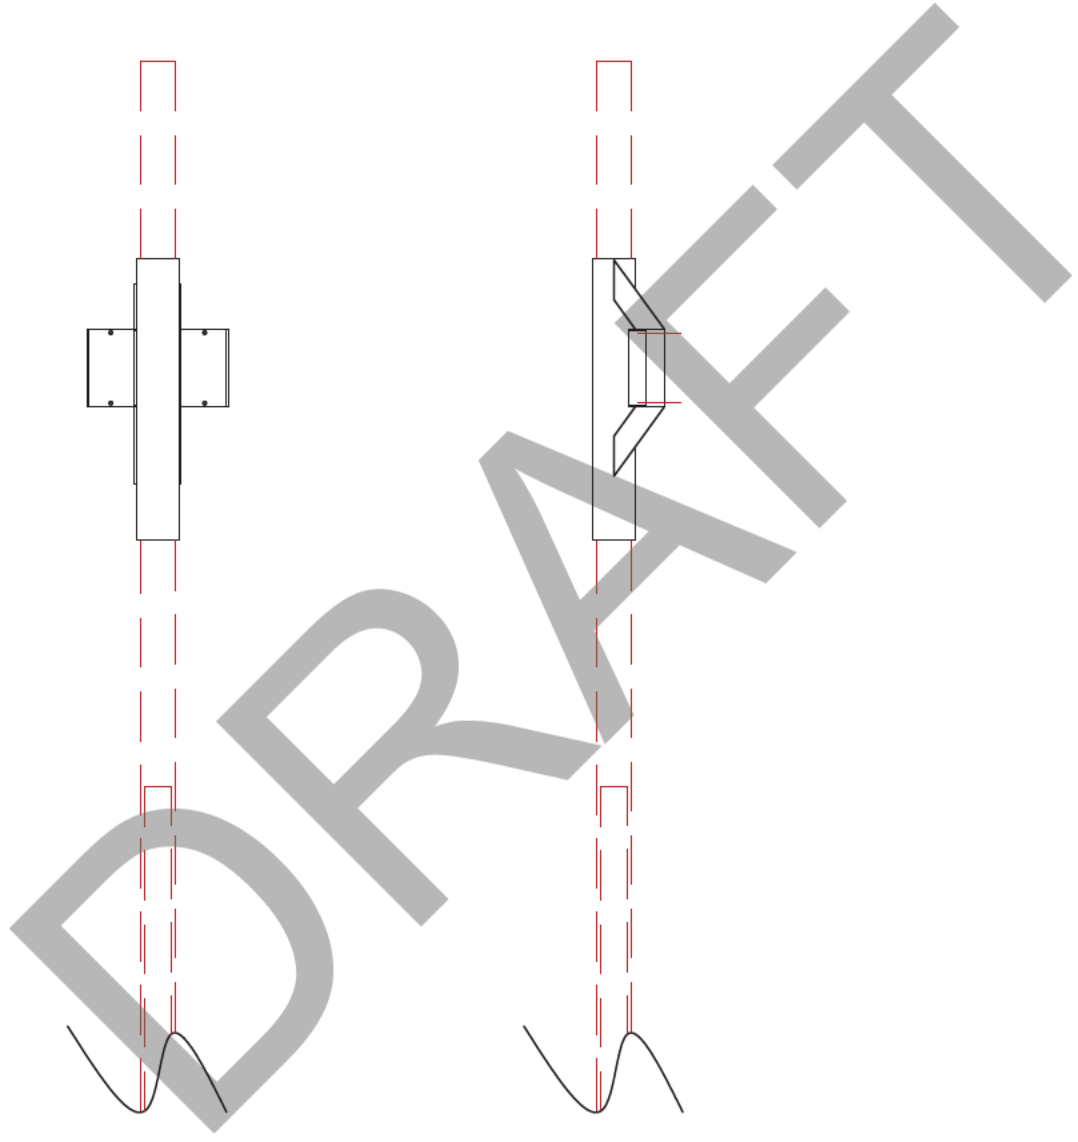

-SHEET DETAIL-		8 SLIP THE PENINSULA LOTS16-23.dwg		
FILE NAME/CUSTOMER ➔				
DRAWN: 9/19/2023		3' COLLAR VIEWS		
CHECKED:				
MANAG.APPR:				
ISSUED TO: MANUFACTURE				
DESIGN DRAFTER: R.BAKER	SIZE B	SCALE 1:25	DWG TYPE/NO.	REV 0
FABRICATOR:			SHEET 23 OF 42	

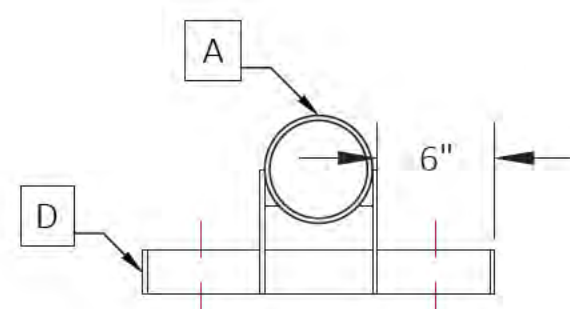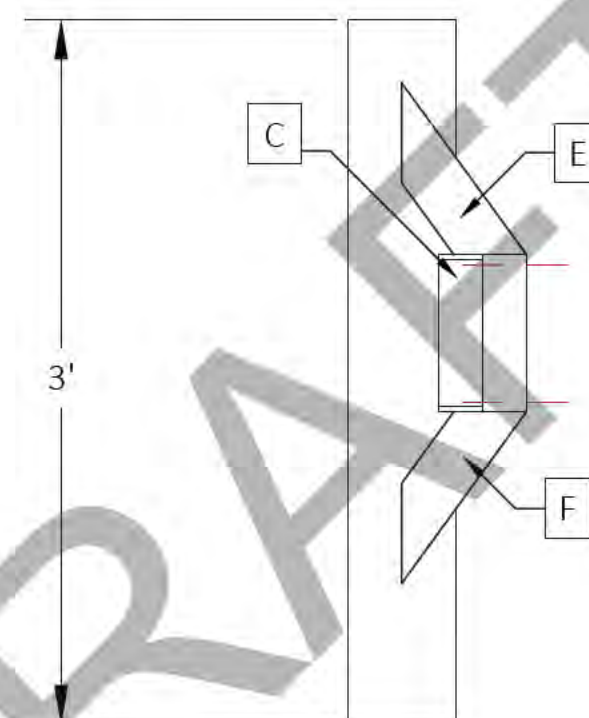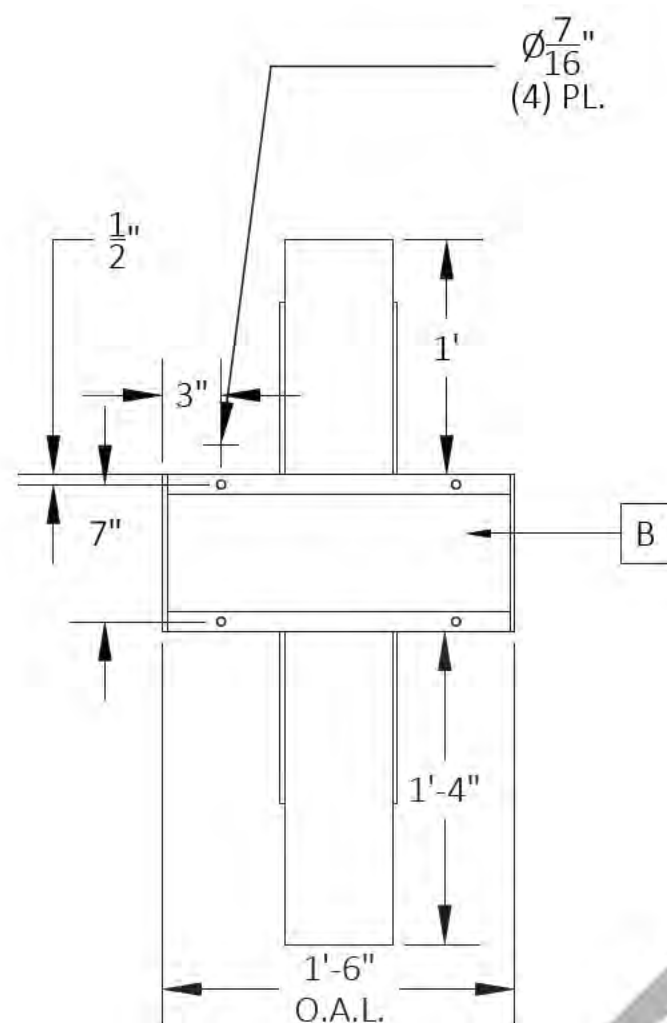

SP9-8

(2)REQUIRED

-SHEET DETAIL-						
FILE NAME/CUSTOMER ➔		8 SLIP THE PENINSULA LOTS16-23.dwg				
DRAWN: 9/19/2023		3' COLLAR				
CHECKED:						
MANAG.APPR:						
ISSUED TO: MANUFACTURE						
DESIGN DRAFTER: R.BAKER		SIZE B	SCALE 1:10	DWG TYPE/NO.		REV 0
FABRICATOR:					SHEET	24 OF 42

CUT/STOCK LIST							
DIE NUMBER	ITEM	QTY.	DESCRIPTION	DEGREE	FT.	IN.	TOTAL FT.
	A	19	4" SCH 40 X 21' SPUD POLE		21	0	399.0000

4 1/2"


45.0°

45.0°

1029


-SHEET DETAIL-					
FILE NAME/CUSTOMER ➔		8 SLIP THE PENINSULA LOTS16-23.dwg			
DRAWN: 9/19/2023		21' POLES			
CHECKED:					
MANAG.APPR:					
ISSUED TO: MANUFACTURE					
DESIGN DRAFTER: R.BAKER		SIZE B	SCALE 1:36	DWG TYPE/NO.	REV 0
FABRICATOR:				SHEET 25 OF 42	

CUT/STOCK LIST							
DIE NUMBER	ITEM	QTY.	DESCRIPTION	DEGREE	FT.	IN.	TOTAL FT.
FH-01356	A	1	1/8" X 2" X 2" TUBE	0°-0°	9	8 7/8	9.739583
FH-01356	B	2	1/8" X 2" X 2" TUBE	0°-0°	4	1 7/16	8.239583
FH-01356	C	3	1/8" X 2" X 2" TUBE	0°-0°	4	3	12.750000
FH-01356	D	2	1/8" X 2" X 2" TUBE	45°-45°	1	11	3.833333
FH-01356	E	2	1/8" X 2" X 2" TUBE	0°-45°		6	1.000000

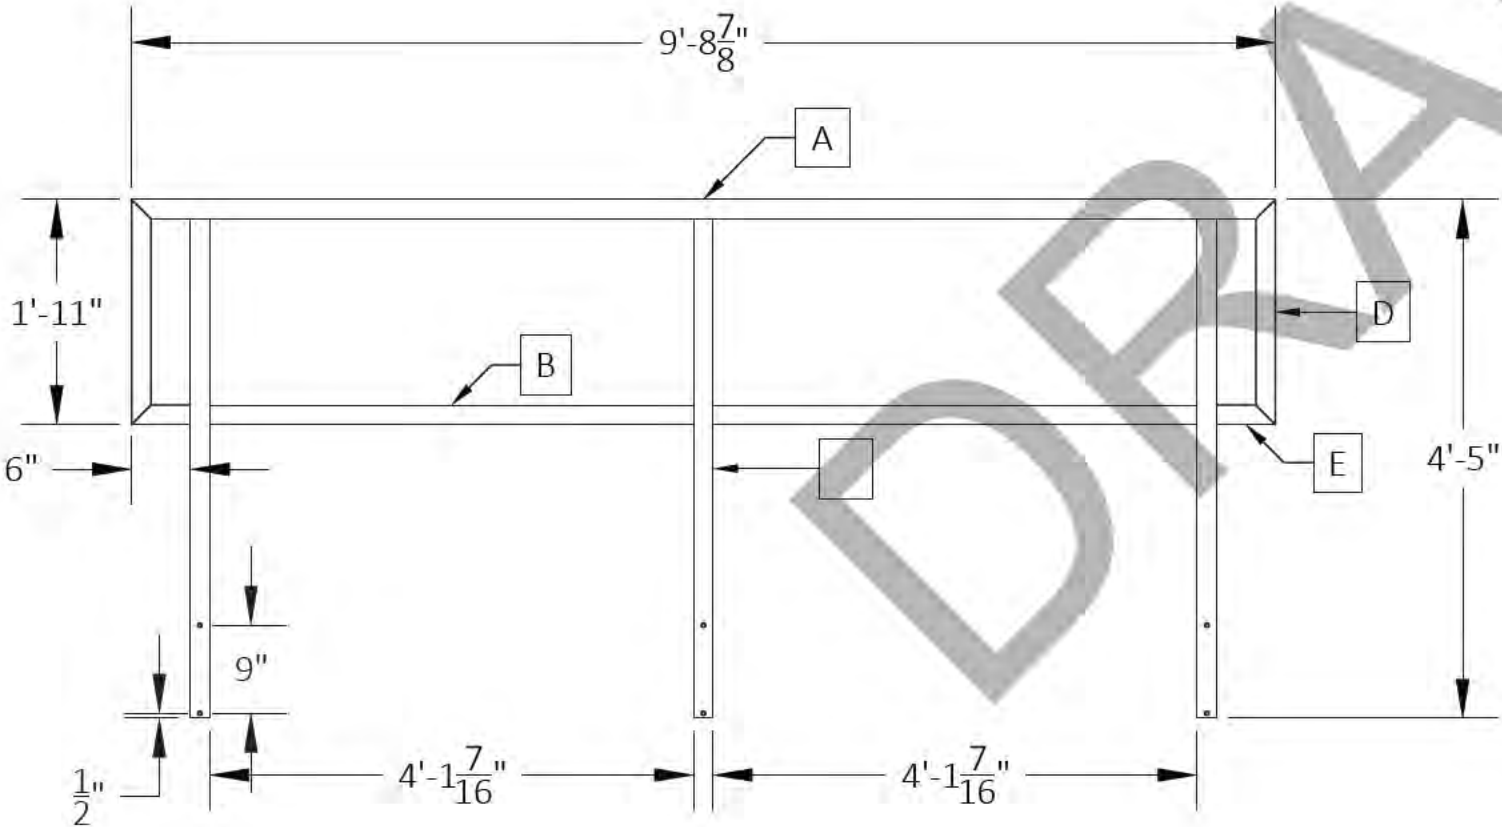


-SHEET DETAIL-					
FILE NAME/CUSTOMER ➔		8 SLIP THE PENINSULA LOTS16-23.dwg			
DRAWN: 9/19/2023		SR-1 6 (REQ)			
CHECKED:					
MANAG.APPR:					
ISSUED TO: MANUFACTURE					
DESIGN DRAFTER: R.BAKER		SIZE B	SCALE 1:20	DWG TYPE/NO.	REV 0
FABRICATOR:					SHEET 26 OF 42


CUT/STOCK LIST							
DIE NUMBER	ITEM	QTY.	DESCRIPTION	DEGREE	FT.	IN.	TOTAL FT.
FH-01356	A	1	1/8" X 2" X 2" TUBE	0°-0°	7	4 7/16	7.369792
FH-01356	B	1	1/8" X 2" X 2" TUBE	0°-0°	6	7/16	6.036458
FH-01356	C	2	1/8" X 2" X 2" TUBE	0°-0°	4	3	8.500000
FH-01356	D	2	1/8" X 2" X 2" TUBE	45°-45°	1	11	3.833333
FH-01356	E	2	1/8" X 2" X 2" TUBE	0°-45°		6	1.000000

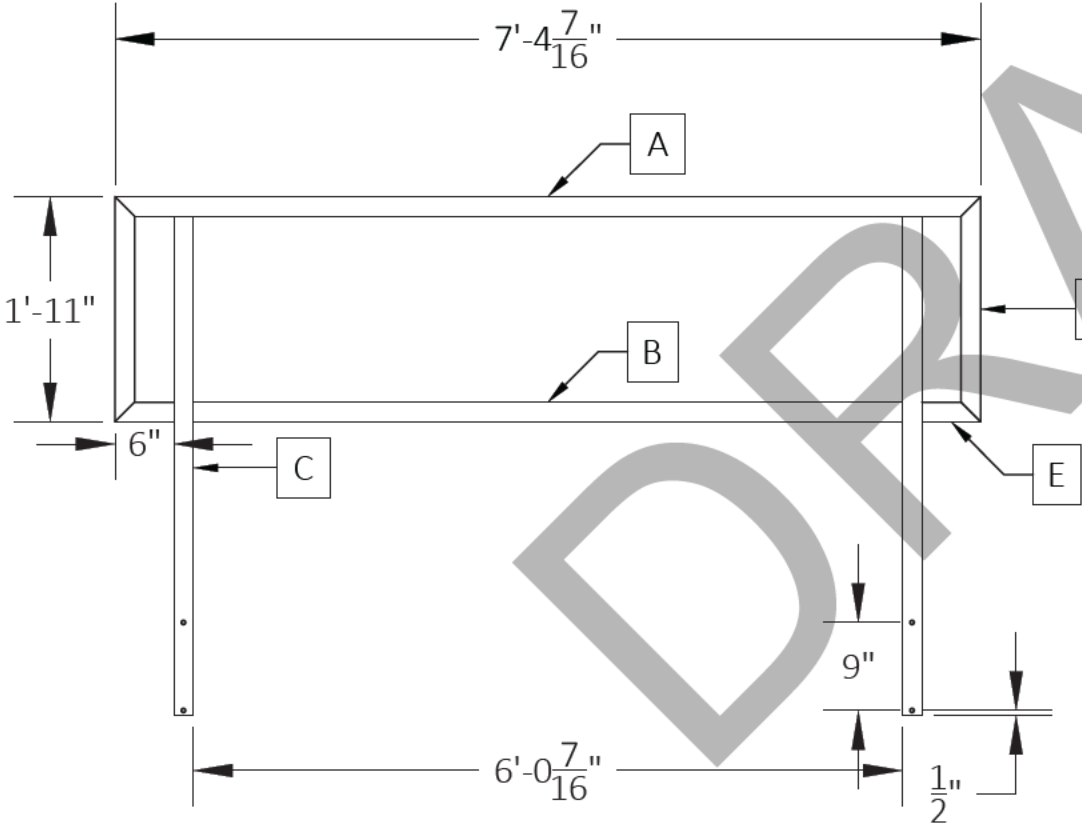

-SHEET DETAIL-					
FILE NAME/CUSTOMER ➔		8 SLIP THE PENINSULA LOTS16-23.dwg			
DRAWN: 9/19/2023		SR-2 2 (REQ)			
CHECKED:					
MANAG.APPR:					
ISSUED TO: MANUFACTURE					
DESIGN DRAFTER: R.BAKER		SIZE B	SCALE 1:20	DWG TYPE/NO.	REV 0
FABRICATOR:				SHEET 27 OF 42	

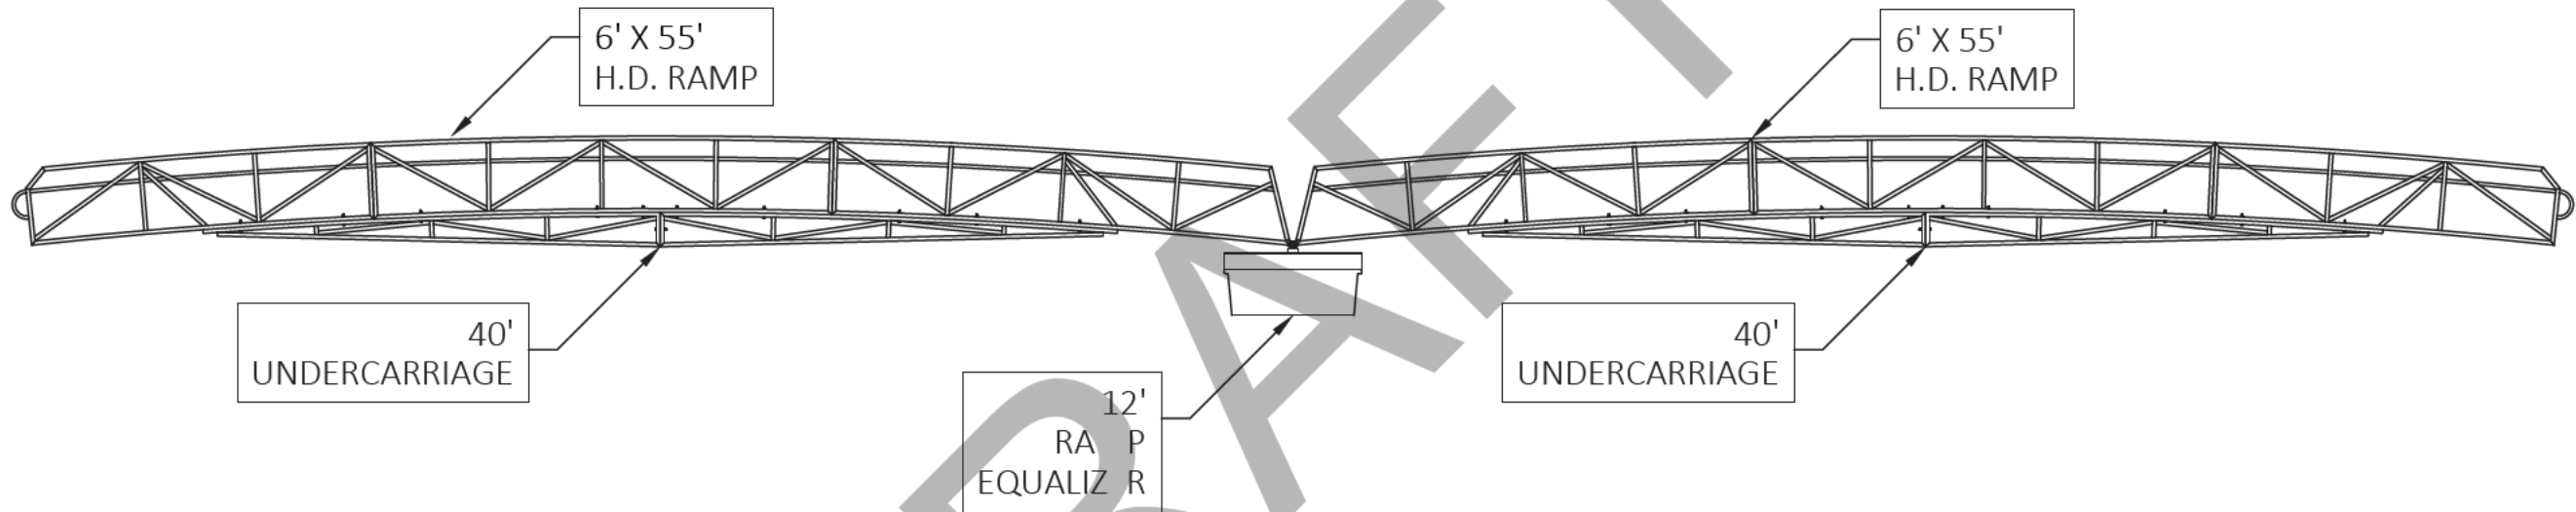

-SHEET DETAIL-					
FILE NAME/CUSTOMER ➔		8 SLIP THE PENINSULA LOTS16-23.dwg			
DRAWN: 9/19/2023		(2) 6' X 55' RAMPS w/ EQUALIZER SIDE VIEW			
CHECKED:					
MANAG.APPR:					
ISSUED TO: MANUFACTURE					
DESIGN DRAFTER: R.BAKER		SIZE B	SCALE 1:100	DWG TYPE/NO.	REV 0
FABRICATOR:				SHEET 28 OF 42	

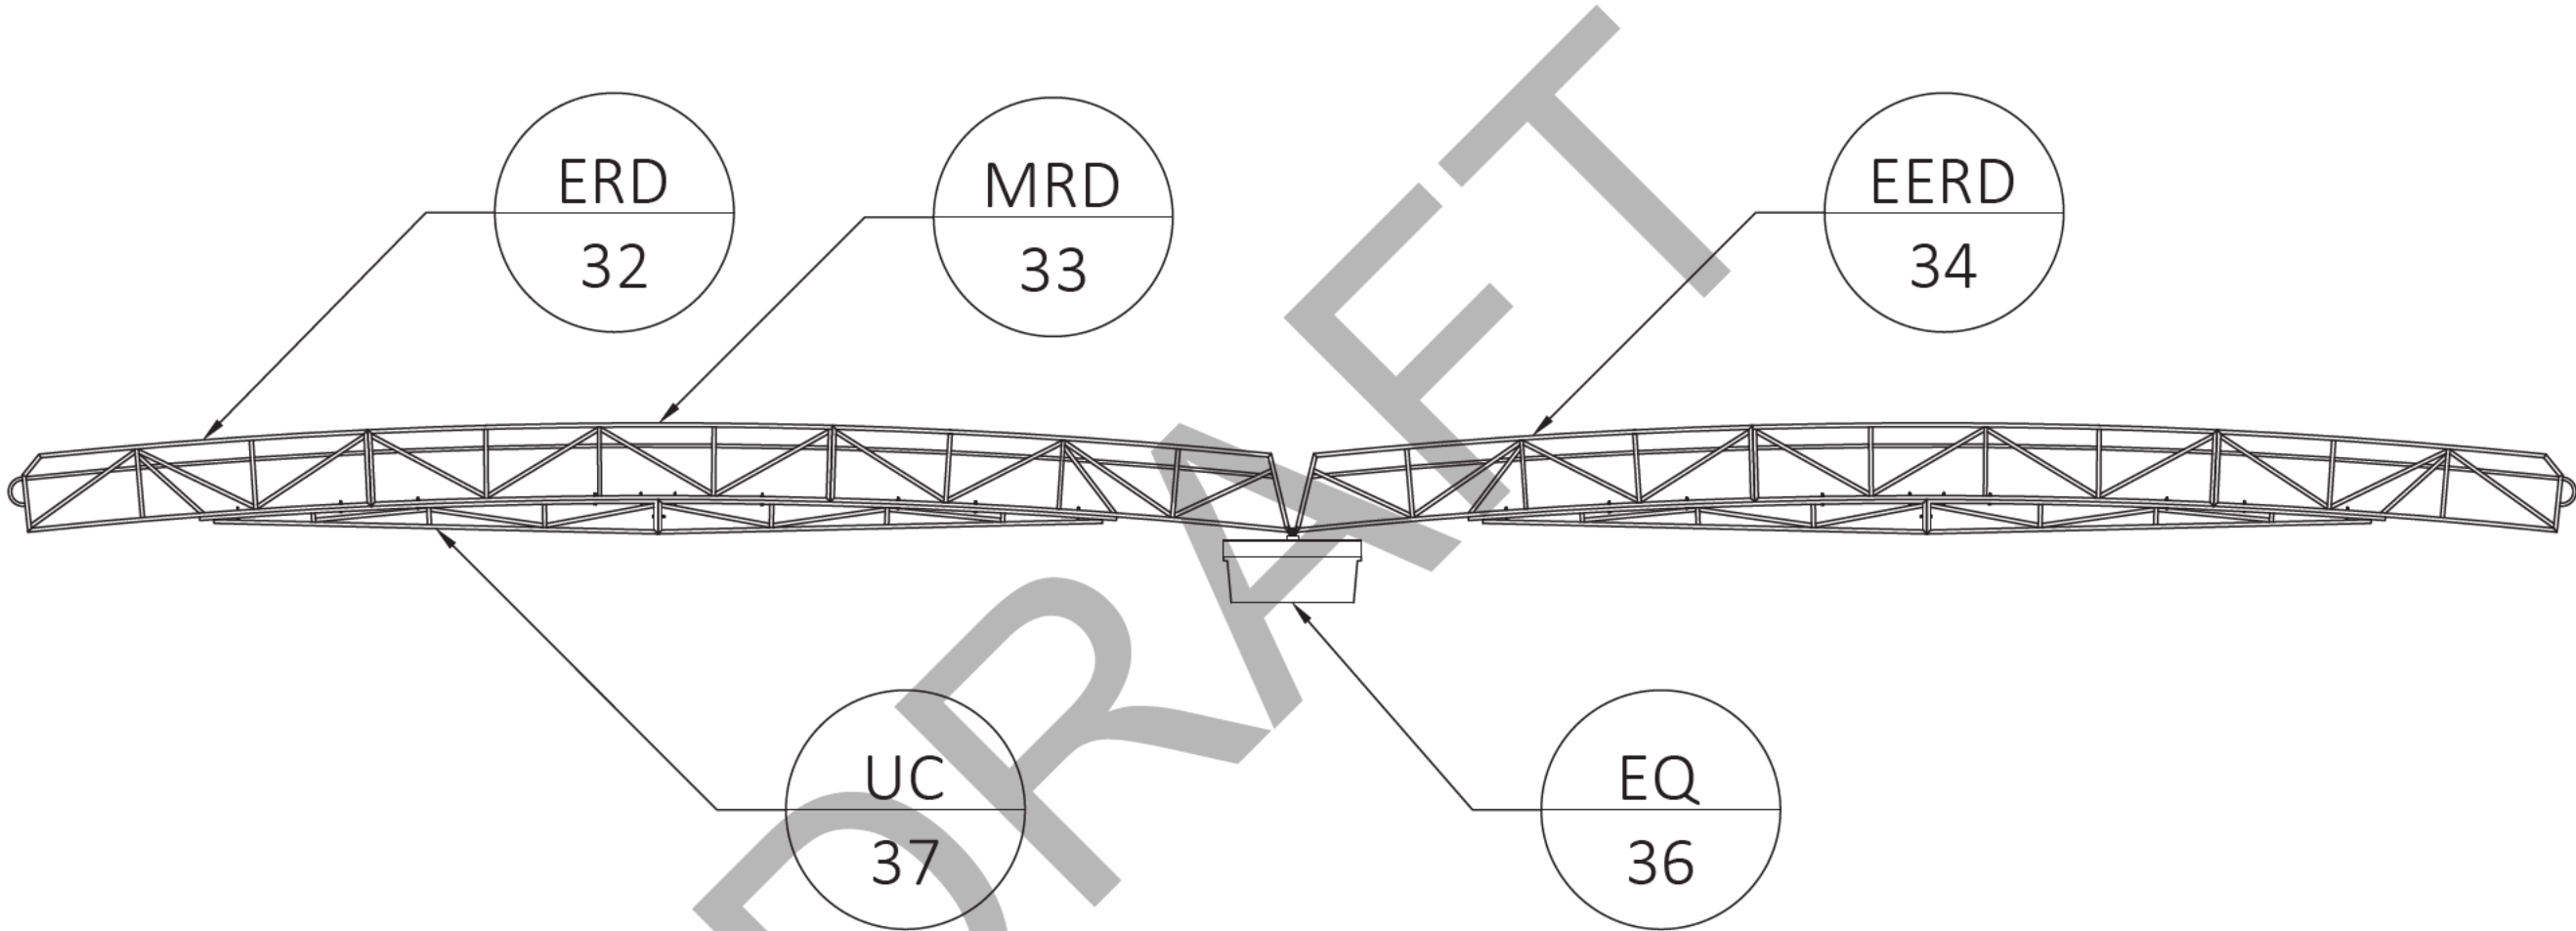

-SHEET DETAIL-		8 SLIP THE PENINSULA LOTS16-23.dwg			
FILE NAME/CUSTOMER ➔					
DRAWN: 9/19/2023		(2) 6' X 55' RAMPS w/ EQUALIZER SIDE VIEW			
CHECKED:					
MANAG.APPR:					
ISSUED TO: MANUFACTURE					
DESIGN DRAFTER: R.BAKER		SIZE B	SCALE 1:100	DWG TYPE/NO.	REV 0
FABRICATOR:				SHEET 29 OF 42	

D

D

C



C

B

B

A

A

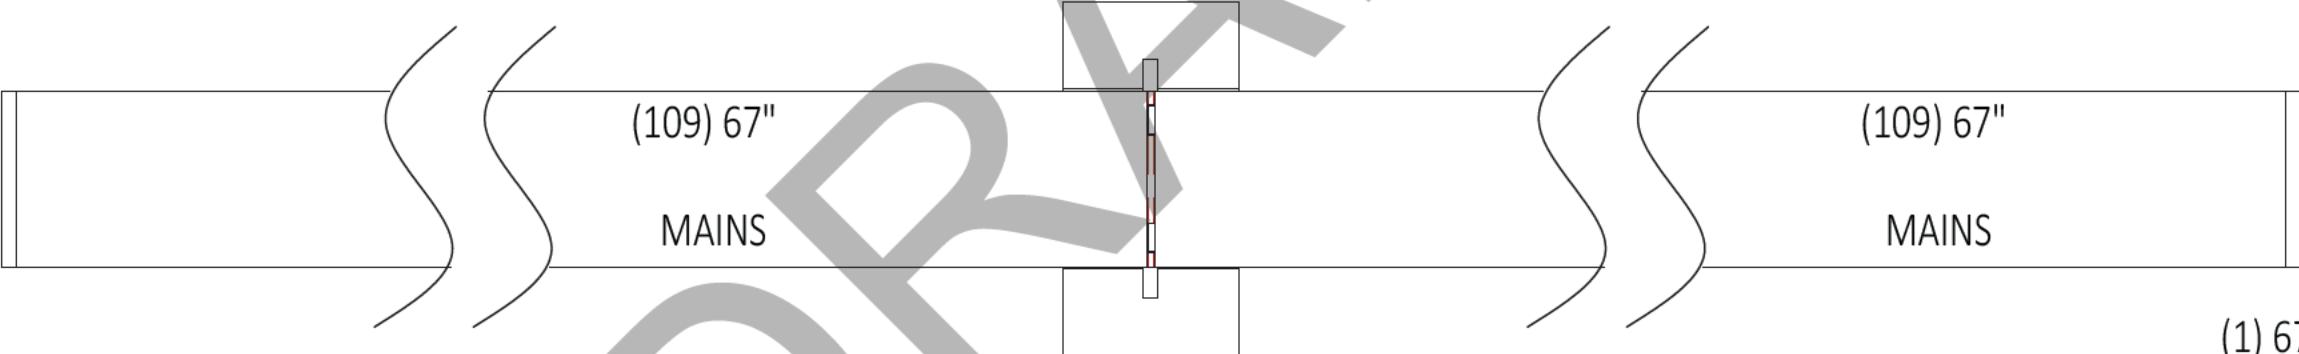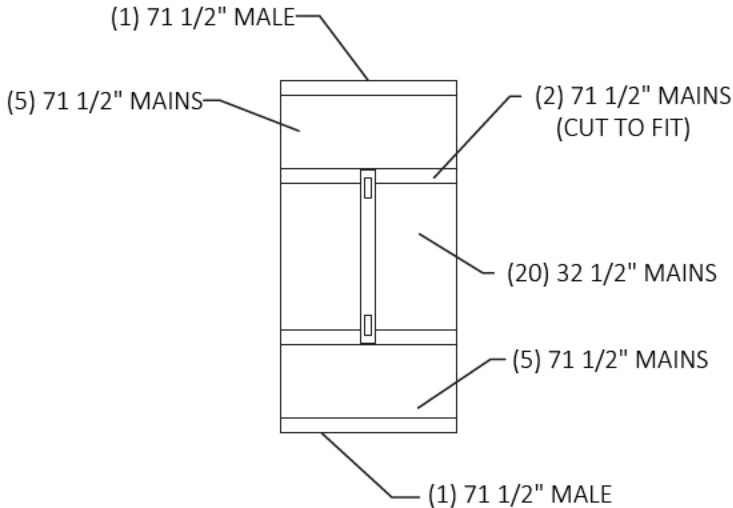

DECKING COLOR:

-SHEET DETAIL-		8 SLIP THE PENINSULA LOTS16-23.dwg			
FILE NAME/CUSTOMER ➔					
DRAWN: 9/19/2023		(2) 6' X 55' RAMPS w/ EQUALIZER DECKING DIAGRAM			
CHECKED:					
MANAG.APPR:					
ISSUED TO: MANUFACTURE					
DESIGN DRAFTER: R.BAKER		SIZE B	SCALE 1:80	DWG TYPE/NO.	REV 0
FABRICATOR:				SHEET 30 OF 42	



D

D

C

C

B

B

A

A


DECKING CUT LIST		
QTY.	DESCRIPTION	COLOR
218	67" MARINE MAINS	
2	67" MARINE MALES	
12	71-1/2" MARINE MAINS	
20	32 1/2" MARINE MAINS	
2	71 1/2" MARINE MALES	

DRAFT

-SHEET DETAIL-					
FILE NAME/CUSTOMER ➔		8 SLIP THE PENINSULA LOTS16-23.dwg			
DRAWN: 9/19/2023		(2) 6' X 55' RAMPS w/ EQUALIZER DECKING DIAGRAM			
CHECKED:					
MANAG.APPR:					
ISSUED TO: MANUFACTURE					
DESIGN DRAFTER: R.BAKER		SIZE B	SCALE 1:80	DWG TYPE/NO.	REV 0
FABRICATOR:				SHEET 31 OF 42	




STOCK LIST		
DET. NO.	QTY.	DESCRIPTION
A	2	1 1/4" SCH. 40 ALUM. PIPE 18' LG. **ROLLED ON ONE END** CUT TO FIT**
B	8	GRAB BAR BRACKETS 1 3/4" LG.
C	2	1" X 2" TUBING 15'-2" LG.

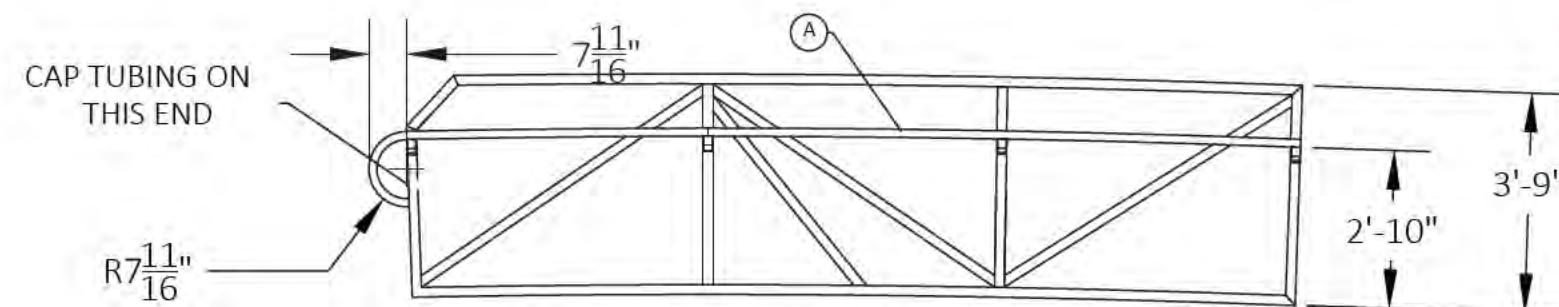


END RAMP SECTION

SEE ATTACHMENT
SHEET FOR THIS
END OF
THE RAMP

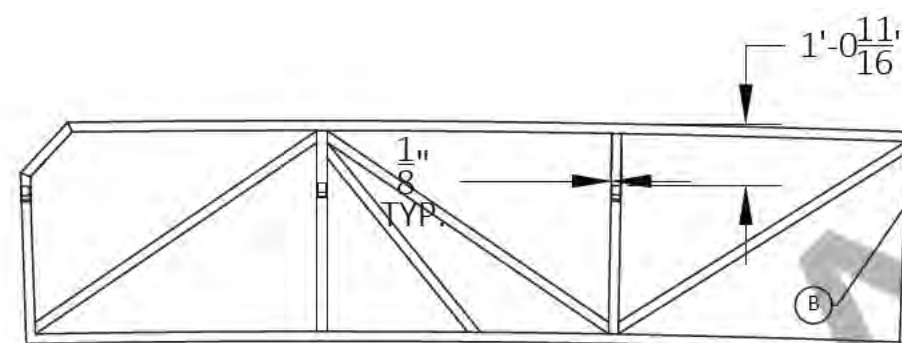


1'-0 11/16"
FROM THE TOP OF
THE RAMP TO THE
TOP OF THE GRAB RAIL
BRACKET

BOLT-UPS
ON THE THIS
END OF THE RAMP

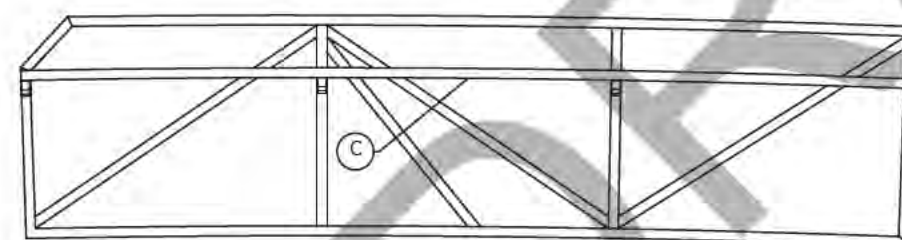


END RAMP SECTION

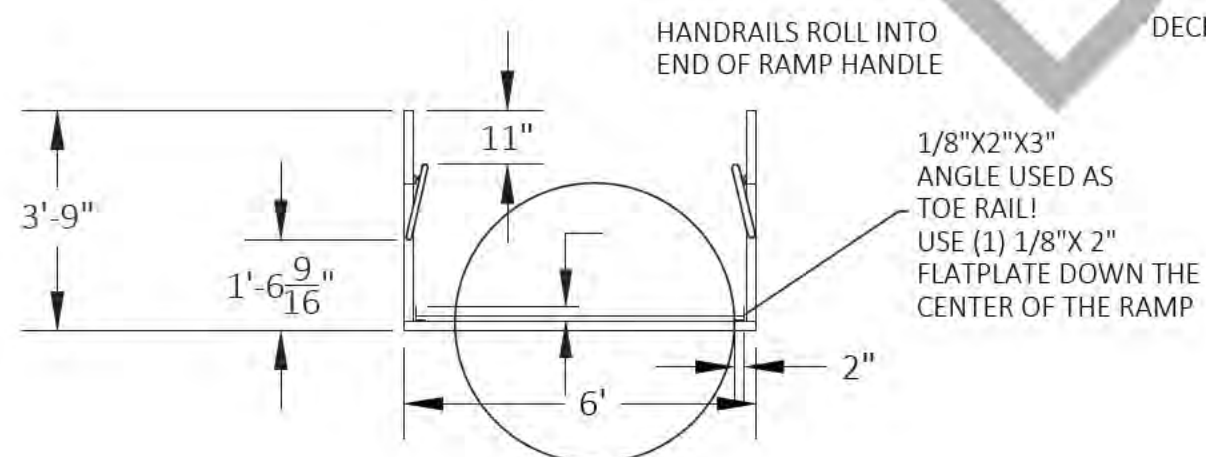

DECKING USED

12 11/16"
FROM THE TOP OF
THE RAMP TO THE
TOP OF THE GRAB RAIL
BRACKET

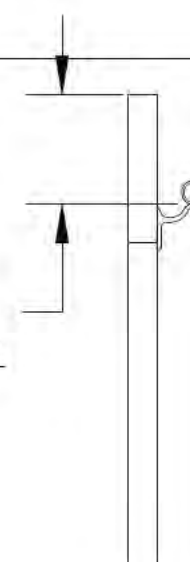


6 X 15' END
RAMP SECTION

--SHEET DETAIL--		8 SLIP THE PENINSULA LOTS16-23.dwg (2) 6' X 55' RAMPS w/ EQUALIZER ERD				
FILE NAME/CUSTOMER ➔						
DRAWN: 9/19/2023						
CHECKED:						
MANAG.APPR:						
ISSUED TO: MANUFACTURE						
DESIGN DRAFTER: R.BAKER		SIZE B	SCALE 1:40	DWG TYPE/NO.		REV 0
FABRICATOR:				SHEET 32 OF 42		


STOCK LIST		
DET. NO.	QTY.	DESCRIPTION
A	2	1 1/4" SCH. 40 ALUM. PIPE 20' LG. CUT TO FIT**
B	2	1 1/4" SCH. 40 ALUM PIPE 10'-1 5/16" LG.
C	10	GRAB BAR BRACKETS 1 3/4" LG.

INSIDE VIEW

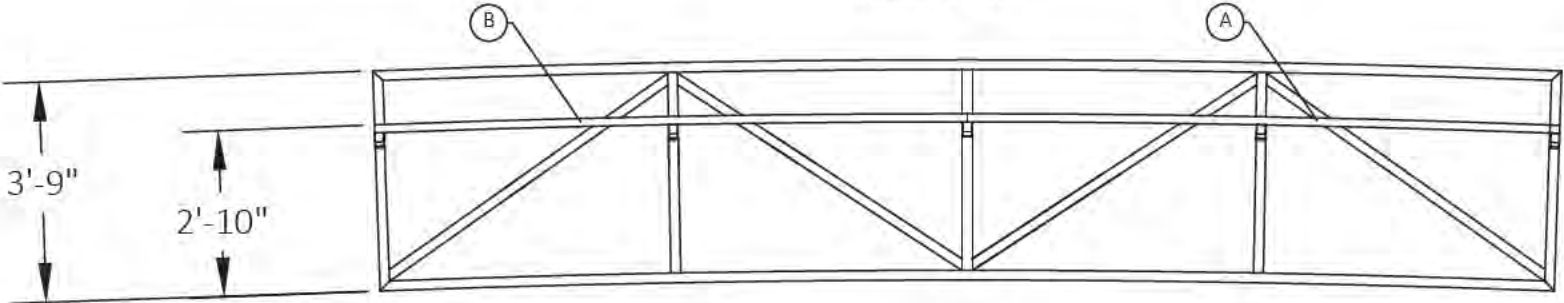


MIDDLE RAMP SECTION

BOLT-UPS
ON THE THIS
END OF THE RAMP

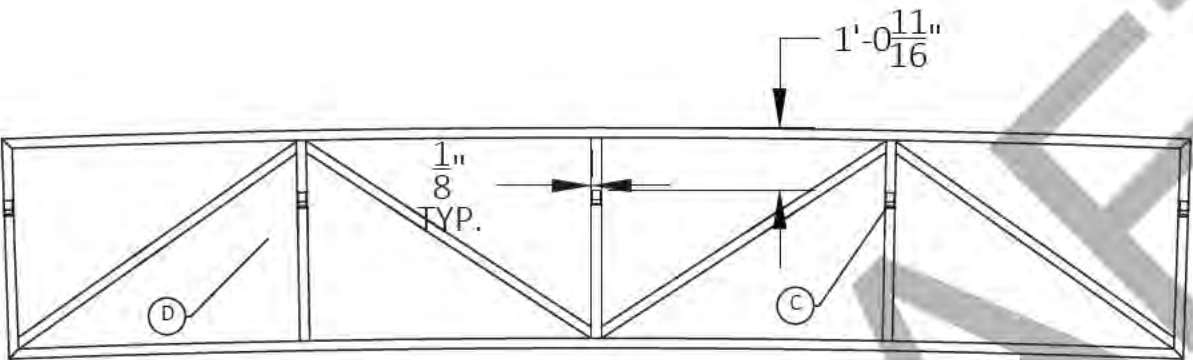


1'-0 11/16"
FROM THE TOP OF
THE RAMP TO THE
TOP OF THE GRAB RAIL
BRACKET

MIDDLE RAMP SECTION

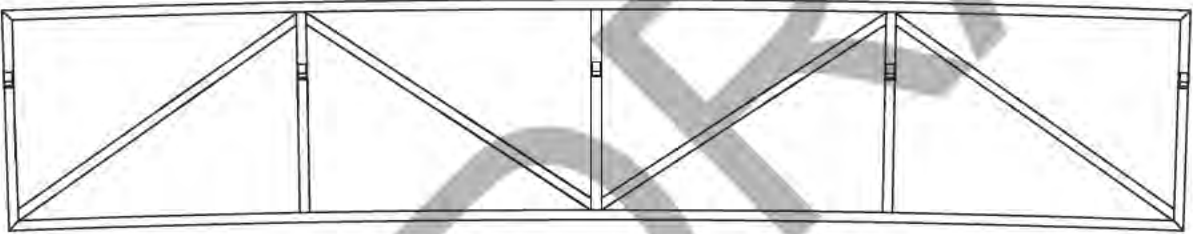

6' X 20' MIDDLE
RAMP SECTION

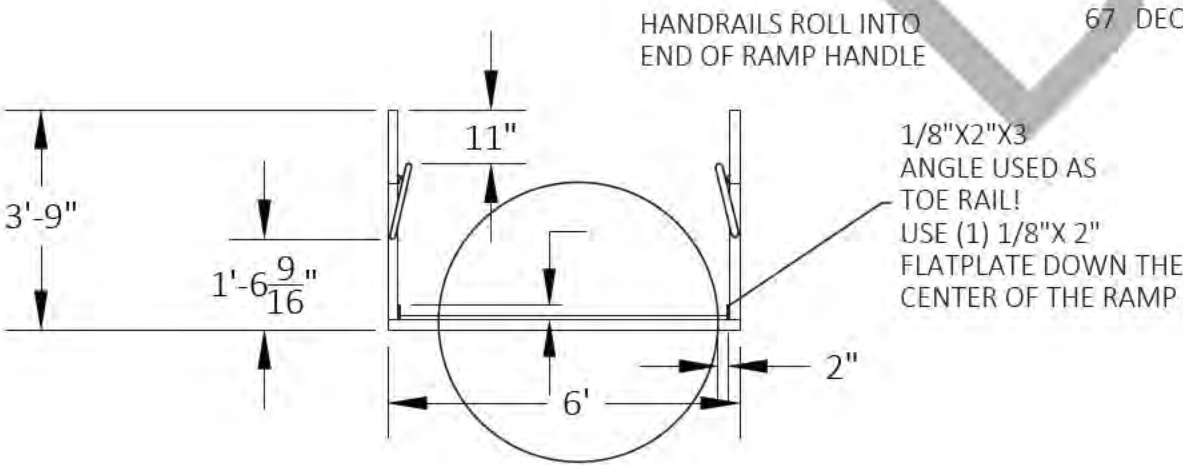


12 11/16"
FROM THE TOP OF
THE RAMP TO THE
TOP OF THE GRAB RAIL
BRACKET

-SHEET DETAIL-		8 SLIP THE PENINSULA LOTS16-23.dwg			
FILE NAME/CUSTOMER ➔					
DRAWN: 9/19/2023		(2) 6' X 55' RAMPS w/ EQUALIZER MRD			
CHECKED:					
MANAG. APPR:					
ISSUED TO: MANUFACTURE					
DESIGN DRAFTER: R. BAKER		SIZE B	SCALE 1:40	DWG TYPE/NO.	REV 0
FABRICATOR:					SHEET 33 OF 42


STOCK LIST			
DET. NO.	QTY.	DESCRIPTION	
A	2	1 1/4" SCH. 40 ALUM. PIPE 13' LG. **ROLLED ON ONE END** CUT TO FIT**	
B	2	1 1/4" SCH. 40 ALUM PIPE 10'-1 5/16" LG.	
C	10	GRAB BAR BRACKETS 1 3/4" LG.	

INSIDE VIEW

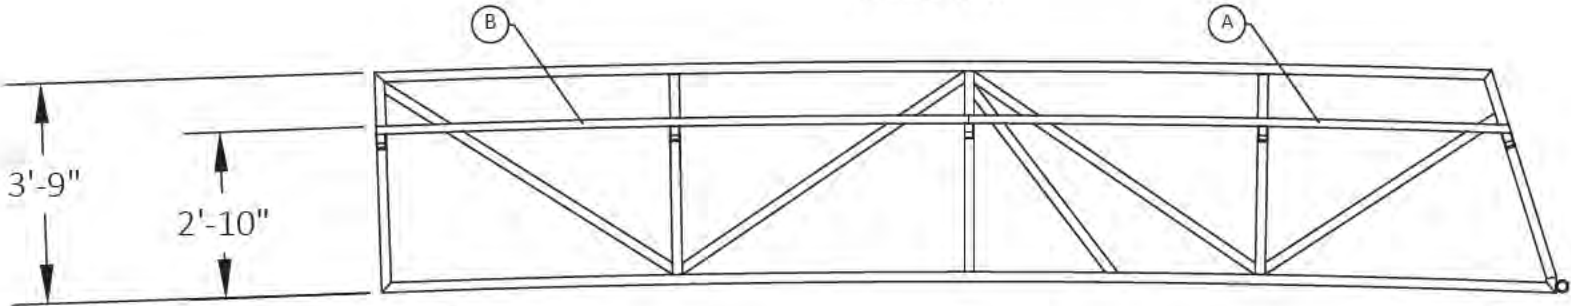


EQUALIZER END RAMP SECTION

BOLT-UPS
ON THE THIS
END OF THE RAMP

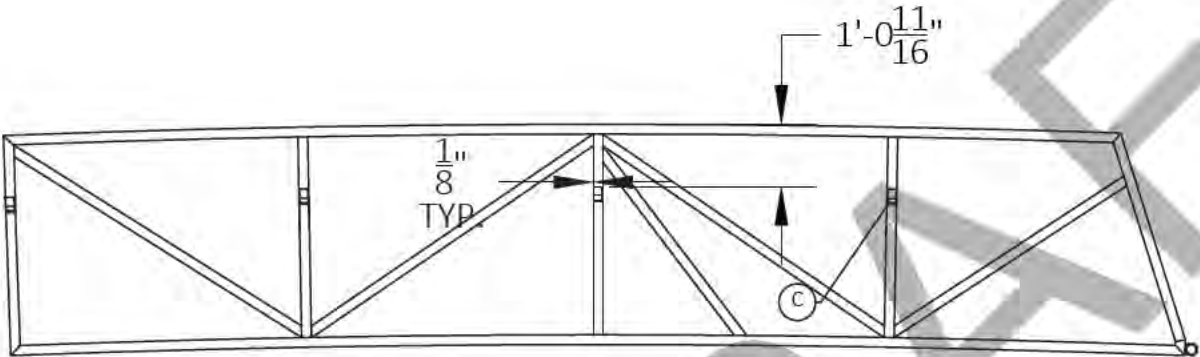


1'-0 11/16"
FROM THE TOP OF
THE RAMP TO THE
TOP OF THE GRAB RAIL
BRACKET

72" TRACK AND PIPE
ON THE THIS
END OF THE RAMP

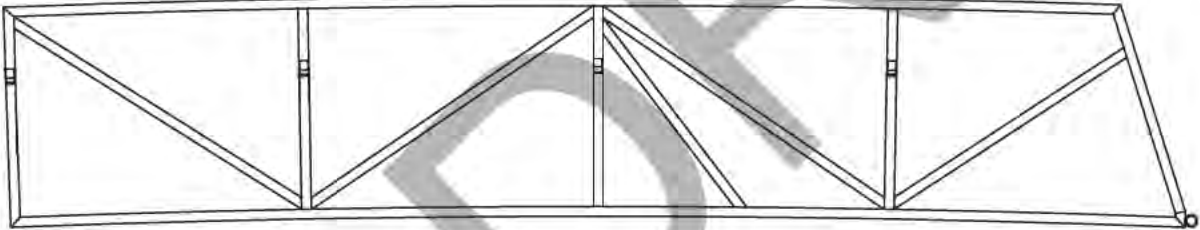

EQUALIZER END RAMP SECTION





6' X 20' EQUALIZER END
RAMP SECTION

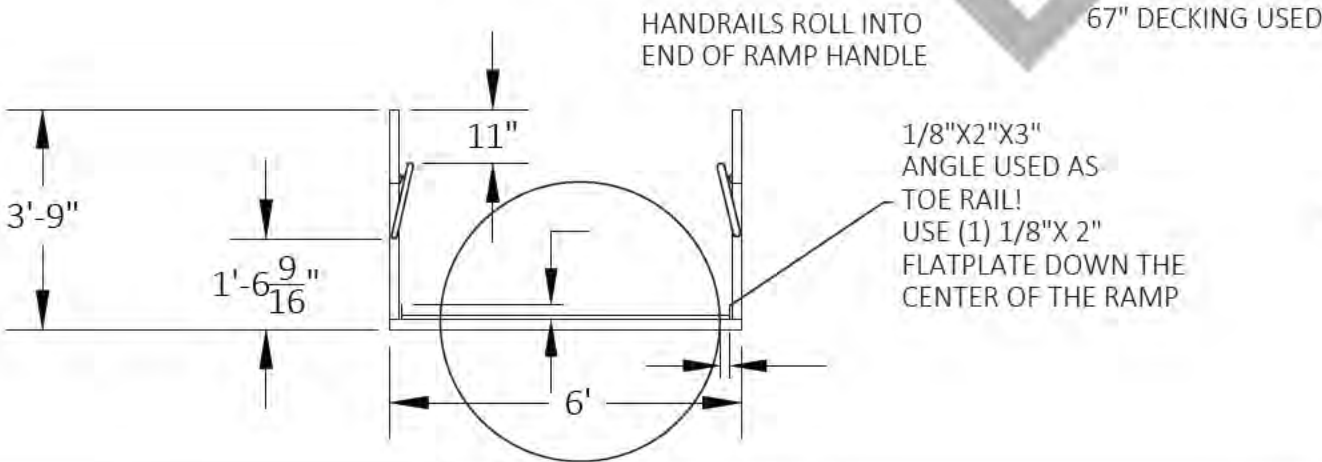

12 11/16"
FROM THE TOP OF
THE RAMP TO THE
TOP OF THE GRAB RAIL
BRACKET

-SHEET DETAIL-					
FILE NAME/CUSTOMER ➔		8 SLIP THE PENINSULA LOTS16-23.dwg			
DRAWN: 9/19/2023		(2) 6' X 55' RAMPS w/ EQUALIZER EERD			
CHECKED:					
MANAG.APPR:					
ISSUED TO: MANUFACTURE					
DESIGN DRAFTER: RIBAKER		SIZE B	SCALE 1:40	DWG TYPE/NO.	REV 0
FABRICATOR:					SHEET 34 OF 42

CUT LIST							
DIE NUMBER	ITEM	QTY.	DESCRIPTION	DEGREE	FT	IN	TOTAL FT
FH-07812	A	1	RAMP PIPE	0°-0°	2	9 7/16"	####
FS-07813	B	2	RAMP TRACK	0°-0°	6	0"	12.00
FH-07812	C	2	RAMP PIPE	0°-0°		9 7/16"	####
FH-07812	D	2	RAMP PIPE	0°-0°		9 11/16"	####

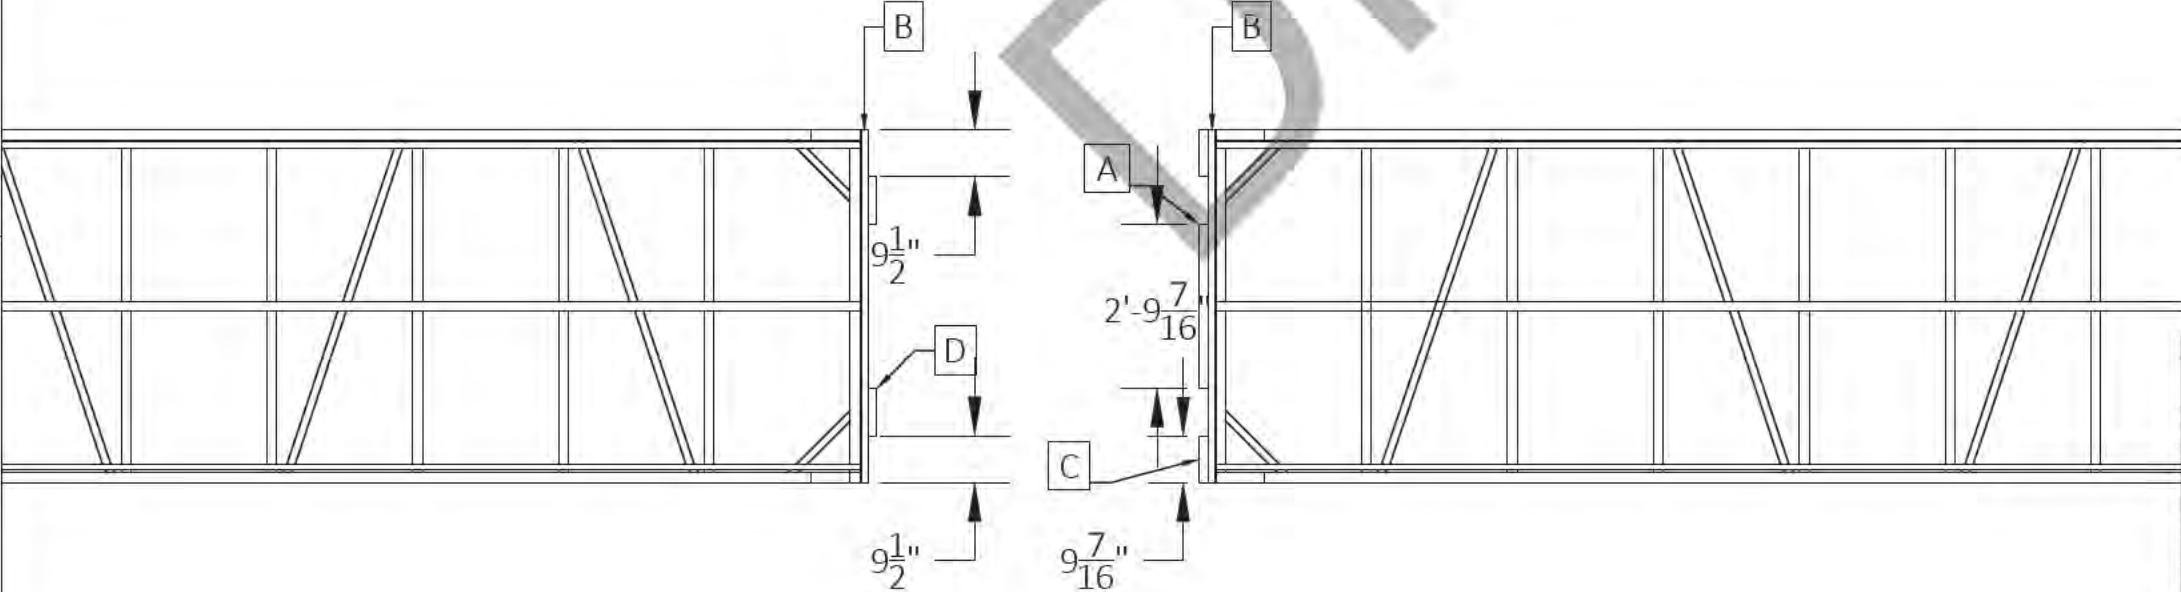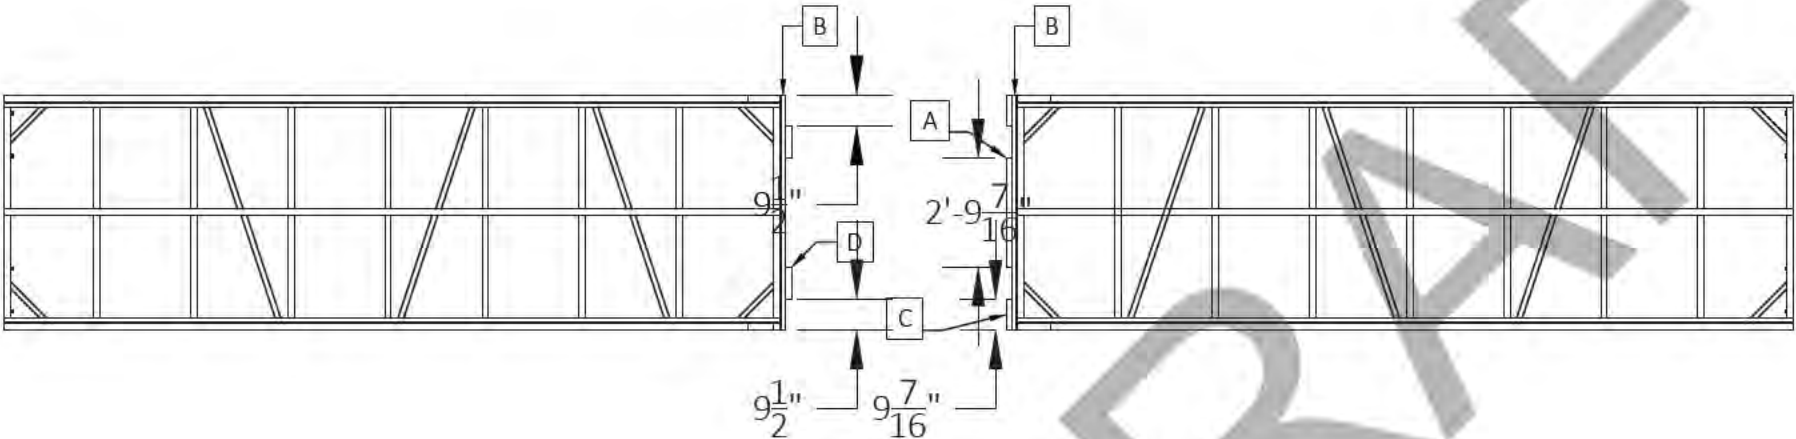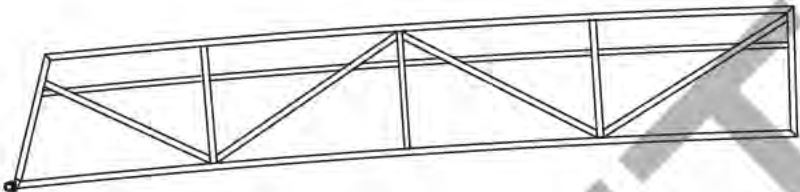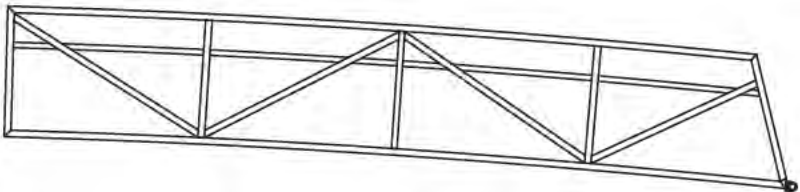

-SHEET DETAIL-		8 SLIP THE PENINSULA LOTS16-23.dwg	
FILE NAME/CUSTOMER		(2) 6' X 55' RAMPS w/ EQUALIZER	
DRAWN: 9/19/2023		EQ END RAMP ATTACHMENT	
CHECKED:			
MANAG.APPR:			
ISSUED TO: MANUFACTURE			
DESIGN DRAFTER: R.BAKER		SIZE B	SCALE 1:60
FABRICATOR:		DWG TYPE/NO.	REV 0
		SHEET 35 OF 42	

D

D

C

C



B

B


A

A

CUT LIST							
DIE NUMBER	ITEM	QTY.	DESCRIPTION	DEGREE	FT	IN	TOTAL FT
FS-00431	A	2	8" H.W.	45°-45°	12	0"	24.00
FS-00431	B	2	8" H.W.	45°-45°	6	0"	12.00
FS-00431	C	5	8" H.W.	45°-45°	5	7 1/2"	#####
	D	1	6" H.W.	0°-0°	8	5/8"	8.05
FS-00431	E	8	8" H.W.	45°-45°	1	2"	9.33
FH-07812	F	2	RAMP PIPE	0°-0°		8"	1.33
FS-00678	G	2	1/4" X 6" FLATPLATE	0°-0°		2 1/4"	#####
FS-00431	H	2	8" H.W.	0°-0°	2	9 3/16"	#####
FS-07813	I	1	RAMP TRACK	0°-0°	8	0	8.00

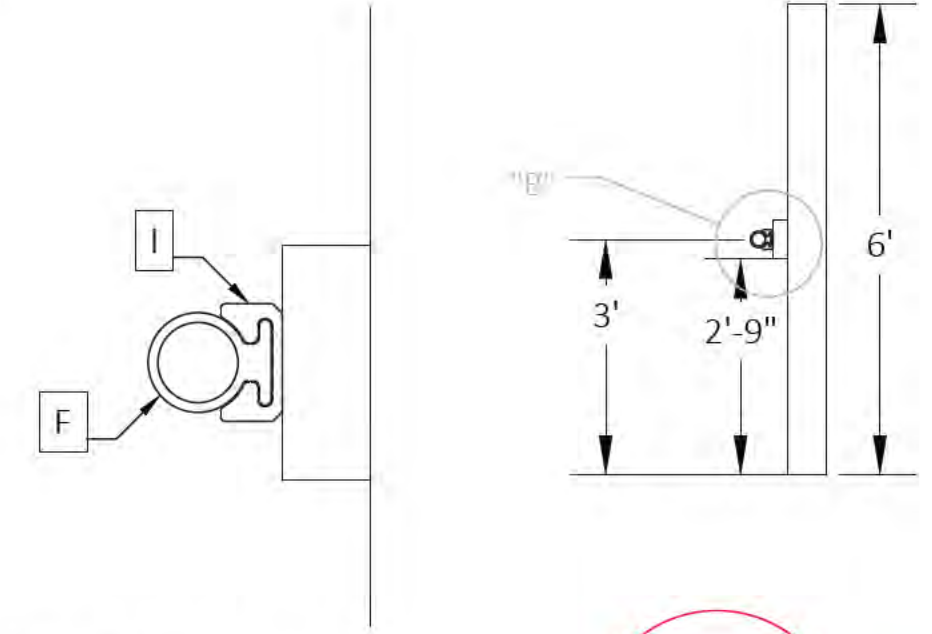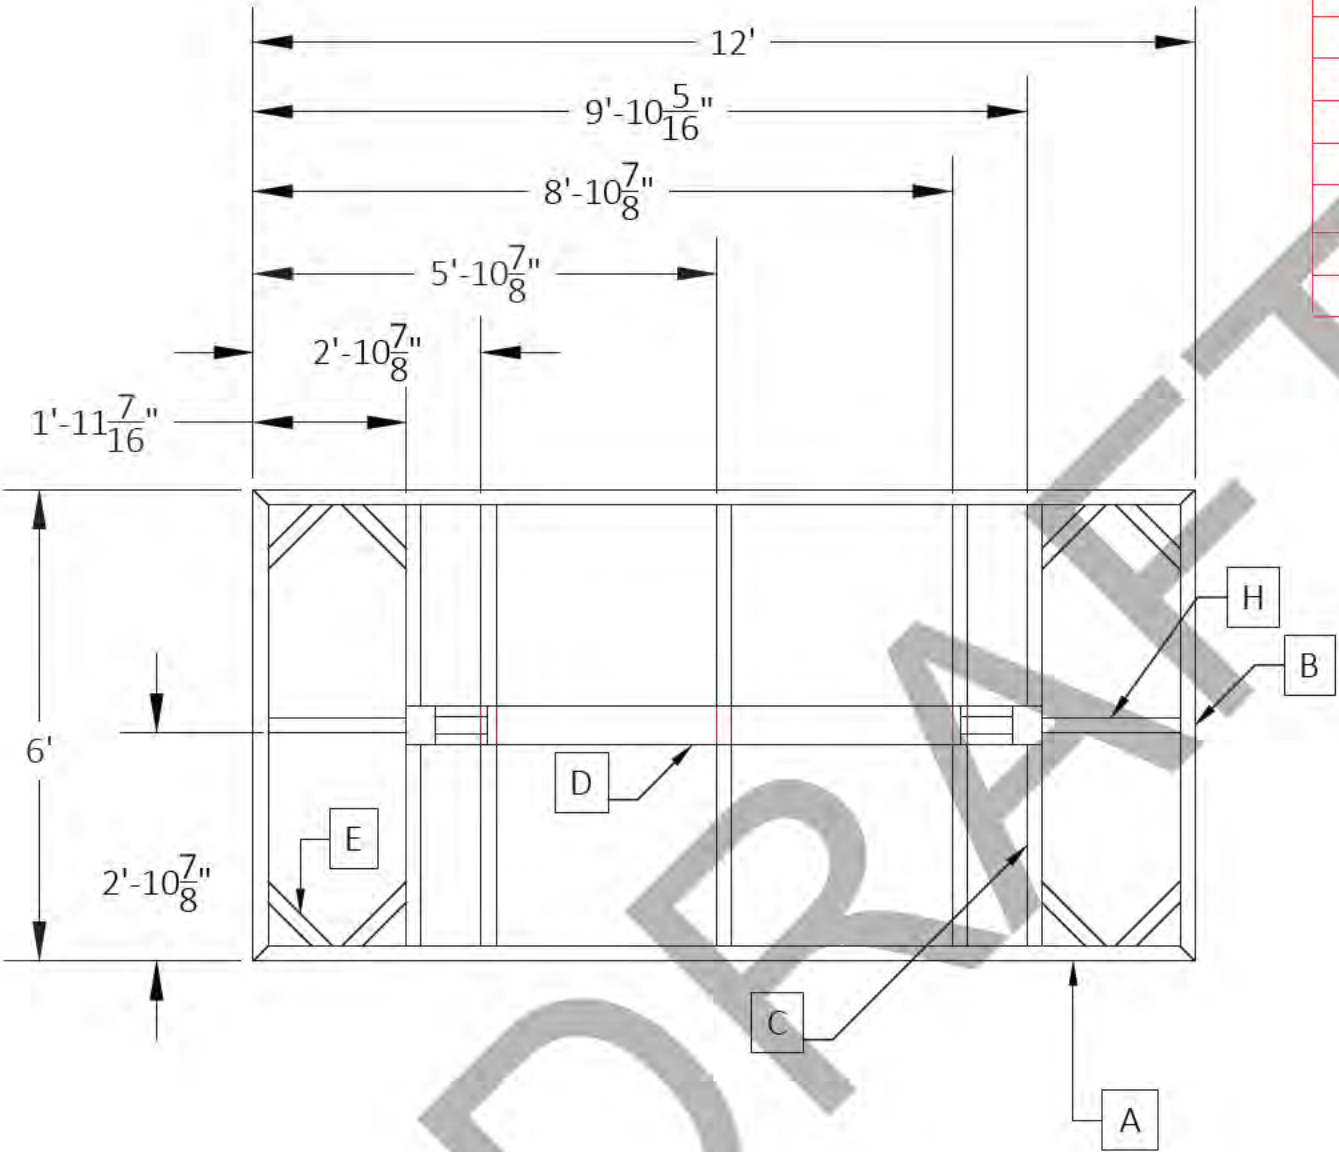

1074


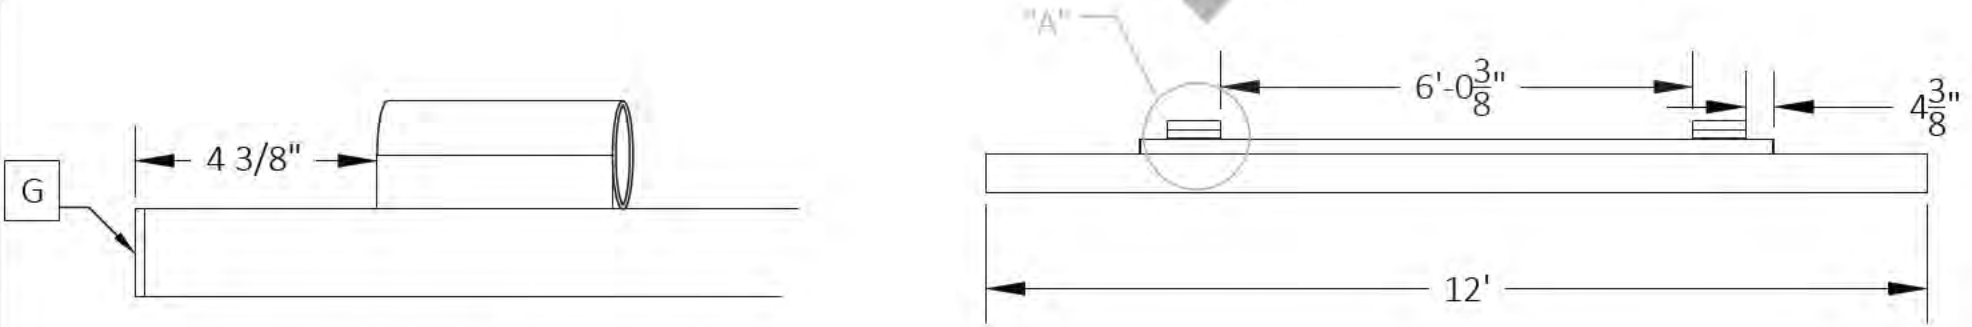


VIEW IN CIRCLE "A"

VIEW IN CIRCLE "B"

-SHEET DETAIL-					
FILE NAME/CUSTOMER ➔		8 SLIP THE PENINSULA LOTS16-23.dwg			
DRAWN: 9/19/2023		(2) 6' X 55' RAMPS w/ EQUALIZER EQ			
CHECKED:					
MANAG.APPR:					
ISSUED TO: MANUFACTURE					
DESIGN DRAFTER: R.BAKER		SIZE B	SCALE 1:30	DWG TYPE/NO.	REV 0
FABRICATOR:					SHEET 36 OF 42


CUT/STOCK LIST							
DIE NUMBER	ITEM	QTY.	DESCRIPTION	DEGREE	FT.	IN.	TOTAL FT.
FH-01356	A	2	1/8" X 2" X 2" TUBE	45°-0°	20	0"	40.00
FH-01356	B	2	1/8" X 2" X 2" TUBE	45°-45°	19	4 1/4"	####
FH-01356	C	2	1/8" X 2" X 2" TUBE	45°-45°	1	6"	3.00
FH-01356	D	2	1/8" X 2" X 2" TUBE	0°-2°	1	1/16"	2.01
FH-01356	E	2	1/8" X 2" X 2" TUBE	0°-2°		8 15/16"	####
FH-01356	F	2	1/8" X 2" X 2" TUBE	0°-2°		4 11/16"	0.78
FH-01356	G	2	1/8" X 2" X 2" TUBE	10°-11°	4	8 7/8"	9.48
FH-01356	H	2	1/8" X 2" X 2" TUBE	9°-10°	4	11 1/4"	9.88
FH-01356	I	2	1/8" X 2" X 2" TUBE	2°-3°	4	10 1/2"	9.75
FH-01356	J	5	1/8" X 2" X 2" TUBE	0°-0°	5	8"	28.33
FH-01356	K	10	1/8" X 2" X 2" TUBE	0°-2°	1	5"	14.17

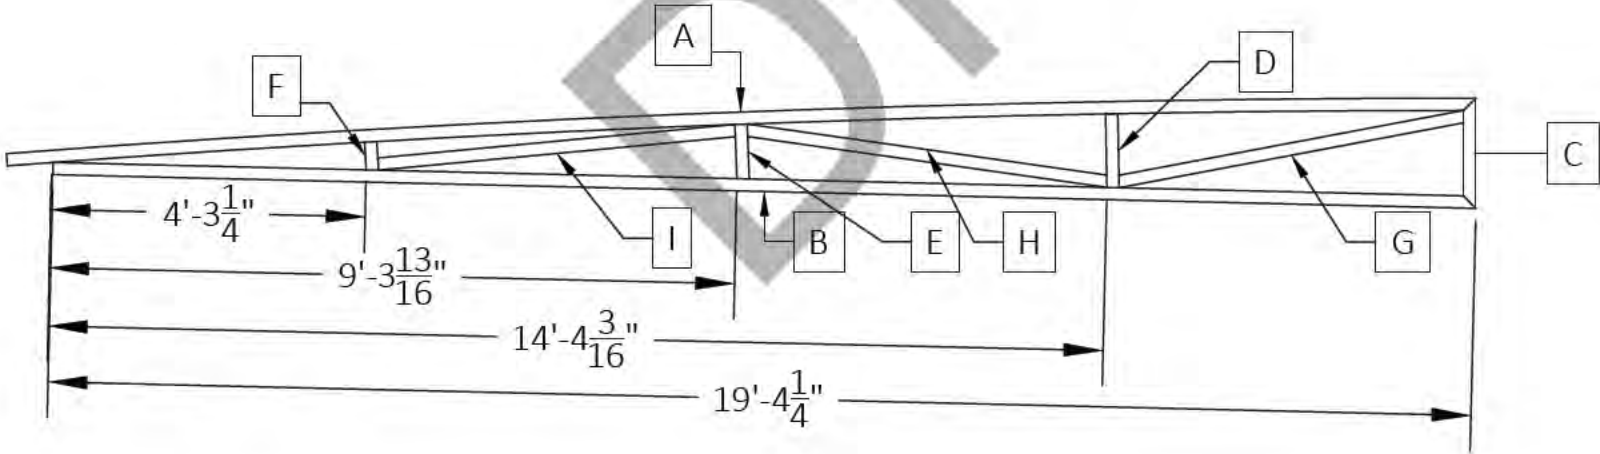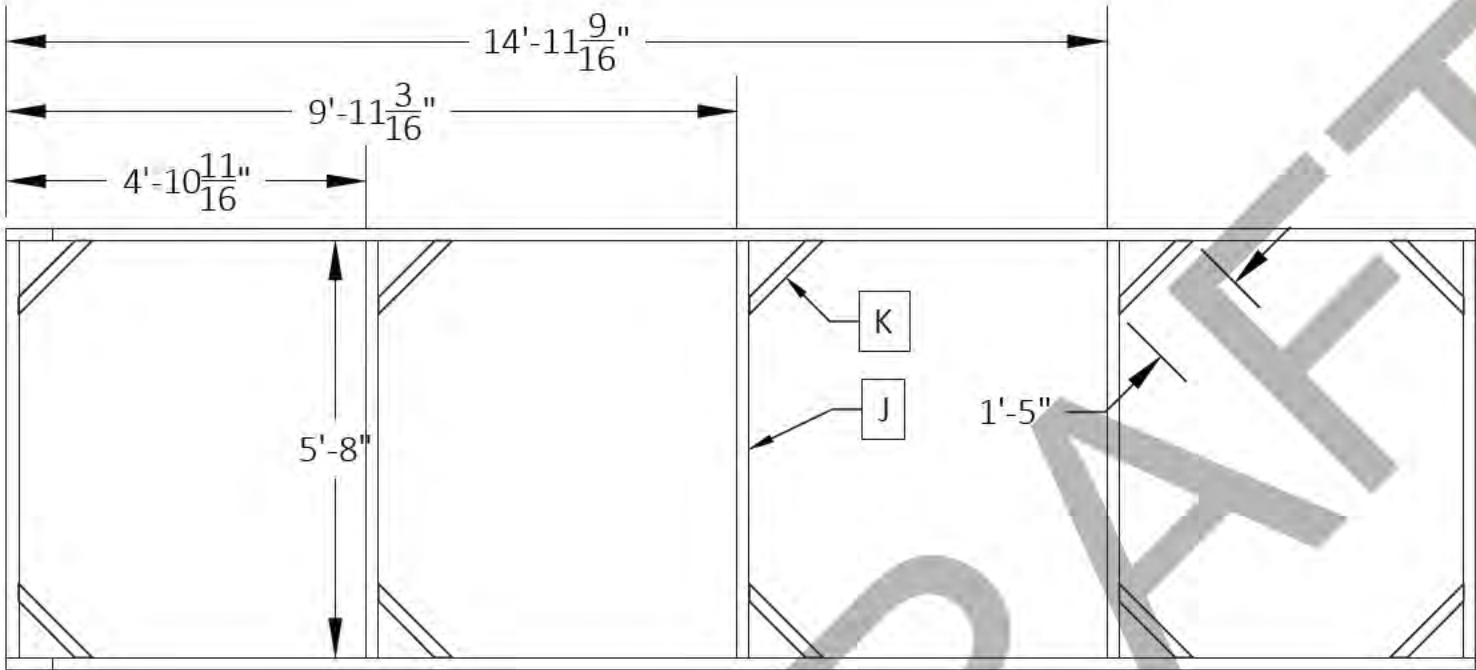

(4)REQUIRED

—SHEET DETAIL—		8 SLIP THE PENINSULA LOTS16-23.dwg			
FILE NAME/CUSTOMER ➔					
DRAWN: 9/19/2023		(2) 6' X 55' RAMPS w/ EQUALIZER UC			
CHECKED:					
MANAG.APPR:					
ISSUED TO: MANUFACTURE					
DESIGN DRAFTER: R.BAKER		SIZE B	SCALE 1:32	DWG TYPE/NO.	REV 0
FABRICATOR:					SHEET 37 OF 42


STOCK LIST		
DET. NO.	QTY.	DESCRIPTION
A	36	2 1/2" X 2 1/2" ANGLE 3'-6 7/16" LG. TO SH. 5'-5'
	18	BEING OPPOSITE HAND
B	18	2 1/2" X 2 1/2" ANGLE 8" LG.

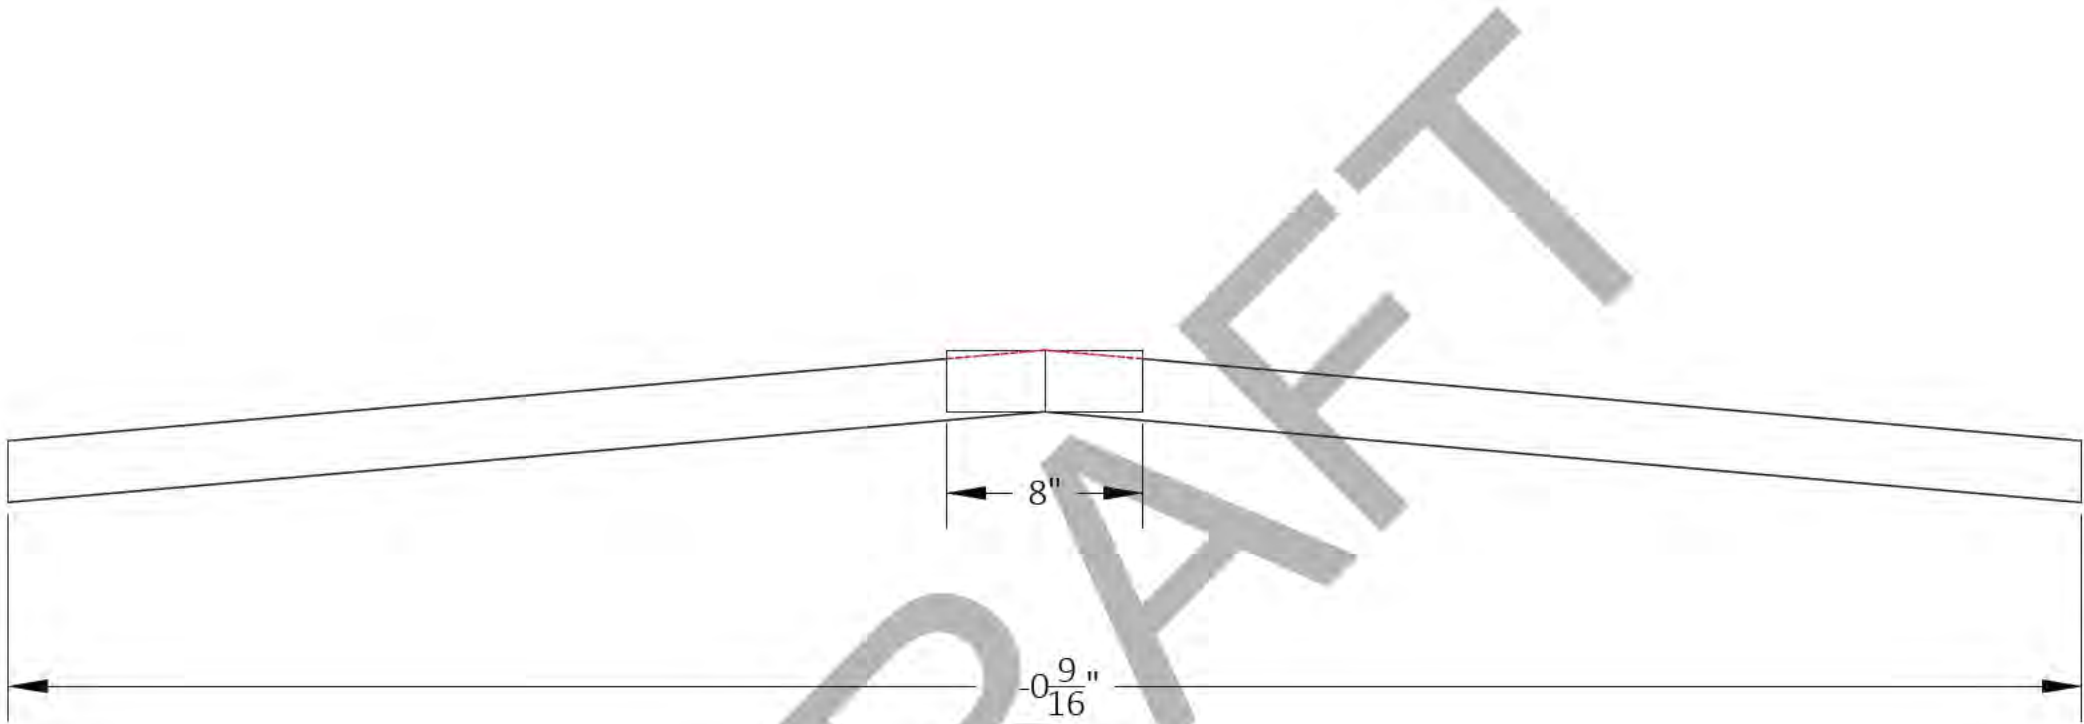

1068
(18) REQUIRED

-SHEET DETAIL-				
FILE NAME/CUSTOMER ➔		8 SLIP THE PENINSULA LOTS16-23.dwg		
DRAWN: 9/19/2023		1068		
CHECKED:				
MANAG.APPR:				
ISSUED TO: MANUFACTURE				
DESIGN DRAFTER: R.BAKER	SIZE B	SCALE 1:8	DWG TYPE/NO.	REV 0
FABRICATOR:				SHEET 38 OF 42

STOCK LIST		
DET. NO.	QTY.	DESCRIPTION
A	2	1 7/16" ALUM. ROD 42" LG.
B	2	2" OD UHMW TUBING 42" LG.
C	4	1/4" ALUM. ROUND PLUG
D	2	1 7/16" ALUM. ROD 44" LG.
E	2	2" OD UHMW TUBING 44" LG.

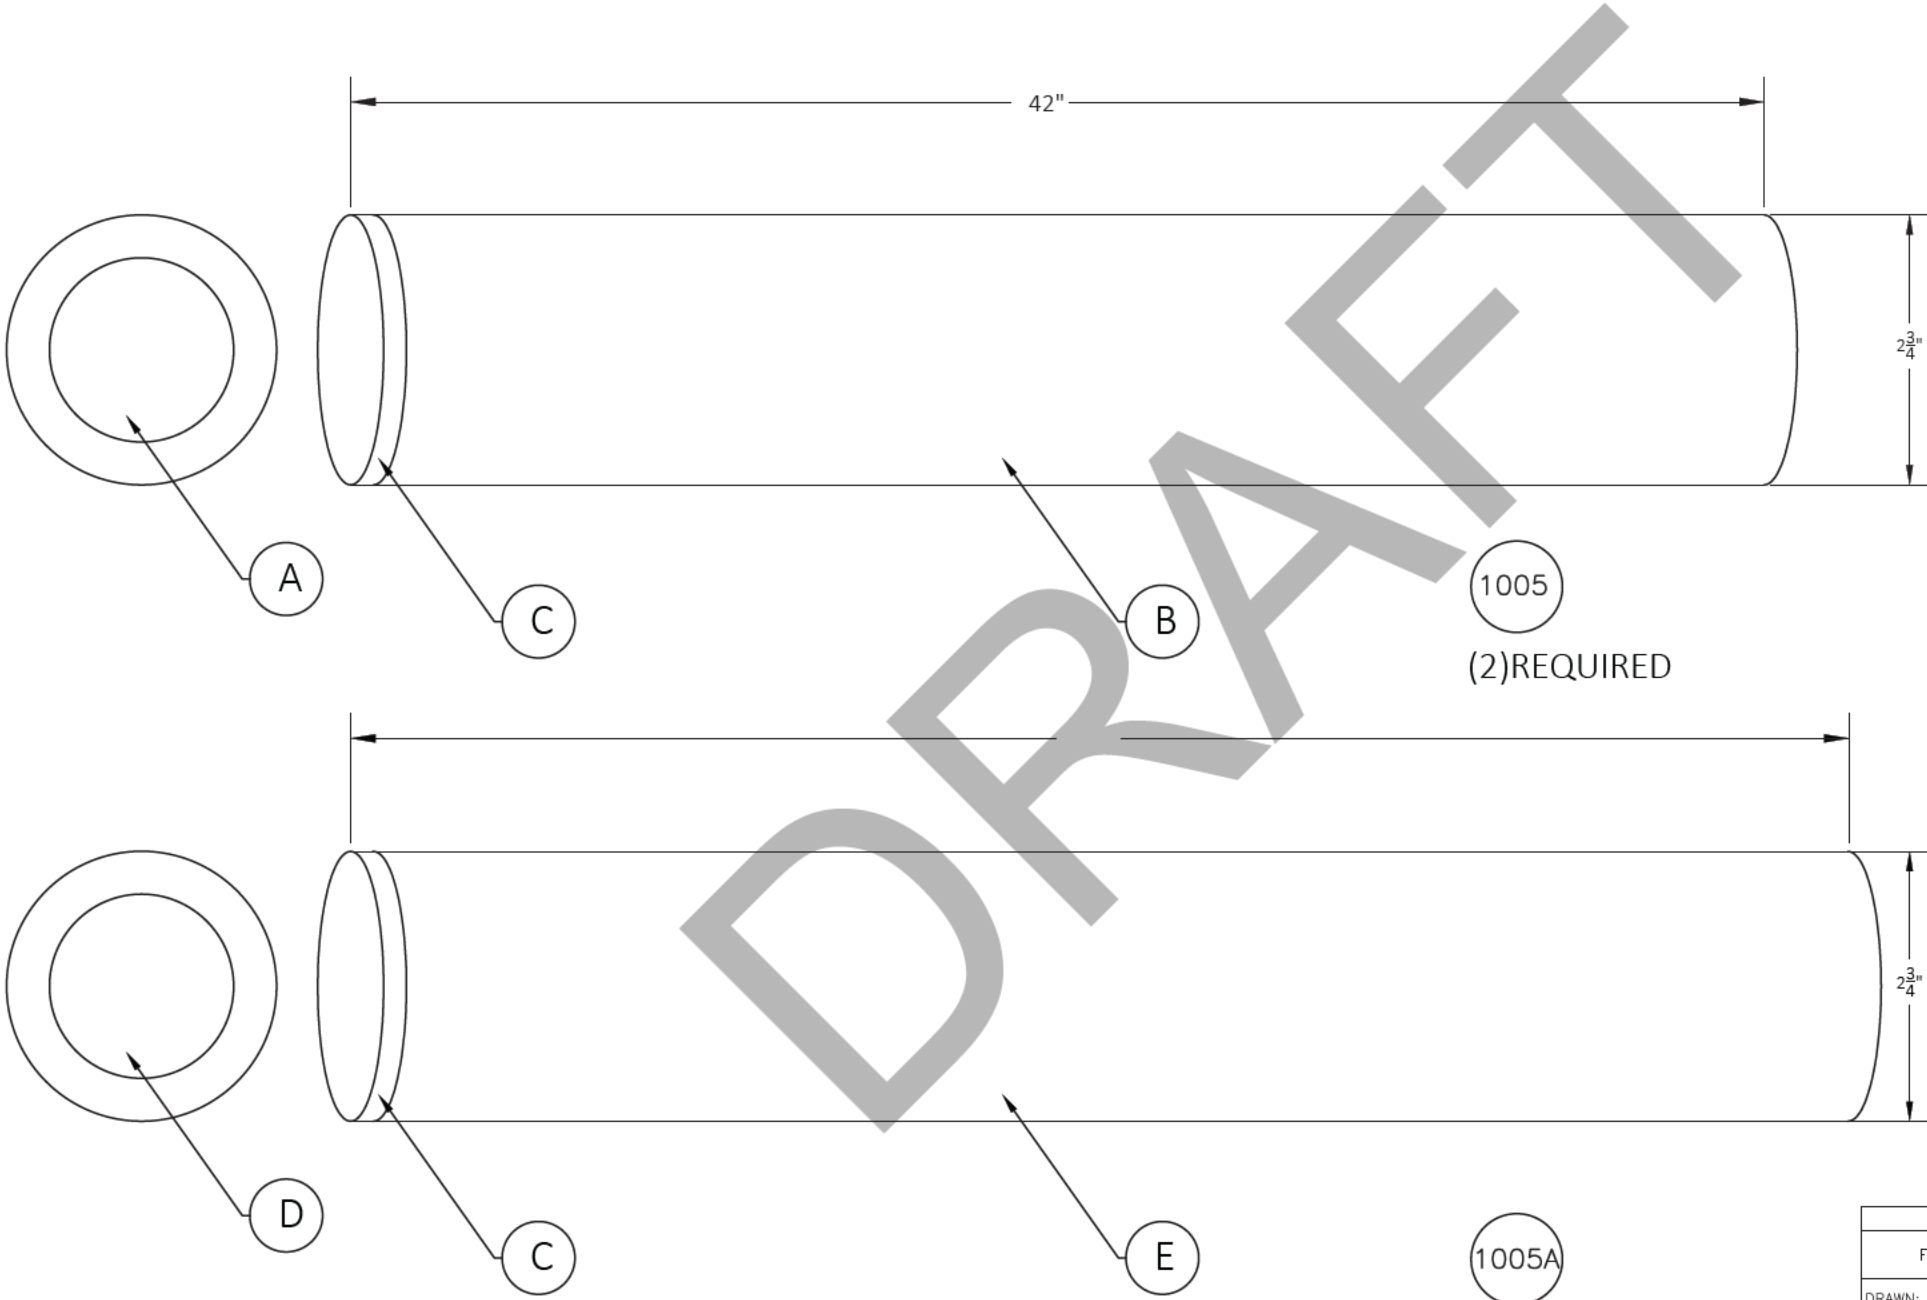

1005
(2)REQUIRED

1005A
(2)REQUIRED



-SHEET DETAIL-					
FILE NAME/CUSTOMER ➔		8 SLIP THE PENINSULA LOTS16-23.dwg			
DRAWN: 9/19/2023		1005			
CHECKED:					
MANAG.APPR:					
ISSUED TO: MANUFACTURE					
DESIGN DRAFTER: R.BAKER		SIZE B	SCALE 1:2	DWG TYPE/NO.	REV 0
FABRICATOR:					SHEET 39 OF 42

NOTE:
THIS HARDWARE INCLUDED IN PACKAGE !


STOCK LIST		
DET. NO.	QTY.	DESCRIPTION
A	2	3/16" X 3" X 3" ALUM. ANGLE 2'-11 1/2" LG.
B	6	1/4" X 6" ALUM. PLATE 2" LG.
C	2	BLACK VERTICAL "NO LIP" BUMPERS

CENTER BUMPER TO THE ANG E!!

DO NOT
WELD PLATES
TO ANGLE
HERE !!

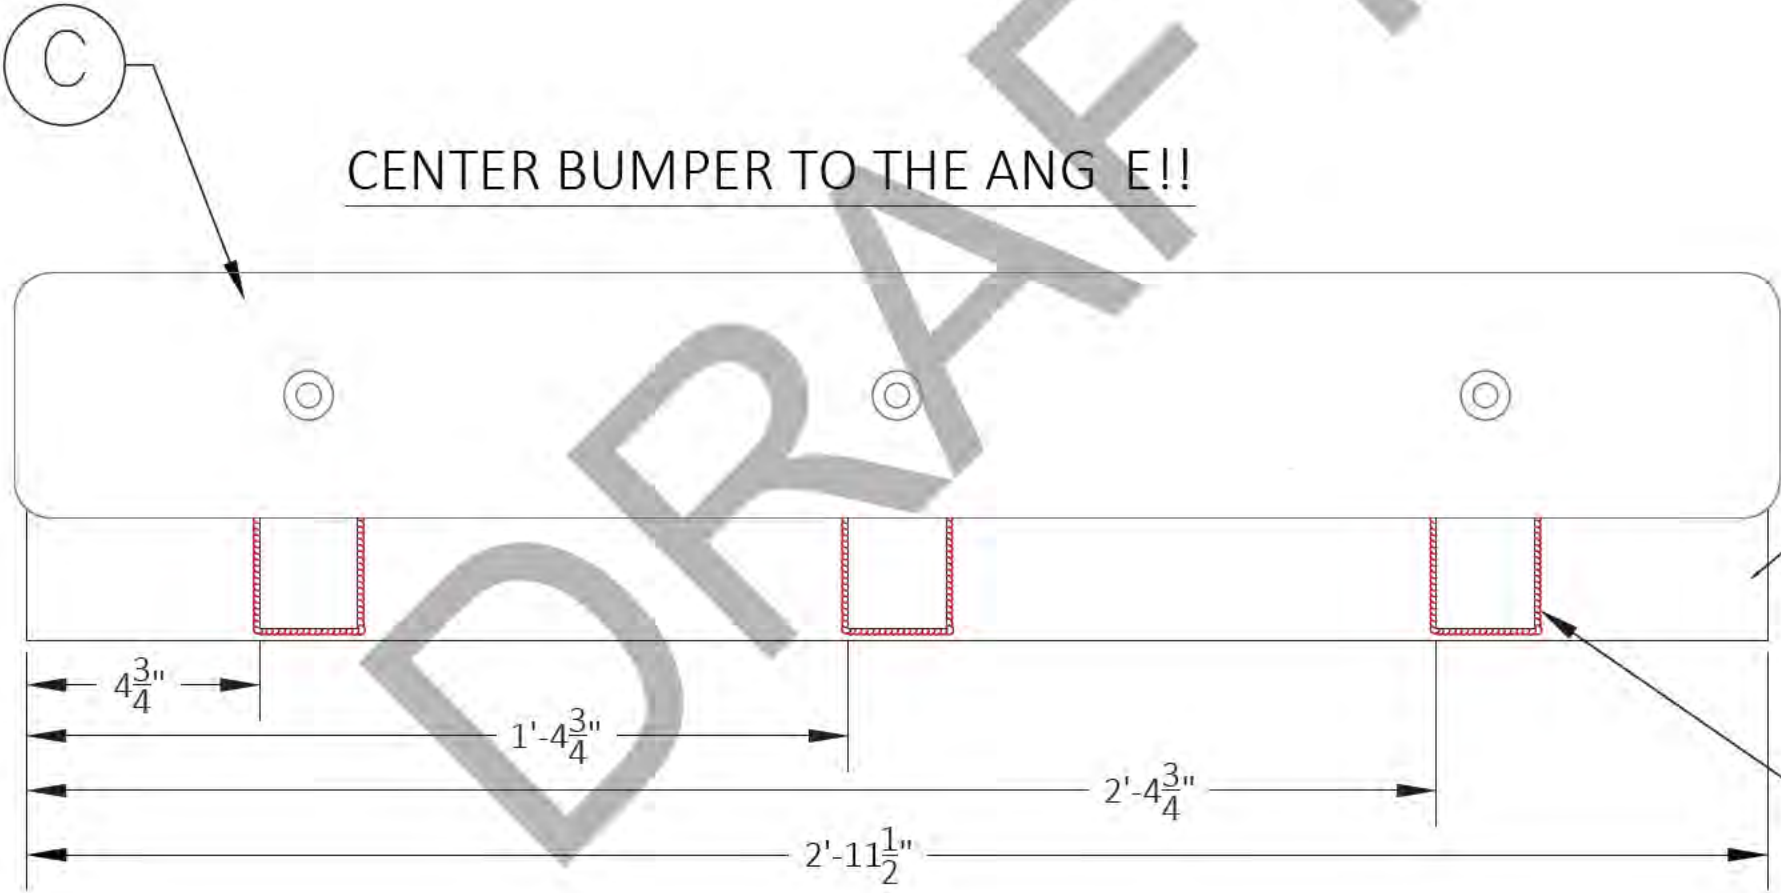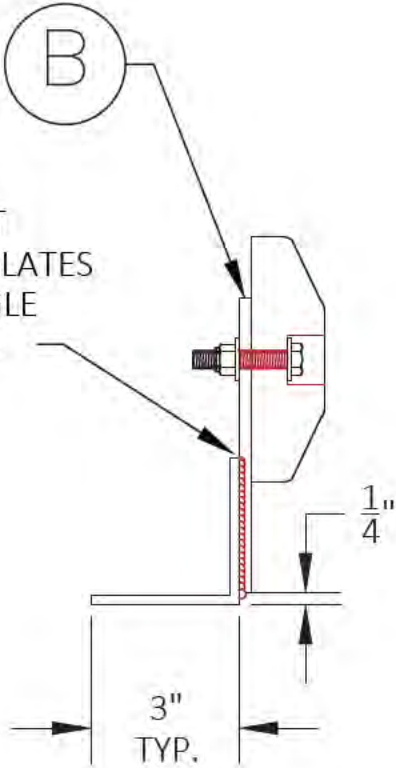

WELD PLATES TO THE
ANGLE ON THESE
THREE SIDES ONLY !!

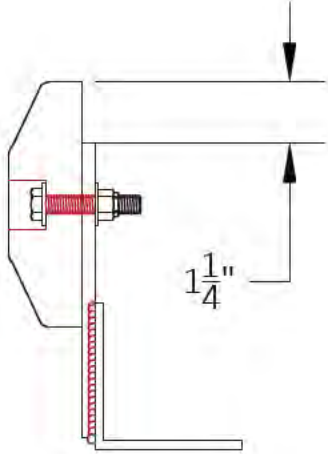


1033

-SHEET DETAIL-			
FILE NAME/CUSTOMER		8 SLIP THE PENINSULA LOTS16-23.dwg	
DRAWN: 9/19/2023		1005	
CHECKED:			
MANAG.APPR:			
ISSUED TO: MANUFACTURE			
DESIGN DRAFTER: R.BAKER		SIZE B	SCALE 1:4
FABRICATOR:		DWG TYPE/NO.	
		REV 0	
		SHEET 40 OF 42	

➔ ACCESSORIES ➔			
QTY.	DESCRIPTION	PC	COLOR
45	HORIZONTAL BUMPER		
20	CORNER BUMPER		
40	SUPER CUSHION		
2	DIAGONAL CABLES (RAMP)		
108	POST TRIM (2pc. - # of post)		
1	ROLLER GUIDE ASSEMBLY		
35	FLOAT PLUGS		
38	CLEATS		
33	20' STAIR NOSING (stick)		
2	RAMP WEIGHT LIMIT TAG		
19	4" PVC CAPS		
19	SPUD POLE **SILENCERS**		
19	4" GALVANIZED SPUD POLES		
2	DECKING TOUCH-UP		

-SHEET DETAIL-		8 SLIP THE PENINSULA LOTS16-23.dwg			
FILE NAME/CUSTOMER ➔					
DRAWN: 9/19/2023		ACCESSORIES			
CHECKED:					
MANAG.APPR:					
ISSUED TO: MANUFACTURE					
DESIGN DRAFTER: R.BAKER		SIZE B	SCALE 1:20	DWG TYPE/NO.	REV 0
FABRICATOR:				SHEET 41 OF 42	

-SHEET DETAIL-		8 SLIP THE PENINSULA LOTS16-23.dwg				
FILE NAME/CUSTOMER ➔		LOAD LIST				
DRAWN: 9/19/2023						
CHECKED:						
MANAG.APPR:						
ISSUED TO: MANUFACTURE						
DESIGN DRAFTER: R.BAKER		SIZE B	SCALE 1:36	DWG TYPE/NO.		REV 0
FABRICATOR:					SHEET 42 OF 42	

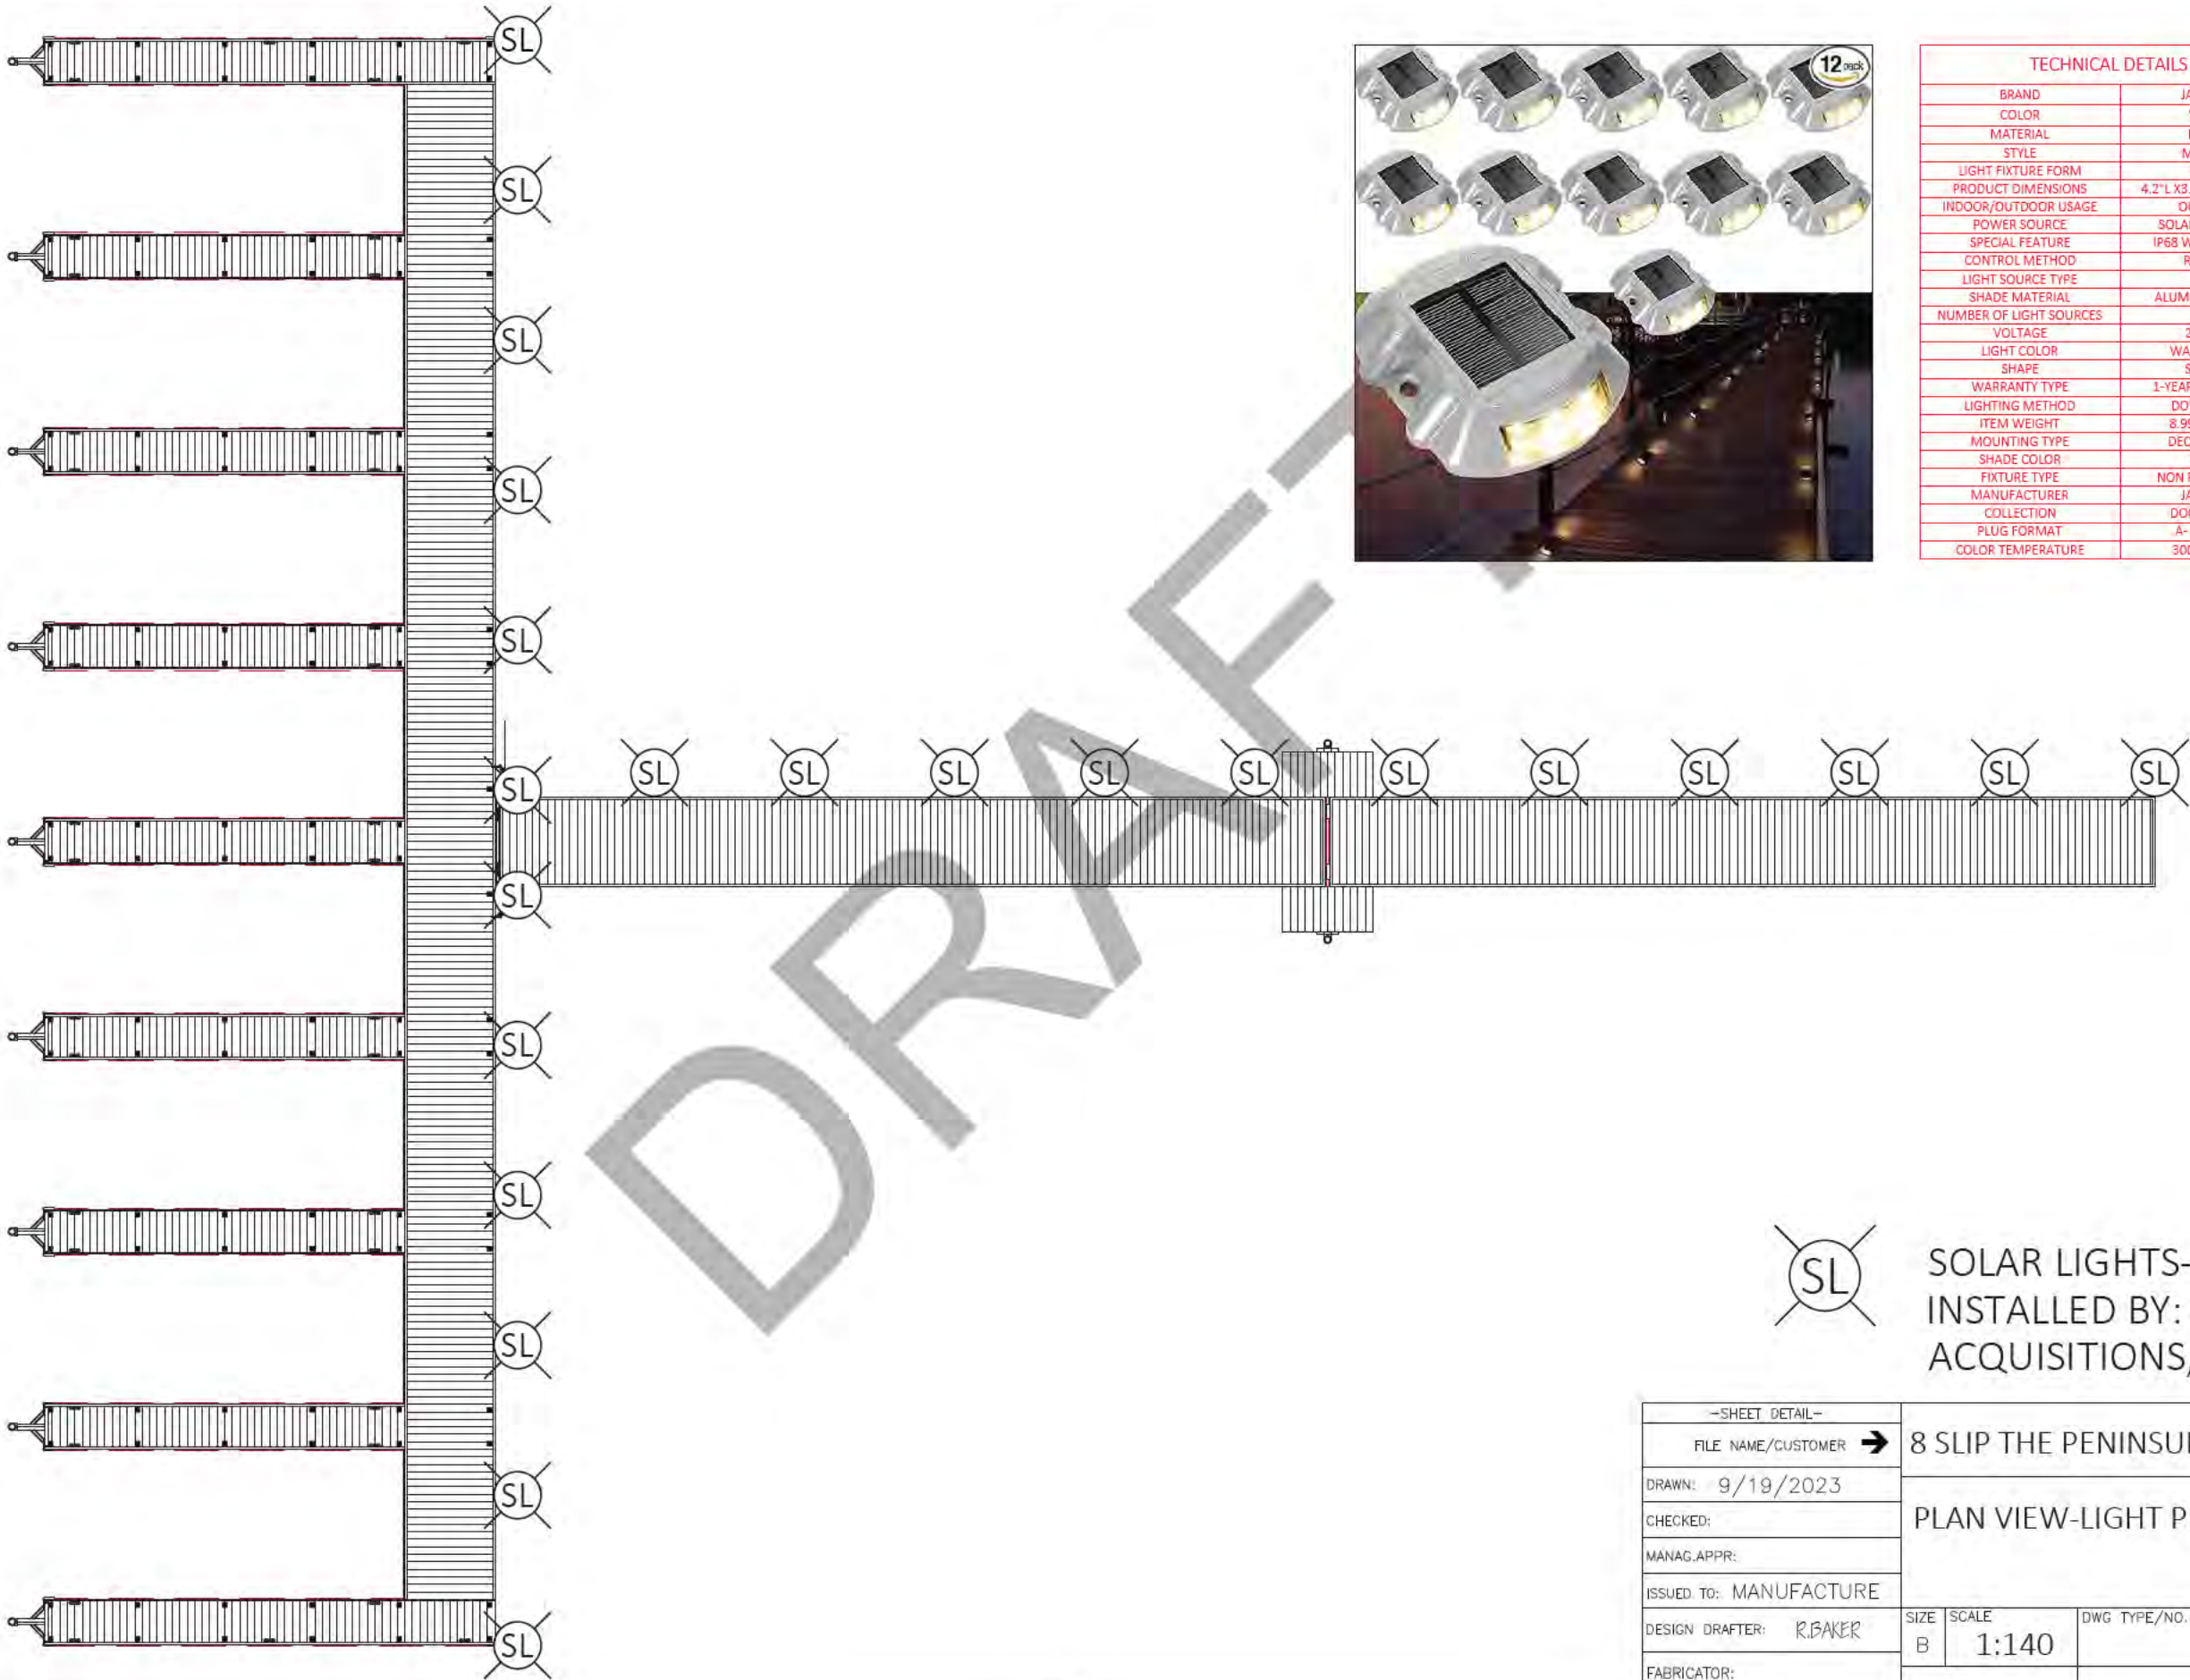

TECHNICAL DETAILS	
BRAND	JACKYLED
COLOR	WARM
MATERIAL	METAL
STYLE	MODERN
LIGHT FIXTURE FORM	PATH
PRODUCT DIMENSIONS	4.2"L X3.37"W X 0.94"H
INDOOR/OUTDOOR USAGE	OUTDOOR
POWER SOURCE	SOLAR POWERED
SPECIAL FEATURE	IP68 WATERPROOF
CONTROL METHOD	REMOTE
LIGHT SOURCE TYPE	LED
SHADE MATERIAL	ALUMINUM ALLOY
NUMBER OF LIGHT SOURCES	6
VOLTAGE	2 VOLTS
LIGHT COLOR	WARM LIGHT
SHAPE	SQUARE
WARRANTY TYPE	1-YEAR WARRANTY
LIGHTING METHOD	DOWNLIGHT
ITEM WEIGHT	8.99 POUNDS
MOUNTING TYPE	DECK MOUNT
SHADE COLOR	WHITE
FIXTURE TYPE	NON REMOVABLE
MANUFACTURER	JACKYLED
COLLECTION	DOCK LIGHTS
PLUG FORMAT	A- US STYLE
COLOR TEMPERATURE	3000 KELVIN



SOLAR LIGHTS- SUPPLIED AND
INSTALLED BY: BD
ACQUISITIONS, LLC.

-SHEET DETAIL-		8 SLIP THE PENINSULA LOTS16-23.dwg	
FILE NAME/CUSTOMER →		PLAN VIEW-LIGHT PLACEMENT	
DRAWN: 9/19/2023			
CHECKED:			
MANAG.APPR:			
ISSUED TO: MANUFACTURE			
DESIGN DRAFTER: R.BAKER		SIZE B	SCALE 1:140
FABRICATOR:		DWG TYPE/NO.	REV 0
		SHEET 5 OF 42	

EXHIBIT B

Shoreline Lease and Use Agreement

DRAFT

**SHORELINE LEASE AND USE AGREEMENT
BETWEEN NORTH TEXAS MUNICIPAL WATER DISTRICT and
THE PENINSULA & SHORES POA**

This Shoreline Lease and Use Agreement (the “Agreement”) is between North Texas Municipal Water District (“NTMWD” or “District”), a wholesale water and wastewater provider that owns and operates Bois d’Arc Lake (the “Lake”) in Fannin County, Texas, and BD Acquisitions, LLC. (“Developer”) and The Peninsula & Shores POA (the “Association”), which serves The Peninsula and The Shores at the Peninsula (Developer and Association may collectively be referred to as “Lessee”). NTMWD and Lessee may also be referred to individually as a “Party” or collectively as the “Parties.”

Recitals

WHEREAS, NTMWD and Lessee are authorized to enter into this Agreement pursuant to Chapter 62, Acts of the 52nd Legislature, 1951 (Article 8280-141, Vernon’s Texas Civil Statutes) and other applicable laws;

WHEREAS, NTMWD operates Bois d’Arc Lake (the “Lake”) as a public drinking water supply reservoir and allows opportunities for public recreation on the Lake;

WHEREAS, Developer owns land adjacent to NTMWD-owned property at the Lake (the “Property”) that is subject to the Peninsula and the Shores at the Peninsula covenants, conditions, and restrictions that are included herein as **Exhibit X**;

WHEREAS, Lessee seeks to lease and use the adjacent NTMWD-owned property (the “Leased Property”) and maintain improvements on the Leased Property, including structures and facilities on or over the water surface of the Lake (the “Improvements”) constructed by Developer pursuant to that certain Preliminary Development Agreement between the North Texas Municipal Water District and BD Acquisitions, LLC, effective September __, 2024 (the “Development Agreement”);

WHEREAS, the Association is the legal entity presiding over all shared Improvements within The Peninsula & The Shores At the Peninsula communities and no other agreements will be allowed for shared Improvements on the Leased Property that were not part of the Development Agreement;

WHEREAS, Lessee acknowledges there is a Permanent Flowage and Flood Easement (the “Easement”) associated with Property, on land located between the 541 feet mean sea level (“MSL”) and 545 MSL contour elevations;

WHEREAS, Lessee is aware the conditions of the Easement are permanently in effect and are separate from the requirements and conditions of this Agreement and the Shoreline Management Plan (“SMP”);

WHEREAS, this Agreement may authorize certain uses of the Easement, in addition to uses of the Leased Property, which shall not be inconsistent with conditions of the Easement, but

may impose further restrictions on the Easement, for which Lessee agrees to comply with, in accordance with the terms of this Agreement;

WHEREAS, Developer completed construction of the Improvements on [REDACTED], 202 [REDACTED] (the "Project"); and

WHEREAS, pursuant to the Development Agreement, Lessee is required to enter into this Agreement, has reviewed this Agreement, and accepts its terms and conditions, including the general and special conditions described herein.

NOW THEREFORE, in consideration of the mutual covenants and agreements herein contained, NTMWD agrees to grant Lessee the right to lease and use the Leased Property, and Lessee agrees to pay for such lease and use, upon the terms and conditions and for the consideration hereinafter set forth, to wit:

Lessee Information

Name: BD Acquisitions, LLC.

Telephone, Area Code, and Number: 912-223-4390

Email: logue@llcinvest.com

Address: 9827 Cogdill Rd. Suite #1

City, State Zip Code: Knoxville TN 3732

Legal Description of Boundary Line with Leased Property (Survey attached)

XXXXXX, an addition to Fannin County, Texas according to the map and plat thereof recorded at XXXXXXXX Official Map and Plat Records of Fannin County, Texas

Improvements Description (Specific structures and facilities) including a Site Plan

Use Description (Specific use and activities authorized)

The following specific uses and activities are hereby authorized so long as such uses and activities are in compliance with the General Conditions of this Agreement and the SMP. Any uses or activities not authorized, such as a Special Event Authorization, must be separately authorized by NTMWD.

GENERAL CONDITIONS

1. **REFERENCES.** Except as otherwise specifically provided, any reference herein to NTMWD shall include its duly authorized representatives. Any reference to “Lessee” shall include their duly authorized representatives.
2. **AGREEMENT FEES.** Lessee shall pay, in advance, to NTMWD, compensation in accordance with **Exhibit X**. Fees are subject to change upon renewal of the Agreement.
3. **AGREEMENT SCOPE.** This Agreement is entered into solely with Lessee for the purpose described in this Agreement. The exercise of the privileges herein granted shall be:
 - a. without cost or expense to NTMWD;
 - b. subject to the right of NTMWD to improve, use, or maintain the Leased Property;
 - c. subject to other outgrants of NTMWD on the Leased Property except as otherwise provided herein;
 - d. this Agreement, or any interest therein, may not be transferred or assigned without the prior express written approval of NTMWD.
4. **TERM.** This Agreement shall be for a term of five (5) years with Lessee having the sole option to extend the Agreement for subsequent five-year terms subject to NTMWD revising the terms and conditions of the Agreement at the time of each renewal with such revisions being consistent with revisions made on other shoreline lease and use agreements, including but not limited to a current or updated fee/fine schedule. At least ninety (90) days prior to expiration of the Agreement and any renewal thereof, Lessee may provide a Notice to Surrender its rights under the Agreement and elect to not renew the Agreement.
5. **RELEASE.** Upon the completion of Improvements as set forth herein and the transfer of Improvements to the Association, Developer may assign its rights and obligations under this Agreement to the Association and be released from Developer’s obligations and surrender any and all rights Developer may have under this Agreement to the Association with the prior express written approval of NTMWD.
6. **NOTICE.** Unless otherwise provided herein, any notice, communication, request, reply or advice (herein severally and collectively, for convenience, called “Notice”) herein provided or permitted to be given, made or accepted by any Party to any other Party must be in writing and may be given or be served by depositing the same in the United States mail postpaid and registered or certified and addressed to the Party to be notified, with return receipt requested, or by delivering the same to an officer of such Party, or by electronic mail, addressed to the Party to be notified at the email address provided below. Notice deposited in the mail in the manner described above shall be conclusively deemed to be effective, unless otherwise stated herein, from and after the expiration of three (3) days after it is so deposited. Notice given in any other manner shall be effective only if and when received by the Party to be notified. For the purposes of notice, the contact information of the Parties shall, until changed as hereinafter provided, be as follows:

If to Developer
or Association:

If to NTMWD, to:

Jennafer P. Covington
Executive Director/General Manager
North Texas Municipal Water District
P.O. Box 2408
Wylie, Texas 75098
972-442-5405
jcovington@ntmwd.com

The Parties hereto shall have the right from time to time and at any time to change their respective contact information and each shall have the right to specify as its contact information any other contact information by at least fifteen (15) days' written notice to the other Party hereto.

7. **OPERATION, MAINTENANCE REPAIR, & REPLACEMENT.** The operation, maintenance, repair, or replacement of Improvements authorized by this Agreement shall be performed at no cost or expense to NTMWD and subject to the express written approval of NTMWD. Anything not expressly authorized in writing by NTMWD as an Improvement activity or an approved deviation from an Improvement activity is expressly prohibited. Upon the completion of any of such operation maintenance, repair or replacement, Lessee shall immediately restore the Leased Property to the satisfaction of NTMWD. The use and occupation of the Leased Property for the purposes herein granted shall be subject to NTMWD's property ownership rights, the policies as set forth in the SMP, and to all applicable federal, state, and local laws and regulations. If Improvements are removed for storage or extensive maintenance, NTMWD may require portions of the Improvements be removed from the Leased Property. Further, Lessee agrees to operate and maintain any Improvements and/or use in a manner so as to provide safety, minimize any adverse impact on fish and wildlife habitat, natural, environmental, or cultural resource values and in a manner so as to minimize the degradation of water quality.
8. **COMMUNITY FACILITY USE AND ACCESS.** NTMWD is not responsible for managing or maintaining access to, or use of, any Lessee community facilities located on the Leased Property. Lessee has sole responsibility of operation and maintenance of all Lessee community facilities located on the Leased Property. Lessee further has sole responsibility for interacting with individual property owners of the Association regarding access to, and use of, the Leased Property (including community facilities), and shall be solely responsible for ensuring property owners do not violate any terms of this Agreement. Any violation of this Agreement by an individual property owner shall be deemed a violation of this Agreement by Lessee and Lessee will be responsible for paying fines imposed by NTMWD due to violations by individual property owners, unless and excepting any improvements made by individual property owners after obtaining an individual Shoreline Lease and Use Agreement from NTMWD. Association shall continue to enforce covenants and restrictions, but individual lessees shall be solely responsible for

paying any fines imposed by NTMWD pursuant to the individual's Shoreline Lease and Use Agreement.

9. **LESSEE INSPECTION.** Lessee acknowledges it shall inspect the Improvements at reasonable intervals and immediately repair any defects found by such inspection or when required by NTMWD to repair any such defects.
10. **LESSEE'S REPRESENTATIONS.** Lessee represents that it will not be in violation of any regulations or restrictions imposed by Fannin County, Texas, or by any deed restrictions that may be attached to the Property, and that any required variance has been secured. Lessee further agrees to fully enforce the covenants, conditions, and restrictions of Association, as included in **Exhibit X** and as amended from time to time, against individual property owners of the Association. NTMWD assumes no responsibility for, and Lessee will hold NTMWD harmless from, disputes of title, rights, or liability for damages to persons or property arising from the construction operation, maintenance, repair, or existence of any Improvements on the Leased Property. If at any time, the condition or presence of the Improvements interferes with the operation of the Lake or the safety of persons or property using the surface thereof Lessee agrees to immediately make any and all changes or corrections necessary to make the Improvements comply with this Agreement or remove the Improvements from the Leased Property at Lessee's expense.
11. **RELEASE & ASSUMPTION OF RISK.** Lessee acknowledges that Bois d'Arc Lake is not a "constant level" or "controlled level" lake and is **SUBJECT TO DROUGHT OR FLOODING WITHOUT WARNING.** Lessee acknowledges and agrees that the Leased Property is accepted **"AS-IS, WHERE-IS"** with all defects, whether known or unknown. Lessee recognizes the risk inherent in owning, operating, and maintaining Improvements in close proximity to, and over, the Lake because of the risks associated with flooding, high water, and drought conditions. These risks include, but are not limited to, lake level fluctuation resulting in Improvements, such as docks, being completely unusable during flood or drought conditions, which can extend over months or years, as it relates to multi-year drought conditions. As a condition of, and in consideration for, NTMWD's entering into this Agreement, as between NTMWD and Lessee, Lessee **AGREES TO ASSUME ALL RISK** of destruction of or damage to any Improvements and the property of Lessee or third parties located on the Property, Leased Property or Easement and to assume all risk of bodily injury or death to any person on the Property, Leased Property or Easement associated with the Improvements resulting from any cause. As part of the assumption of risk, Lessee, for itself and its heirs and assigns, **EXPRESSLY RELEASES NTMWD FROM ALL LOSS, COSTS, AND LIABILITY FOR (1) DAMAGE OR DESTRUCTION TO ANY OF ITS PROPERTY LOCATED ON OR AT THE PROPERTY, LEASED PROPERTY OR EASEMENT RESULTING FROM ANY CAUSE AND (2) BODILY INJURY OR DEATH TO LESSEE OR ANY FAMILY MEMBER OR OTHER PERSON AT THE PROPERTY, LEASED PROPERTY OR EASEMENT.**

12. **INDEMNIFICATION.** NTMWD shall have no liability whatsoever, either to Lessee, Lessee's successors, assigns, guest invitees or any other third party, for property damage to Lessee's Improvements or the contents thereof, **EVEN IF CAUSED BY NTMWD'S NEGLIGENCE.** NTMWD shall not be liable to Lessee or Lessee's guests, visitors, invitees or to any other person whomsoever, for any injury to person or damage to property on or about the Property, Leased Property or Easement due to **ANY CAUSE WHATSOEVER, INCLUDING WITHOUT LIMITATION, INUNDATION OR FLOODING OF THE PROPERTY, LEASED PROPERTY OR EASEMENT OR THE EFFECTS OF DROUGHT,** and Lessee agrees to indemnify NTMWD and hold it harmless from any loss, expenses, or claims including attorney's fees, arising out of any such damage or injury, **INCLUDING INJURY TO PERSON OR DAMAGE TO PROPERTY THE SOLE OR CONTRIBUTING CAUSE OF WHICH IS THE NEGLIGENCE OF NTMWD.** If any action or proceeding is brought against NTMWD by reason of any such claim, Lessee, upon notice from NTMWD, will defend such action or proceeding with counsel acceptable to NTMWD.
13. **WAIVER OF ANY TAKINGS CLAIM.** Lessee **WAIVES ANY CLAIM IT MAY NOW OR IN THE FUTURE HAVE AGAINST NTMWD FOR A STATE OR FEDERAL "TAKINGS" or "INVERSE CONDEMNATION"** of either the Property or the Improvements or the portion of the Lease Property or Easement on which the Improvements are located resulting from Lake levels being inconstant or from flooding, high water, drought, or similar occurrence, even if any of these occurrences are caused or alleged to be caused, in whole or in part, by NTMWD, whether through NTMWD's negligence or otherwise.
14. **NO GOODS OR SERVICES PROVIDED TO NTMWD.** The Parties agree that pursuant to this Agreement Lessee is not providing any "goods or services" to NTMWD and this Agreement is not a contract subject to Chapter 271, Subchapter I of the Texas Local Government Code because no "goods or services," as such terms have been interpreted by courts of the State of Texas, are provided by Lessee to NTMWD pursuant to this Agreement.
15. **DAMAGE TO LEASED PROPERTY.** Lessee shall be liable for any and all damage that may be caused to the Leased Property by the activities of Lessee, or individual property owners of Lessee, under this Agreement and shall exercise due diligence in the protection of all property located on the Leased Property against fire or damage from any and all other causes. Any property of NTMWD damaged or destroyed by Lessee, or individual property owners of Lessee, incident to the exercise of the privileges herein granted shall be promptly repaired or replaced by Lessee to a condition satisfactory to NTMWD, or at the election of NTMWD, reimbursement made therefore by Lessee in an amount necessary to restore or replace the property to a condition satisfactory to NTMWD.
16. **NTMWD'S ACCESS TO LEASED PROPERTY.** The right is reserved to NTMWD, its officers, agents, and employees to enter upon the Leased Property at any time and for any purpose necessary or convenient in connection with NTMWD work, to make inspections, to remove any material, except property of Lessee approved for use on the Leased Property,

and/or to make any other use of the lands as may be necessary in connection with NTMWD purposes, and Lessee shall have no claim for damages on account thereof against NTMWD or any officer, agent, or employee thereof. NTMWD's authorized representative shall be allowed to cross Lessee's property, excluding sold individual lots as shown on the recorded Plats unless such access is authorized by separate agreement, as necessary, to inspect Improvements. NTMWD will notify Lessee of any deficiencies noted and will establish a schedule for their correction. No deviation or changes from approved plans for Improvements will be allowed without prior written approval of NTMWD. Any deviations from the Improvements require prior written approval by NTMWD after Lessee submits a request to NTMWD for a deviation in writing. NTMWD has thirty (30) days to review and respond to the request from Lessee. Notwithstanding the foregoing, if NTMWD determines during an inspection that a noncompliance issue concerns a significant imminent threat to the environment or public health, safety, and general welfare, NTMWD may take whatever action necessary within the authority of NTMWD to eliminate such threat, including but not limited to, requiring Lessee to immediately address the noncompliance issue.

- 17. COMPLIANCE WITH APPLICABLE LAWS AND REGULATIONS.** This Agreement is subject to all applicable federal and state laws and any applicable permits, ordinances, rules, orders, and regulations of any local, state or federal governmental authority having or asserting jurisdiction, including but not limited to, the provisions of the latest edition of the National Electrical Code (NEC). Nothing contained herein shall be construed as a waiver of any right to question or contest any such law, ordinance, order, rule, or regulation in any forum, having jurisdiction. This Agreement does not authorize any injury to private property or invasion of private rights or any infringement of local, state or federal laws or regulations, nor does it obviate the necessity of obtaining local, state, or federal assent required by law for the operation, use, maintenance, or repair of the Improvement and/or use.
- 18. RULES AND REGULATIONS.** The Leased Property shall be expressly subject to all rules and regulations promulgated by NTMWD for the construction, use, maintenance, and enjoyment of the Lease Property, including without limitation, all regulations and requirements of NTMWD, now or hereafter enacted. By signing this Agreement, Lessee specifically acknowledges that it has read the applicable requirements of the Bois d'Arc Lake Rules and Regulations, the SMP, and Fannin County Zoning Regulations and agrees that Lessee's use of the Leased Property shall at all times be in compliance with such plans and regulations.
- 19. COMPLIANCE WITH OTHER AGREEMENTS.** Lessee shall remain in compliance with all other agreements between Lessee and NTMWD including, but not limited to, compliance with other agreements related to shoreline activities and applicable Flowage and Flood Easements. Non-compliance with any other NTMWD agreement, contract, lease, or easement shall be considered non-compliance with this Agreement.
- 20. EROSION CONTROL STRUCTURES.** Lessee shall maintain, in a manner satisfactory to NTMWD, all soil and water conservation structures that may be in existence upon the

Leased Property at the beginning of this Agreement, and Lessee shall take appropriate measures to prevent or control soil erosion within the right-of-way herein granted. Lessee agrees to allow any adjacent landowner that holds a lease with NTMWD to connect to shoreline erosion control structures constructed by Lessee in order to facilitate contiguous shoreline erosion control between adjacent leased properties, including maintenance thereof. Any soil erosion occurring outside the Leased Property resulting from the use of the Leased Property shall be corrected by Lessee as directed by NTMWD.

21. **BOAT DOCK FACILITY USE.** Boat dock facilities shall be limited to the mooring of Lessee's, or Lessee's individual property owner's, vessels or watercrafts and the storage of equipment essential to the operation of such vessels or watercrafts. Equipment must be stored in enclosed storage box facilities, such as lockers or equipment closets. Equipment may not be left unsecured or unattended. Chemical and petrochemical products shall not be stored on a boat dock facility at any time and shall not be considered "equipment."
22. **COMMERCIAL ACTIVITIES PROHIBITED.** No attempt shall be made by Lessee to forbid the full and free use by the public of all waters adjacent to the Improvements. No charge may be made for use by others, excepting the assessments to cover non-commercial costs such as property lease payments, insurance, upkeep and maintenance to lot owners, of the Improvement nor shall commercial activities including any form of advertising, be conducted thereon.
23. **HABITATION PROHIBITED.** No habitation is authorized on the Leased Property or the Easement. No Improvements, camping equipment, temporary structures, recreation vehicles, nor any moored vessel shall be used as a place of habitation or as a full or part-time residence or in any manner that gives the appearance of human habitation, including habitation of any pets on the Leased Property or the Easement. Household furnishings are not permitted on boat docks or other structures.
24. **TRANSFER OF INTERESTS.** Improvements authorized under this Agreement will not be rented whether short-term or long-term, directly or indirectly, or through an internet-based company like Airbnb, Inc.), sub-let or provided to others by any means of engaging in commercial activities by Lessee or his/her agent for monetary gain. This does not preclude Lessee from selling total ownership of the Improvements or sub-letting boat slips to lot owners to share in the cost of lease and maintenance of the shared dock. If ownership of the Improvements is sold or transferred, Lessee or new owner will notify NTMWD of the action prior to finalization. The new owner must apply for a new Shoreline Lease and Use Agreement within thirty (30) days or remove the Improvements and restore the Leased Property within sixty (60) days from the date of ownership transfer. The new owner is responsible for paying any recording or processing fees.
25. **RECORD OF AGREEMENT FILED IN OFFICIAL PUBLIC RECORDS.** NTMWD will file a record of this Agreement, referred to as the "Record of Agreement," with the Fannin County Clerk in the Fannin County Official Public Records.

26. **FLOATS AND FLOTATION MATERIALS.** Floats and the flotation material for all docks shall be fabricated of materials manufactured for marine use and in accordance with the approved plans in **Exhibit X**. The float and its flotation material shall be one hundred (100) percent warranted for a minimum of eight (8) years against sinking, becoming waterlogged, cracking, peeling, fragmenting, or losing beads. All floats shall resist puncture and penetration and shall not be subject to damage by animals under normal conditions for the area. All floats and the flotation material used in them shall be fire resistant. The use of new or recycled plastic or metal drums or non-compartmentalized air containers for encasement or floats is prohibited.
27. **ANCHORING.** The gangways to boat docks, fishing piers, or any other overwater structure shall be securely attached to the shore in accordance with the approved plans by means of moorings that do not create tripping hazards along the shoreline or adversely affect the natural terrain or vegetation. Anchoring to vegetation is prohibited.
28. **DREDGING.** Unless authorized in writing by a special condition, this Agreement does not authorize lake dredging. Lake dredging requires an individualized analysis by the United States Army Corps of Engineers ("USACE") to determine whether it must be approved by USACE. Lake dredging may be allowed for community docks, if the following conditions are met: 1) prior to dredging, the applicant must coordinate with NTMWD to obtain express written approval for the dredging activity; 2) if approval from NTMWD is obtained, the applicant must then obtain appropriate state or federal authorizations and/or permits, including a US Clean Water Act Section 404 permit, if required; 3) once any required state or federal authorizations and/or permits are obtained, the applicant must complete the NTMWD agreement process by providing NTMWD with copies of any such required authorization and/or permits; and 4) Lessee must provide NTMWD with notification of the dredging activity that includes the estimated start date and end date for the dredging activity and a description of the specifications and construction methods to be employed during the dredging activity.
29. **IMPROVEMENT STANDARDS.** Docks and other permitted improvements must conform to the standard found in the SMP and **Exhibit X**. These standards address electrical service and lighting, signage, improvement size and length, improvement location and spacing, orientation of the improvement to the shoreline, improvement maintenance, and other features and amenities as described in the SMP. Any deviation from the SMP requirements will be considered a violation of this Agreement.
30. **PERSONAL PROPERTY.** Loose personal property that has the ability to float must be stored in a secure locker or removed from the Leased Property when not in use.
31. **AGREEMENT DISPLAY TAG.** The Agreement Display Tag shall be posted on the Improvements and/or on the land areas covered by the Agreement so that it can be visually checked with ease in accordance with instructions provided by NTMWD.
32. **VEGETATION.** No vegetation other than that prescribed in this Agreement will be damaged, destroyed, or removed. In no event will vegetation be disturbed to the extent the

right-of-way will be subject to erosion or natural beauty destroyed. All disturbed areas shall be seeded, replanted, or given some type of equivalent protection against subsequent erosion. No change in landform such as grading, excavation or filling is authorized by this Agreement. No vegetation planting of any kind may be done, other than that specifically prescribed. Only native species are allowed. An approved native plant list is provided in the SMP.

33. **VEGETATION MODIFICATION.** When vegetation modification is approved to control or remove invasive plants and is authorized by chemical means, the modification will be in accordance with appropriate federal, state, and local laws, rules, and regulations.
34. **LAKE AND SHORELINE ACCESS PRIOR TO LAKE OPENING.** NTMWD will notify Lessee in writing when the Lake is officially open for use. Until NTMWD notifies Lessee, Lessee is not permitted to use the Lake for any purpose, including but not limited to, launching watercraft from the shoreline for recreational use.
35. **LAKE AND SHORELINE ACCESS AFTER LAKE OPENING.** After the Lake is open, all watercraft must be launched from a NTMWD approved ramp or a dock. This excludes non-motorized watercraft such as kayaks, canoes, and stand up paddle boards. Unless otherwise approved, neither Lessee nor individual lot owner may build a boat ramp or use any of their property to launch a watercraft except as set forth herein.
36. **PROPERTY LINE AND SIDE YARD LINE DELINEATION.** For this Agreement, Lessee will delineate the boundary line between the NTMWD-owned property and Lessee's property in a visibly clear, but unobtrusive manner approved by NTMWD and in accordance with the SMP. Lessee will also identify the intersection of the projected side yard line and the 534 MSL as depicted in the exhibits to this Agreement.
37. **PROHIBITED ITEMS.** Treated landscape timbers or the storage, transfer or use of hydrocarbons or other petrochemical products, paint, pesticides, herbicides, or any other toxic or hazardous materials are not allowed on the Leased Property.
38. **ELECTRICAL SAFETY AND COMPLIANCE.** Lessee shall comply with all applicable federal, state, county, municipal laws, ordinances, and regulations wherein the permitted facilities/activities are located, including, but not limited to, the provisions of the latest edition of the National Electrical Code (NEC). Failure to abide by these applicable laws and regulations may be cause for revocation of this Agreement.
39. **POLLUTION PREVENTION.** Within the limits of their respective legal powers, the Parties hereto shall protect the Leased Property against pollution of its air, ground, and water. Lessee shall promptly comply with any laws, regulations, conditions, or instructions affecting the activity hereby authorized if and when issued by the Environmental Protection Agency ("EPA"), USACE, Texas Commission on Environmental Quality ("TCEQ"), or any federal, state, or local governmental agency having jurisdiction to abate or prevent pollution. The disposal of any toxic or hazardous materials within the Leased Property is strictly prohibited. Such regulations, conditions, or instructions in effect or prescribed by

the said EPA, USACE, TCEQ, or any federal, state, or local governmental agency are hereby made a condition of this Agreement. Lessee shall not discharge waste or effluent from the Leased Property in such a manner that the discharge will contaminate streams or other bodies of water or otherwise become a public nuisance.

40. **PESTICIDES AND HERBICIDES.** The use of any pesticides or herbicides within the Leased Property shall be in conformance with all applicable federal, state, and local laws and regulations. Lessee must obtain approval in writing from NTMWD before any pesticides or herbicides are applied to the Leased Property.
41. **ENVIRONMENTAL IMPACT.** Lessee will use all reasonable means available to protect the environment and natural resources, and where damage nonetheless occurs arising from Lessee's activities, Lessee shall be liable to restore the damaged resources.
42. **TIMBER CLEARING.** No timber within the Leased Property above the 534 MSL contour shall be cleared. Standing timber below the 534 MSL contour may be cleared only if approved through this Shoreline Lease and Use Agreement. Lessee shall provide documentation of coordination with USACE in accordance with the procedures described in the SMP. Such USACE coordination shall only occur after NTMWD has reviewed the timber clearing proposal and provided direction to engage in such coordination. Any timber clearing authorized under this Agreement must be in compliance with any required USACE approvals, authorizations, or permits. Timber clearing shall be approved by NTMWD in writing and shall be in accordance with the Clean Water Act Section 404 Permit for Bois d'Arc Lake as provided in the SMP. Timber clearing not approved by NTMWD in writing is prohibited.
43. **CULTURAL RESOURCES.** Lessee shall not remove or disturb, or cause or permit to be removed or disturbed, any historical, archaeological, architectural, or other cultural artifacts, relics, remains, or objects of antiquity on NTMWD-owned property. In the event such items are discovered on the NTMWD-owned property, Lessee shall immediately notify NTMWD and protect the site and material from further disturbance until NTMWD authorizes any further activity.
44. **TERMINATION OF AGREEMENT.** Because the cost of the Improvements was made with the expectation that Lessee would have the benefit of the Leased Property for the full term of this Agreement, Lessee may only be terminated if the matters noticed in **Exhibit X** under the Violations and Penalty Provisions of this Agreement have not been cured in accordance with such provisions.
45. **IMPROVEMENT REMOVAL.** On or before the expiration or termination of this Agreement or if Lessee ceases to use, operate, or maintain an Improvement and/or use, Lessee shall, without expense to NTMWD, remove said Improvements and restore the waterway and lands to the satisfaction of NTMWD within thirty (30) days. In the event Lessee shall fail to remove said Improvements and restore the Leased Property, NTMWD shall have the option to take over said Improvements without compensation, or to remove said Improvements and perform the restoration at the expense of Lessee, and Lessee shall

have no claim for damages against NTMWD or its officers or agents for such action and no refund by NTMWD of any fee theretofore paid shall be made. Lessee agrees that if subsequent operations by NTMWD require an alteration in the location of an Improvement and/or use and if in the opinion of NTMWD an Improvement and/or use shall cause unreasonable obstruction to NTMWD use of the land or water area where the Improvement or use is located, Lessee shall be required, upon written notice from NTMWD, to remove, alter, or relocate the Improvement without expense to NTMWD.

46. **OTHER PERMITS REQUIRED.** This Agreement is effective only insofar as the rights of NTMWD in the Leased Property and Easement are concerned, and Lessee shall obtain such permission as may be required on account of any other existing rights. It is understood that the granting of this Agreement does not eliminate the necessity of obtaining any other permit or license that may be required by federal, state, or local statute in connection with use of the Leased Property, including, but not limited to, any permits or authorization from USACE to ensure compliance with the Clean Water Act.
47. **SANITATION.** Lessee shall take all necessary action and provide all necessary Improvements to maintain the Leased Property in a clean and sanitary manner, removing promptly and regularly trash and garbage from the said area. Any materials and refuse from construction, maintenance and repair activities are to be removed from the Leased Property immediately upon completion of such activities.
48. **LICENSED PROFESSIONAL ENGINEER REQUIRED.** NTMWD may require that remedial measures other than minor repairs and maintenance, and plans for same, be reviewed, designed, and sealed by a Texas Licensed Professional Engineer and approved by NTMWD.
49. **FINAL PLAT MAPS.** In the event final plat maps were not provided by Developer to NTMWD prior to the Effective Date, Lessee shall be required to provide NTMWD with all final plat maps and specifications within thirty (30) days of such maps and specifications being finalized.
50. **SEVERABILITY.** In case any one or more of the provisions contained in this Agreement shall for any reason be held to be invalid, illegal, or unenforceable in any respect, such invalidity, illegality, or unenforceability shall not affect any other provision thereof and this Agreement shall be considered as if such invalid, illegal, or unenforceable provision had never been contained in this Agreement.
51. **NO JOINT VENTURE.** It is acknowledged and agreed by the Parties that the terms hereof are not intended to and shall not be deemed to create any partnership or joint venture among the Parties. NTMWD, its past, present, and future officers, elected officials, employees and agents of NTMWD, do not assume any responsibilities or liabilities to any third party in connection with the improvements to, or use of, the Leased Property.
52. **REPRESENTATIONS AND WARRANTIES.** Each Party represents and warrants to the other Party that (i) the Party has full requisite power and authority to perform its obligations

under this Agreement; (ii) the execution, delivery, and performance of this Agreement has been duly authorized by all necessary action of the board of directors or other applicable governing body of the Party; (iii) this Agreement is a valid and binding obligation of the Party enforceable against the Party in accordance with its terms, except as the enforceability may be limited by applicable bankruptcy, insolvency or other law affecting creditors' rights generally, and by general equitable principles; and (iv) the execution, delivery, and performance of this Agreement by the Party does not, and will not: (A) violate the statute, charter, or other instrument pursuant to which the Party was created; (B) violate the Constitution of the State of Texas, or any other law, rule or regulation by which the Party is bound; (C) violate any judgment, writ, order, injunction, award, or decree of any court, arbitrator, administrative agency or other governmental authority which is binding upon the Party; or (D) result in a material breach, violation, or default under any indenture, mortgage, ordinance, bond resolution, contract, deed of trust, debenture, agreement, or other instrument to which the Party is a party.

53. **ENTIRE AGREEMENT – NO ORAL MODIFICATIONS.** This Agreement embodies the entire Agreement of the Parties, superseding all oral or written previous and contemporary agreements between the Parties relating to matters set forth in this Agreement. Except as otherwise provided elsewhere in this Agreement, this Agreement cannot be modified without a written agreement executed by both Parties.
54. **NO THIRD PARTY BENEFICIARIES.** Lessee and NTMWD enter into this Agreement solely for the benefit of themselves and agree that nothing in this Agreement shall be construed to confer any right, privilege, or benefit on any person or entity other than Lessee and NTMWD.
55. **VENUE.** It is specifically agreed among the Parties to this Agreement that Fannin County, Texas, is the place of performance of this Agreement; and, in the event that any legal proceeding is brought to enforce this Agreement or any provision hereof, the same shall be brought in Fannin County, Texas.
56. **ADOPTION OF PREAMBLE AND EXHIBITS.** All of the statements in the preamble and all of the exhibits of this Agreement are true and correct and are hereby incorporated into the body of this Agreement as though fully set forth in their entirety herein.

SPECIAL CONDITIONS *(To be completed for each project)*

VIOLATIONS AND PENALTIES

1. Lessees will be held accountable to the conditions outlined herein. If a violation is identified, NTMWD will follow the steps outlined below:

First Notice: NTMWD will generally issue a written warning notifying Lessee of the violation, outlining actions to correct the violation, and providing a resolution timeframe. Depending on the non-compliance issue (e.g. is the issue an imminent health or safety concern), the time provided for resolution and the degree to which NTMWD may step in and proactively correct an issue may vary. Some violations may immediately generate a fine. NTMWD may, at its discretion, waive fines to be imposed at the first notice. NTMWD

will follow up within the specified timeframe to document resolution of the issue. Increased frequency of monitoring and inspection may be warranted for a period of time following resolution.

Second Notice: A second notice may involve the same activity or conditions as the first notice, or it may be a new issue. Second notices for the same situation that triggered the first notice will also be linked to increased fines and shorter resolution timeframes. Lessees will be required to reimburse NTMWD for costs associated with monitoring, inspection, and follow-up for second notice actions.

Third Notice: Three notices for the same or different instances of non-compliance with this Agreement within one year will trigger a notice to revoke or terminate this Agreement. Lessee will have thirty (30) days to remove Improvements at his or her expense and restore the Leased Property to its condition prior to the construction of the Improvements (if applicable). Lessee may appeal a notice of termination to NTMWD within fifteen (15) days of receiving the notice. NTMWD will respond to Lessee within thirty (30) days.

2. Resolution timeframes and fines are dependent on the harm that may occur to people, property, and resources if the violation were to continue. Violations that are hazardous, or potentially hazardous, generally have shorter resolution timeframes and higher penalties than administrative violations. **Exhibit X** outlines resolution timeframes, remedies, and penalties for various violations.

EFFECTIVE DATE AND TERM

This Agreement becomes effective on the date this Agreement is signed by both Parties (the "Effective Date") and will be valid for five years after the date of the latest signature. This Agreement will expire on _____.

AUTHORIZATION

This Agreement authorizes the lease and use of NTMWD-owned property described herein. If Lessee implements a project that differs from the Project described herein, Lessee will be subject to penalties and fines described in this Agreement, and potentially termination.

EXECUTION

The Parties hereto acting under authority of their respective governing bodies have caused this Agreement to be duly executed in several counterparts, each of which shall constitute an original.

[The remainder of this page is intentionally left blank. Signatures are on the following pages.]

LESSEE: XXXXXXXXX

By: _____
 INSERT NAME, TITLE _____ Date _____

STATE OF TEXAS §
 §
COUNTY OF **INSERT** §

This instrument was acknowledged before me on this _____ day of _____, 202__,
by **INSERT NAME, TITLE of LESSEE.**

Notary Public, State of Texas
Printed Name of Notary:

My Commission Expires: _____

LESSEE: ASSOCIATION

By: _____
 INSERT NAME, TITLE _____ Date _____

STATE OF TEXAS §
 §
COUNTY OF **INSERT** §

This instrument was acknowledged before me on this _____ day of _____, 202__,
by **INSERT NAME, TITLE of LESSEE.**

Notary Public, State of Texas
Printed Name of Notary:

My Commission Expires: _____

NORTH TEXAS MUNICIPAL WATER DISTRICT

By: _____ Date _____
 INSERT NAME, TITLE

STATE OF TEXAS §
 §
COUNTY OF COLLIN §

This instrument was acknowledged before me on this _____ day of _____, 202__,
by **INSERT NAME, TITLE** of North Texas Municipal Water District, a conservation and
reclamation district and political subdivision of the State of Texas, on behalf of said conservation
and reclamation district.

Notary Public, State of Texas
Printed Name of Notary:

My Commission Expires: _____

EXHIBIT C

Agreement Fees and Remedies and Penalties for Violations

DRAFT

Agreement Fee Schedule

Agreement Type	Activity/Facility	Application Fee (\$)	Annual Fee	Incentives/Additional Information
Preliminary Development Agreement	Community and Shared Dock/Overwater Structures	Application/ First Year: \$75,720	For years 2 through 5 of a 5-year agreement: \$7,800	<p>All shoreline use activities/facilities will be combined on one permit. Only the higher fee identified will be assessed.</p> <p>If erosion control or stormwater runoff treatment BMPs are provided supplementary to any required erosion control; an incentive reduction of 50 percent of the annual fee may be applied.</p>
Preliminary Development Agreement	Modification fee	25-100 percent of the original application fee	N/A	

Remedies and Penalties for Violations

Violation ¹	Violation Category ²	Remedy ²	Resolution Timeframe (days) <i>First Notice</i> ²	Resolution Timeframe (days) <i>Second Notice</i> ²	Fine (\$) <i>First Notice</i> ²	Fine (\$) <i>Second and Third Notices</i> ²
Unauthorized burning	Major	Immediately stop unauthorized burning and remove debris from NTMWD-owned property	1	N/A	\$200	N/A
Storage or placement of fuel, oil, treated landscape timbers, pesticides, or other hazardous materials on docks or NTMWD-owned property	Major	Remove hazardous materials from NTMWD-owned property and store in secure location on private property	5	1	N/A	\$200
Unauthorized use of pesticides/fertilizers on leased property	Major	Stop unauthorized use of pesticides and report changes in water quality (e.g., algal blooms and/or dead fish) to NTMWD	1	N/A	\$200	N/A

Violation ¹	Violation Category ²	Remedy ²	Resolution Timeframe (days) First Notice ²	Resolution Timeframe (days) Second Notice ²	Fine (\$) First Notice ²	Fine (\$) Second and Third Notices ²
Unauthorized placement or storage of personal property on NTMWD-owned property and/or water	Major	Remove personal property from NTMWD-owned property and store in a secure location on private property	5	1	N/A	\$200
Unauthorized use of private overwater facility (e.g., human habitation on boat dock, storing nonauthorized vessels or watercraft at an approved boat dock, subletting boat dock)	Major	Stop unauthorized use and restore facility to post-violation conditions (e.g., remove evidence of human habitation from boat dock)	5	3	200	\$200
Unauthorized dock structure or dock modification	Major	Stop construction (if applicable) and restore facility to pre-violation conditions	15	3	200	\$200
Unauthorized vegetation modification (e.g., removing vegetation outside of an authorized area, changing landform, planting unauthorized plants)	Major	Stop violation and restore to pre-violation conditions (e.g., replant with authorized native plant species)	30	5	200	\$200

Violation ¹	Violation Category ²	Remedy ²	Resolution Timeframe (days) First Notice ²	Resolution Timeframe (days) Second Notice ²	Fine (\$) First Notice ²	Fine (\$) Second and Third Notices ²
Deviation from approved dock construction plans (e.g., construction materials, anchoring methods, etc.)	Major	Reconstruct dock to conform to approved construction plans	30	5	N/A	\$200
Unauthorized access path construction	Major	Stop construction and restore area to pre-violation conditions	15	5	200	\$200
Emerging erosion issues (signs may include shoreline recession, increased water turbidity and discoloration in the surrounding area, bare soil, exposed plant roots, and unstable banks)	Major	Stop erosion producing activity and install erosion control device and/or plant native vegetation	30	5	200	\$200
Unauthorized use of a mobility assistance vehicle	Major	Stop unauthorized use, restore area to pre-violation conditions (if applicable)	15	3	N/A	\$200
Failure to delineate the NTMWD boundary line	Moderate	Delineate and mark the NTMWD boundary line using methods approved in the Shoreline Management Plan	15	10	N/A	\$200

Violation ¹	Violation Category ²	Remedy ²	Resolution Timeframe (days) <i>First Notice</i> ²	Resolution Timeframe (days) <i>Second Notice</i> ²	Fine (\$) <i>First Notice</i> ²	Fine (\$) <i>Second and Third Notices</i> ²
Failure to restore the leased area after completion of a permitted activity or after the lessee damages the area	Moderate	Restore area to pre-lease conditions (e.g., restore vegetation, install erosion control measures such as water bars and vegetated swales)	30	15	N/A	\$85/day
Failure of POA or developer to apply for shoreline use agreement for existing uses within 30 days or to restore the use area within 60 days from the date of ownership transfer	Moderate	Apply for a new shoreline lease and use agreement or restore the use area	30	15	N/A	\$85/day
Failure to display agreement tags on authorized facilities	Minor	Display agreement tags according to agreement conditions and Shoreline Management Plan requirements	30	15	N/A	\$150/week
Failure to have a copy of the agreement with the mobility assistance vehicle during use on NTMWD-owned property	Minor	Carry agreement according to authorization conditions	1	1	N/A	\$150

Violation ¹	Violation Category ²	Remedy ²	Resolution Timeframe (days) <i>First Notice</i> ²	Resolution Timeframe (days) <i>Second Notice</i> ²	Fine (\$) <i>First Notice</i> ²	Fine (\$) <i>Second and Third Notices</i> ²
Failure to pay agreement fees	Minor	Pay outstanding agreement fee	30	15	N/A	\$150/week
Failure to renew an agreement	Minor	Apply for a new agreement and pay associated application fees	30	1	N/A	\$150/week
Failure to complete construction within allowed time limit	Minor	Apply for new agreement and pay associated application fees	0	15	N/A	\$150/week
Noncompliance with applicable laws, ordinances, and regulations	NA	NTMWD reports violations to the appropriate authority for enforcement	Depends on law/regulation	Depends on law/regulation	Depends on law/regulation	Depends on law/regulation

¹Penalties may be assessed individually for discrete facilities and occurrences

²NTMWD = North Tarrant Municipal Water District; N/A = not applicable; SMP = Shoreline Management Plan